BRUCE BEACH PARK

PHASE ONE ISSUE FOR BID

CITY OF PENSACOLA | ESCAMBIA COUNTY FLORIDA



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25 W. Cedar Street, Suite 200 Pensacola, FL 32502



BRUCE BEACH PARK 601 W. Main Street Pensacola, FL 32502

PHASE ONE


DATE	DESCRIPTION
9/10/2021	30% DESIGN DEVELOPMENT
11/5/2021	60% DESIGN DEVELOPMENT
3/4/2022	DRAFT 100% PERMIT SUBMITTAL
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IDR Project N	umber: 10279441

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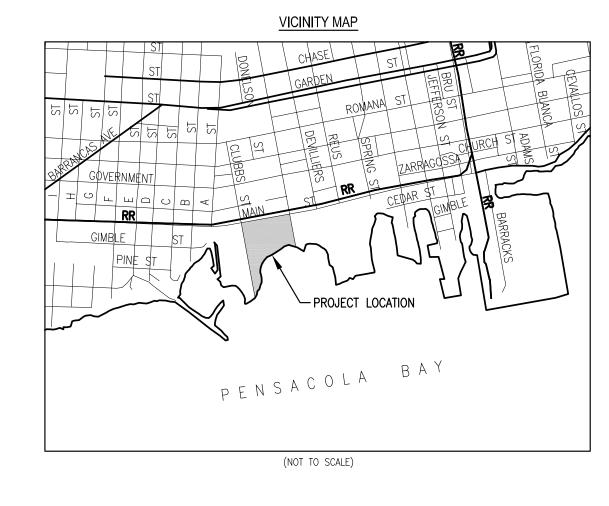
COVER

CVR-1

BOUNDARY & TOPOGRAPHIC SURVEY

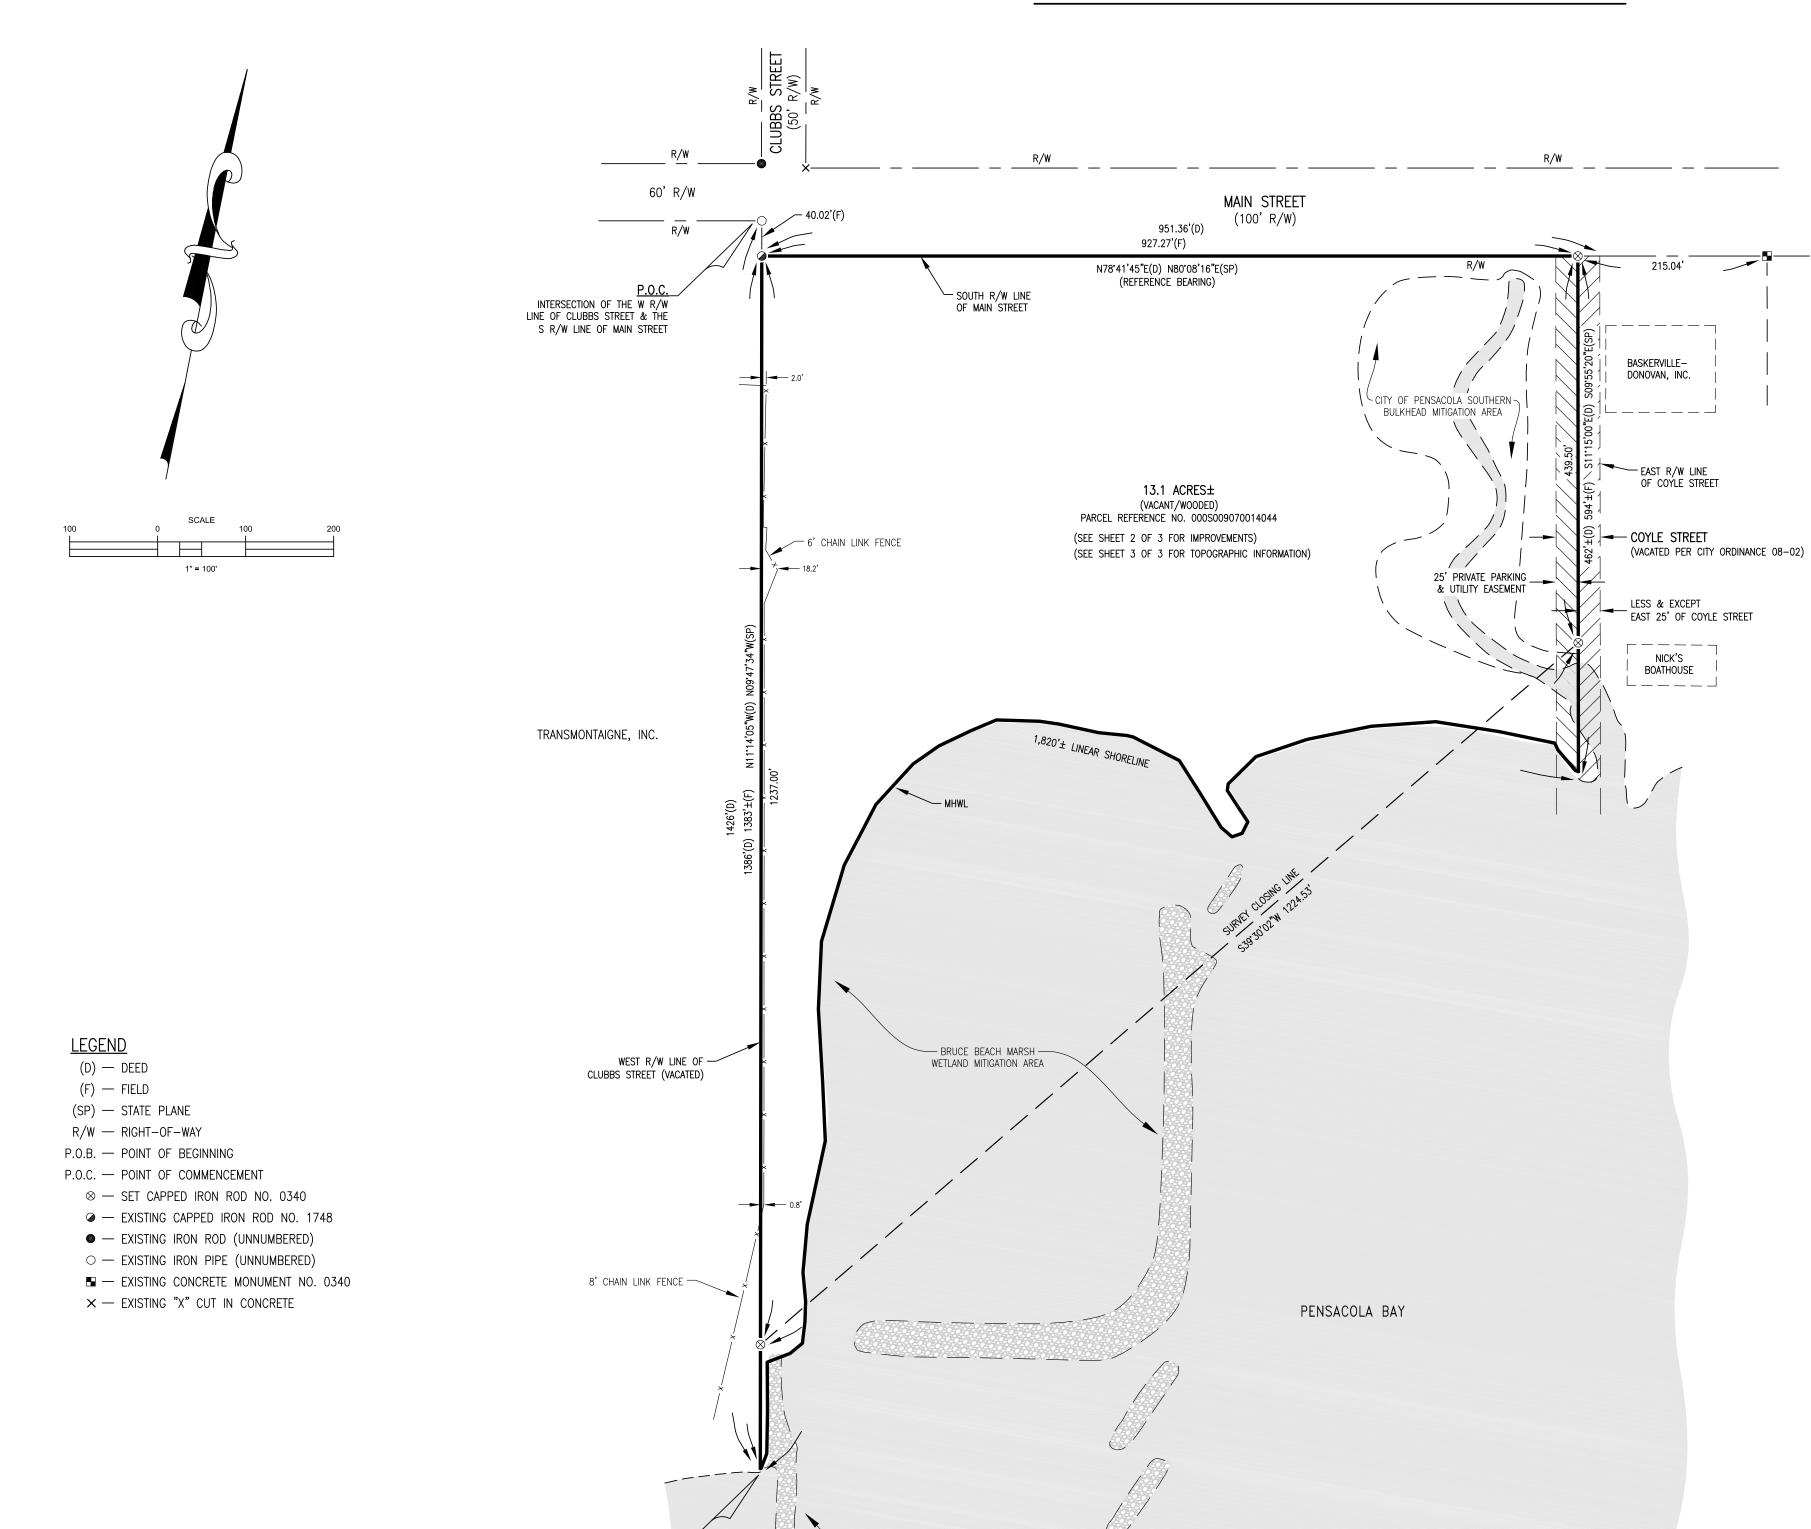

COMMUNITY MARITIME PARK (CMP) WETLAND MITIGATION AREA



(AS FURNISHED)

THAT PORTION OF THE WATERFRONT TRACT AND DONELSON TRACT, LYING EAST OF THE WEST RIGHT OF WAY OF CLUBBS STREET (50' R/W), SOUTH OF MAIN STREET (100' R/W), AND WEST OF THE EAST RIGHT OF WAY COYLE STREET (50' R/W), ACCORDING TO THE MAP OF PENSACOLA COPYRIGHTED BY THOMAS C. WATSON IN 1906 AND BEING MÒRE PARTICULARLY DESCRIBED AS FOLLOWS:

SOUTH RIGHT OF WAY LINE OF MAIN STREET (60' R/W); THENCE S 11"14'05" E ALONG SAID WEST RIGHT OF WAY LINE FOR A DISTANCE OF 1426 FEET, MORE OR LESS, TO THE MEAN HIGH WATER LINE OF PENSACOLA BAY FOR THE POINT OF BEGINNING; THENCE N 11°14'05" W ALONG SAID WEST RIGHT OF WAY LINE FOR A DISTANCE 78'41'45" E ALONG SAID SOUTH RIGHT OF WAY LINE FOR A DISTANCE OF 951.36 FEET TO THE EAST RIGHT OF WAY LINE OF COYLE STREET (50' R/W); THENCE S 11°15'00" E ALONG SAID EAST RIGHT OF WAY LINE FOR A DISTANCE OF 462 FEET, MORE OR LESS TO THE MEAN HIGHWATER LINE OF PENSACOLA BAY; THENCE SOUTHWESTERLY MEANDERING ALONG SAID MEAN HIGHWATER LINE TO THE POINT OF BEGINNING.

LESS & EXCEPT THE EAST 25' OF COYLE STREET (50' VACATED R/W).

GENERAL NOTES:

- 1. NORTH AND THE SURVEY DATUM SHOWN HEREON IS BASED ON A PREVIOUS SURVEY BY FABRE ENGINEERING, JOB NO. 000004-04-S02, DATED 9/10/01, A PREVIOUS SURVEY BY BASKERVILLE-DONOVAN, PROJECT NO. 67201.01, DATED 3/29/04, DEEDS OF RECORD, EXISTING FIELD MONUMENTATION AND THE FLORIDA STATE PLANE COORDINATE SYSTEM, FLORIDA NORTH ZONE (NAD83).
- 2. NO TITLE SEARCH, TITLE OPINION, OR ABSTRACT WAS PERFORMED BY NOR PROVIDED TO THIS FIRM FOR THE SUBJECT PROPERTY. THERE MAY BE DEEDS OF RECORD, UNRECORDED DEEDS, EASEMENTS, RIGHTS-OF-WAY, BUILDING SETBACKS, RESTRICTIVE COVENANTS OR OTHER INSTRUMENTS WHICH COULD AFFECT THE BOUNDARIES OR USE OF THE SUBJECT PROPERTY.
- 3. IMPROVEMENTS AND VISIBLE UTILITIES ARE AS SHOWN HEREON.
- 4. ENCROACHMENTS ARE AS SHOWN HEREON.
- 5. THE ELEVATIONS SHOWN HEREON ARE RELATIVE TO THE NORTH AMERICAN VERTICAL DATUM OF 1988 (NAVD88).
- 6. THE FIELD SURVEY WAS PERFORMED JANUARY, 2021 AND RECORDED IN FIELD BOOK 20-04, PAGES 63-70.
- 7. THE BOUNDARY AND TOPOGRAPHIC SURVEY SHOWN HEREON WAS ORIGINALLY PREPARED ON DECEMBER 17,

SURVEYOR'S CERTIFICATION:

THE SURVEY SHOWN HEREON WAS PREPARED IN COMPLIANCE WITH THE STANDARDS OF PRACTICE SET FORTH BY THE FLORIDA BOARD OF PROFESSIONAL LAND SURVEYORS AND MAPPERS IN CHAPTER 5J-17 OF THE FLORIDA ADMINISTRATIVE CODE, PURSUANT TO SECTION 472.027 FLORIDA STATUTES TO THE BEST OF MY KNOWLEDGE AND

FOR: BASKERVILLE-DONOVAN INC. CORPORATE NUMBER 0340


> Fosut S. mill ROBERT SCOTT MILLS FLORIDA REGISTRATION NO. 5509

NO. 5509

2/17/21

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SURVEY TOPOGRAPHIC ళ



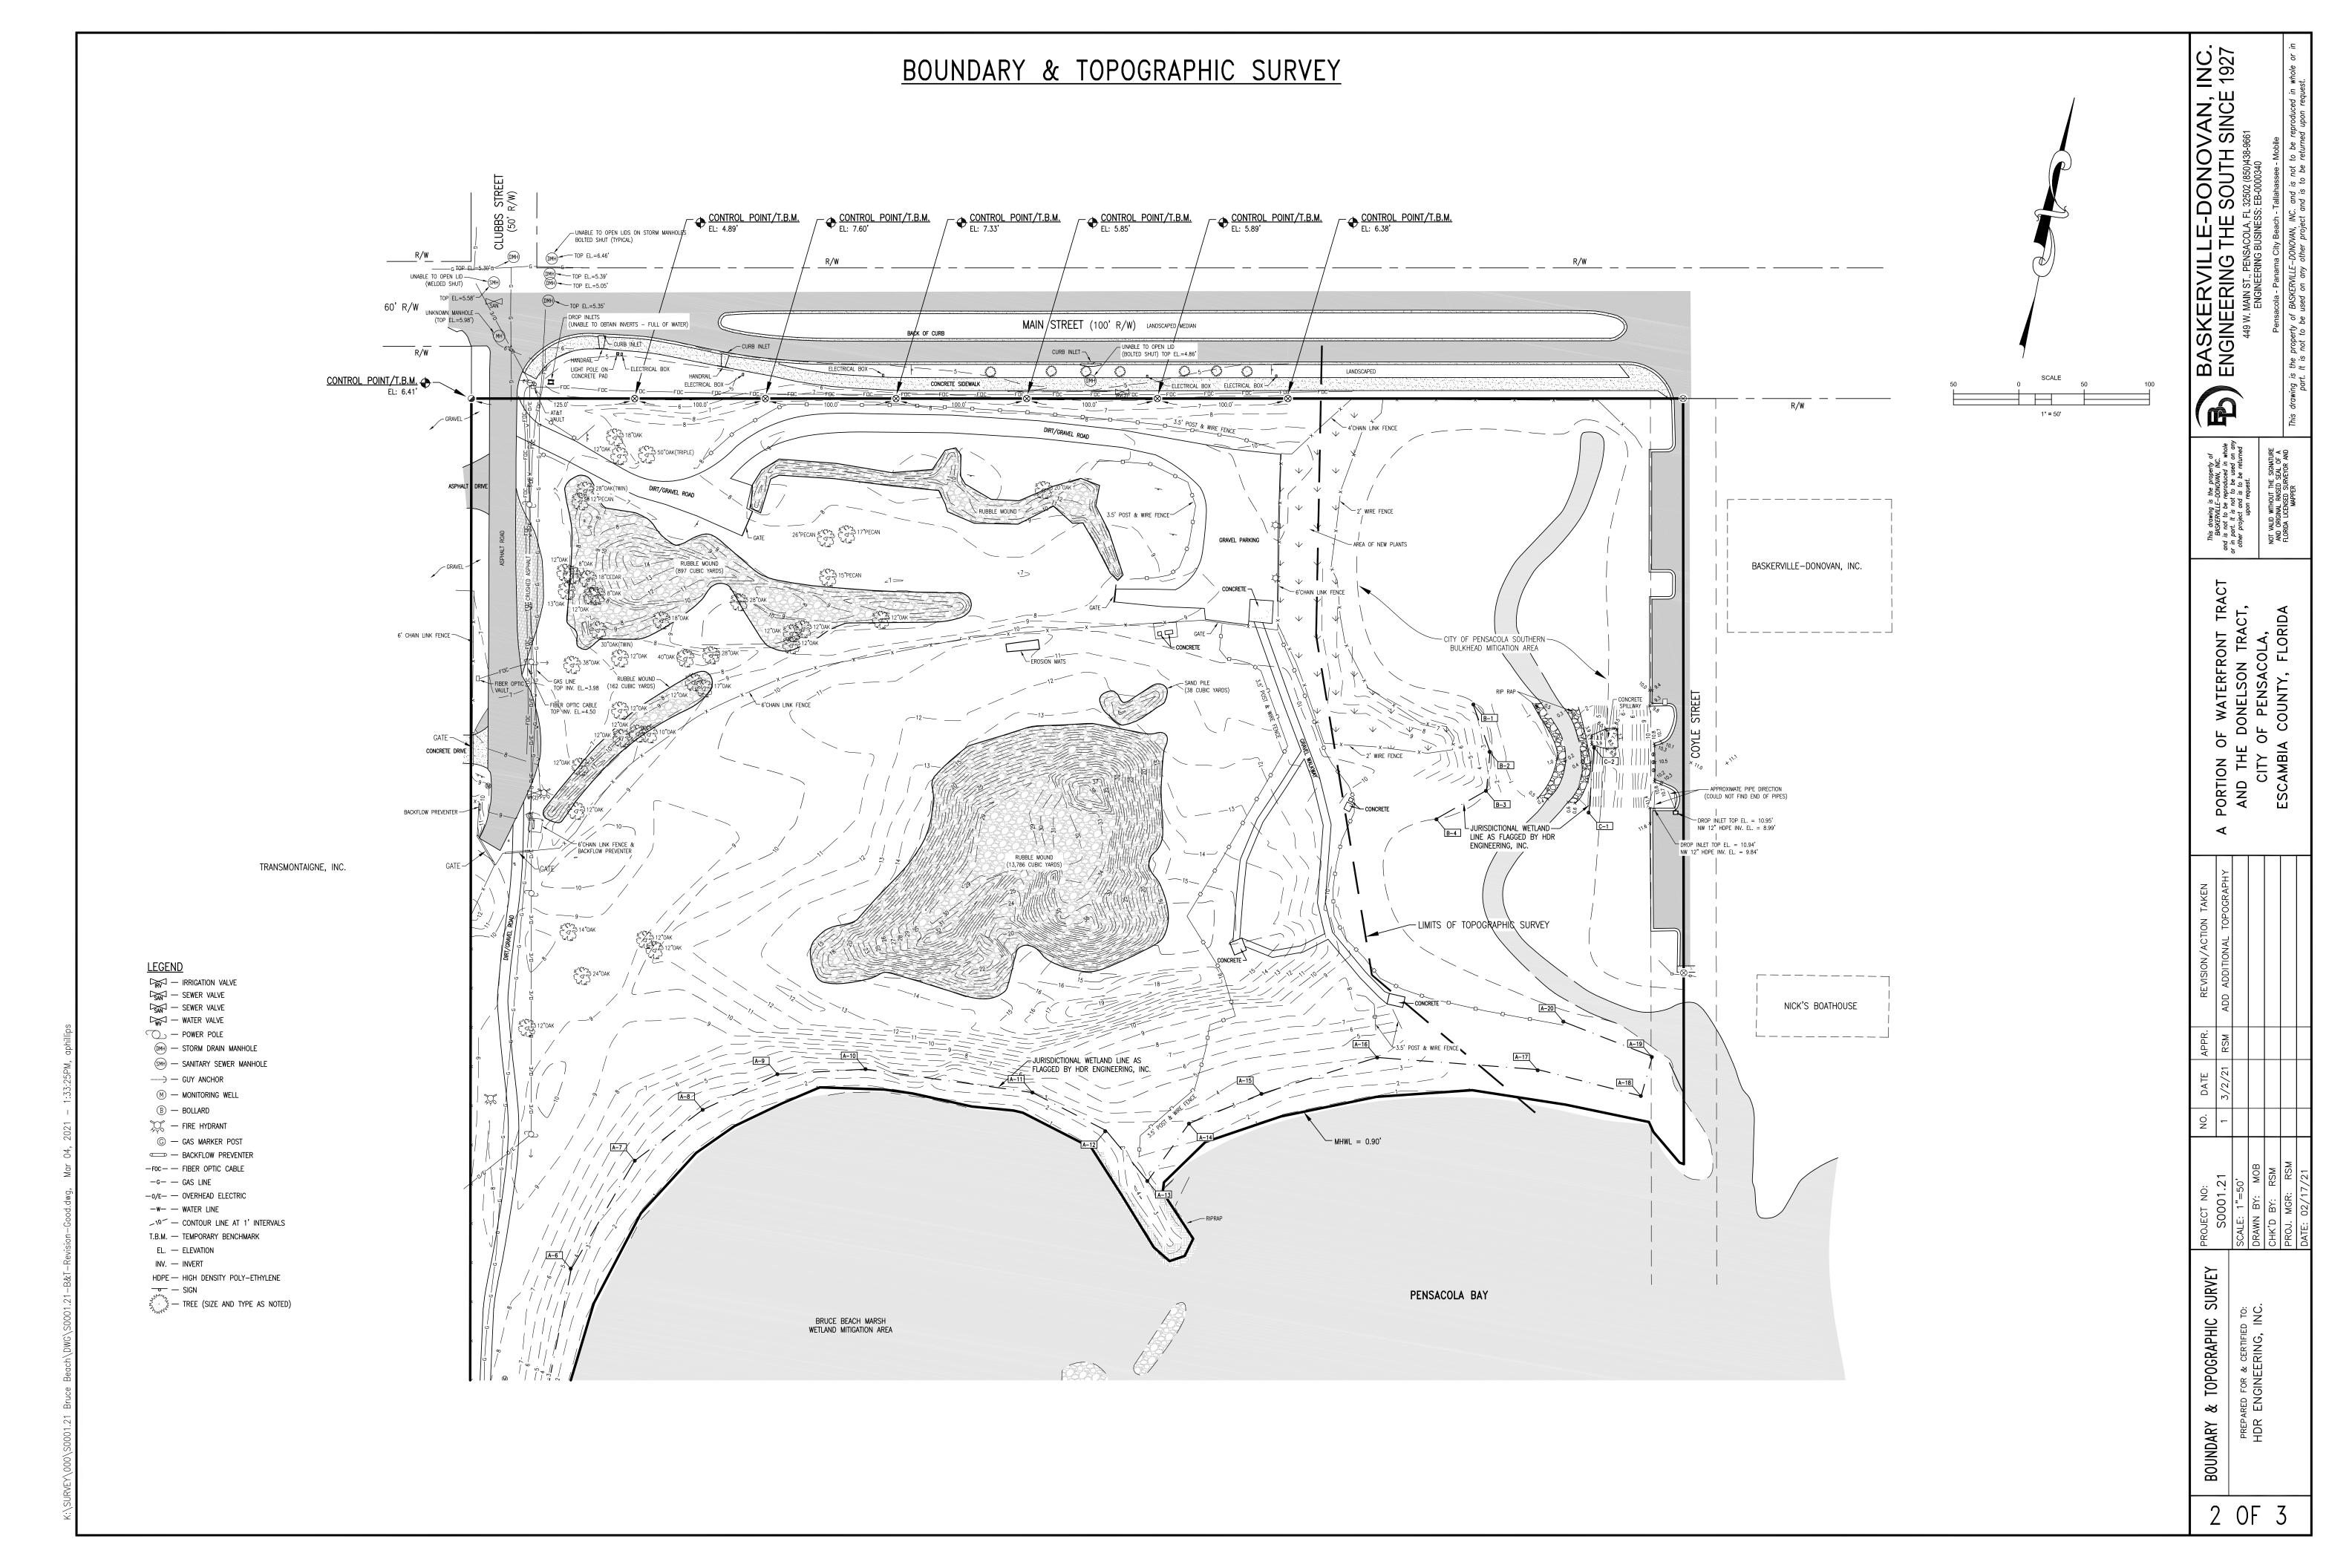

GENERAL NOTES

- ANY DEVIATIONS FROM THE APPROVED PLANS WILL REQUIRE APPROVAL FROM BOTH THE PROJECT ENGINEER/ARCHITECT AND THE CITY OF PENSACOLA.
- 2. CONTRACTOR SHALL VERIFY ACCEPTABLE DAYS OF THE WEEK AND HOURS OF THE DAY FOR WORKING WITH THE CITY OF PENSACOLA.
- 3. EQUIPMENT AND MATERIALS SHALL BE STORED IN AREAS DESIGNATED BY THE CITY. CONSTRUCTION AND STORAGE AREAS SHALL BE KEPT NEAT AND CLEAN AT ALL TIMES.
- 4. ALL CONSTRUCTION VEHICLES SHALL PARK IN AREAS DESIGNATED BY THE OWNER.
- 5. NO SITE WORK ACTIVITIES SHALL TAKE PLACE WITHOUT CITY SITE REVIEW/APPROVAL OF PROPOSED EROSION CONTROL MEASURES AND ADVANCED NOTIFICATION OF THE REQUESTED INSPECTION IS REQUIRED.
- 6. MINIMUM EROSION CONTROL BEST PRACTICES (SILT FENCE AND ROCK CONSTRUCTION AT ENTRANCES) MUST BE INSTALLED PRIOR TO CONSTRUCTION PER CITY STANDARDS, AND MUST BE MAINTAINED THROUGHOUT PROJECT CONSTRUCTION.
- 7. NECESSARY BARRICADES, SUFFICIENT LIGHTS, SIGNS AND OTHER TRAFFIC CONTROL DEVICES AS MAY BE NECESSARY FOR THE PROTECTION AND SAFETY OF THE PUBLIC SHALL BE PROVIDED IN ACCORDANCE WITH THE MANUAL ON UNIFORM TRAFFIC CONTROL DEVICES, 1988 EDITION AND MAINTAINED WHEN WORKING IN CLOSE PROXIMITY TO PUBLIC ROADS.
- 8. ALL WASTE FROM DEMOLITION OPERATIONS SHALL BE HAULED OFFSITE AND DISPOSED OF LEGALLY.
- 9. SIGNING AND STRIPING TO BE PROVIDED BY THE CONTRACTOR ACCORDING TO THE MANUAL ON UNIFORM TRAFFIC CONTROL DEVICES, 2009 EDITION WITH ALL REVISIONS INCLUDED.
- 10. ALL TEMPORARY STRIPING & SIGNAGE NECESSARY TO MAINTAIN SAFE VEHICULAR AND PEDESTRIAN TRAFFIC FLOW DURING CONSTRUCTION IS TO BE FURNISHED, INSTALLED & MAINTAINED BY THE CONTRACTOR.
- 11. UPON DISCOVERING ANY DISCREPANCIES BETWEEN THE ARCHITECTURAL AND THE ENGINEERING PLANS, CONTRACTOR TO STOP WORK IMMEDIATELY AND NOTIFY THE ARCHITECT.

- 12. CONTRACTOR IS CAUTIONED ABOUT THE PRESENCE OF UNDERGROUND UTILITIES AT OR NEAR THE PROPOSED IMPROVEMENTS THROUGHOUT THIS PROJECT.
- 13. CONTRACTOR SHALL VERIFY THE PRESENCE OF SUCH UTILITIES PRIOR TO EXCAVATION. ANY ACTION SUCH AS ABANDONMENT OR RELOCATION OF THE UTILITIES MUST BE COORDINATED WITH THE OWNER AND THE AFFECTED UTILITY COMPANY. ANY DISTURBANCE OF EXISTING APPURTENANCES WILL BE COORDINATED WITH THE RESPECTIVE UTILITY COMPANY.
- 14. THE CONTRACTOR SHALL EXERCISE EXTREME CAUTION WHEN ENTERING MANHOLES, PIPES OR OTHER STRUCTURES SHOWN ON THE PLANS. AT A MINIMUM, THESE PIPES AND STRUCTURES SHALL BE PROPERLY VENTILATED.
- 15. CONTRACTOR IS RESPONSIBLE FOR VERIFYING ALL DIMENSIONS SHOWN ON THE PLANS FOR ALL STRUCTURES AS WELL AS ALL UTILITY LOCATIONS WITH CURRENT ARCHITECTURAL, STRUCTURAL, AND PLUMBING PLANS AND ENSURING THERE ARE NO CONFLICTS; AND SHALL PROMPTLY NOTIFY THE LANDSCAPE ARCHITECT OF ANY DISCREPANCIES.
- 16. DIMENSIONS ARE TO FACE OF CURB, CENTER OF STRUCTURE AND CENTER LINE OF COLUMN/WALL LINE, UNLESS OTHERWISE NOTED. ANGLES SHOWN ON STORM AND SANITARY SEWER ARE TO CENTER OF PIPE, UNLESS OTHERWISE NOTED.
- 17. ALL CURB AND GUTTER, SIDEWALKS, AND ACCESSIBILITY RAMPS SHALL BE A MINIMUM OF 3000 PSI CONCRETE AT 28 DAYS WITH FIBERMESH.
- 18. ALL EXISTING MANHOLE COVERS, METER BOXES & OTHER UTILITY APPURTENANCES LOCATED WITHIN THE LIMITS OF WORK SHALL BE ADJUSTED SO THAT THEIR TOP SURFACES WILL BE FLUSH WITH NEW PAVEMENT FINISHED GRADE. THIS ALSO APPLIES TO APPURTENANCES IN EXISTING PAVED AREAS THAT ARE TO BE RETAINED AS EXISTING.
- 19. ALL FILL PLACED AS A PART OF THIS PROJECT SHALL BE PLACED IN ACCORDANCE WITH THE PROJECT SPECIFICATIONS.
- 20. ALL SUBGRADE SOILS UNDER AREAS TO RECEIVE PAVEMENT OR FOOTINGS ARE TO BE COMPACTED TO 95% STANDARD PROCTOR.

- 21. ALL SIDEWALKS AND DRIVEWAYS MUST BE BUILT TO THE LATEST EDITION OF ADA STANDARDS AND GUIDELINES, DESIGN STANDARDS AND PROWAG.
- 22. AFTER ALL NEW CONSTRUCTION ARE COMPLETED CONTRACTOR SHALL PRESSURE WASH AREAS WITHIN
- 23. DAMAGE TO ADJACENT ROADS, WALKS AND OTHER EXISTING FACILITIES CAUSED BY CONTRACTORS OPERATIONS SHALL BE REPAIRED BY THE CONTRACTOR AT NO COST TO THE OWNER.



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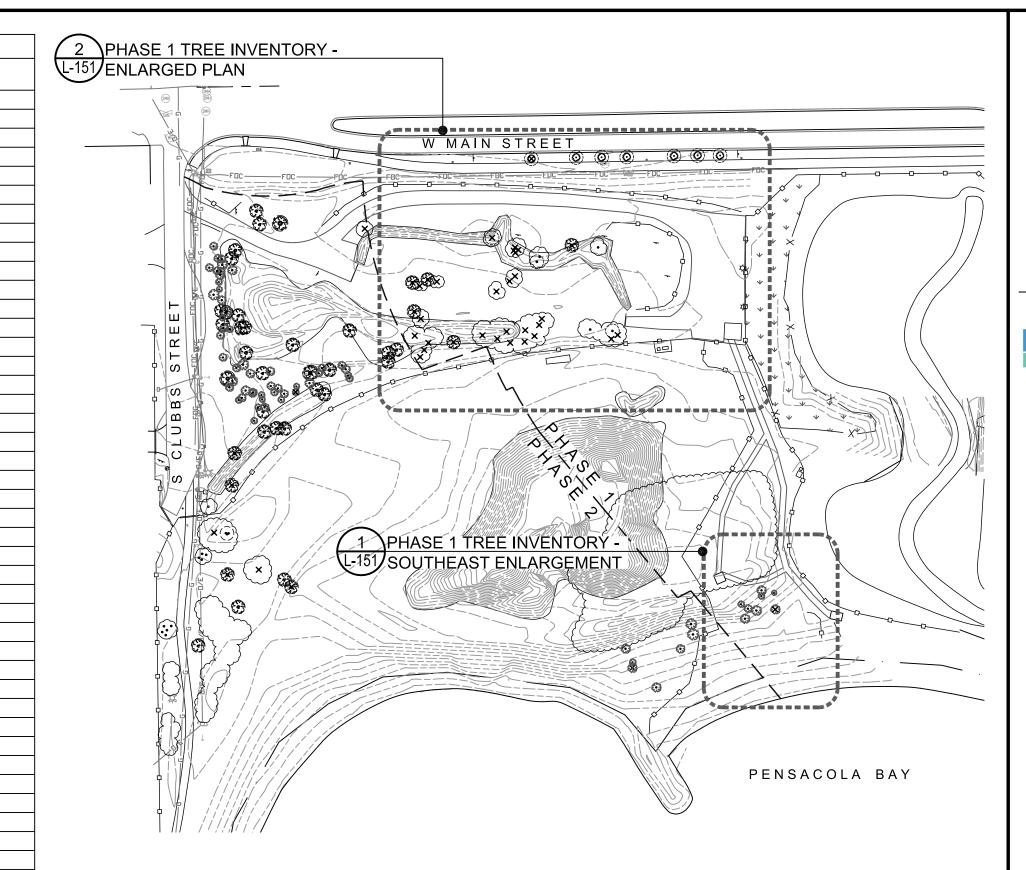
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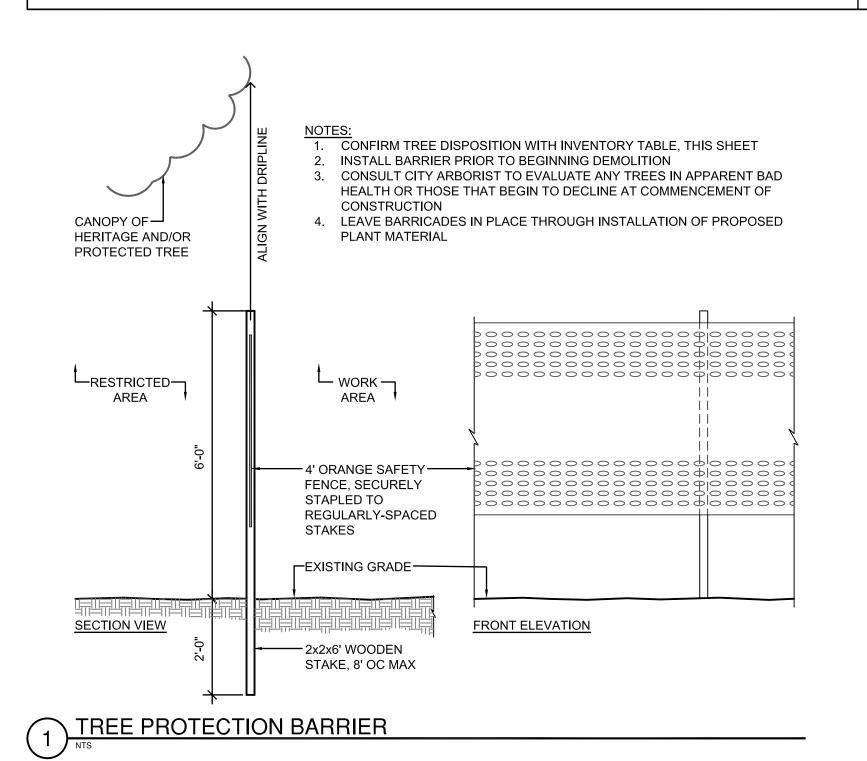
GENERAL NOTES

,11	00151:5:5	BRUCE BEAG						Duran	
#	SCIENTIFIC	COMMON		PROTECTED	HERITAGE	INVASIVE	REMOVED		NOTES
1	QUERCUS SPP	OAK	18	X				2	
2	QUERCUS SPP	OAK	12	Х				2	
3 4	SABAL PALMETTO QUERCUS SPP	CABBAGE PALM OAK	12 50	Х	Х			2 2	
5	SABAL PALMETTO	CABBAGE PALM	5	**			х	2	
6	SABAL PALMETTO	CABBAGE PALM	12					2	
7	SABAL PALMETTO	CABBAGE PALM	12					2	
8	SABAL PALMETTO	CABBAGE PALM	15					2	
9	SABAL PALMETTO	CABBAGE PALM	12					2	
10 11	SABAL PALMETTO SABAL PALMETTO	CABBAGE PALM CABBAGE PALM	12 14					2	
11 12	SABAL PALMETTO	CABBAGE PALM	10					2	
13	QUERCUS SPP	OAK	16	х				2	
14	SABAL PALMETTO	CABBAGE PALM	13					2	
15	SABAL PALMETTO	CABBAGE PALM	8					2	
16	QUERCUS SPP	OAK	16	Х				2	
17	SABAL PALMETTO	CABBAGE PALM	9	v				2	
18 19	QUERCUS SPP SABAL PALMETTO	OAK CABBAGE PALM	13 12	Х				2	
20	SABAL PALMETTO	CABBAGE PALM	12					2	
<u></u> 21	QUERCUS SPP	OAK	28	Х				2	TWIN
22	CARYA ILLINOENSIS	PECAN	12	х				2	
23	SABAL PALMETTO	CABBAGE PALM	14					2	
24	SABAL PALMETTO	CABBAGE PALM	12					2	
25 26	SABAL PALMETTO	CABBAGE PALM	9					2	
26 27	SABAL PALMETTO	CABBAGE PALM CEDAR	16 18	Х				2	
21 28	SABAL PALMETTO	CABBAGE PALM	10					2	
<u>20</u> 29	QUERCUS SPP	OAK	8	Х				2	
	QUERCUS SPP	OAK	12	х				2	
31	QUERCUS SPP	OAK	30	Х				2	TWIN
32	SABAL PALMETTO	CABBAGE PALM	16					2	
33 34	SABAL PALMETTO	CABBAGE PALM	13					2	
34 35	SABAL PALMETTO SABAL PALMETTO	CABBAGE PALM CABBAGE PALM	12 13					2	
36	QUERCUS SPP	OAK	38	Х	Х			2	
37	SABAL PALMETTO	CABBAGE PALM	15					2	
38	SABAL PALMETTO	CABBAGE PALM	12					2	
39	SABAL PALMETTO	CABBAGE PALM	14					2	
40	SABAL PALMETTO	CABBAGE PALM	12					2	
41	SABAL PALMETTO	CABBAGE PALM	10					2	
42 43	SABAL PALMETTO SABAL PALMETTO	CABBAGE PALM CABBAGE PALM	12 12					2	
44	SABAL PALMETTO	CABBAGE PALM	10					2	
45	SABAL PALMETTO	CABBAGE PALM	9					2	
46	SABAL PALMETTO	CABBAGE PALM	10					2	
47	SABAL PALMETTO	CABBAGE PALM	10					2	
48	QUERCUS SPP	OAK	12	X				2	
49 50	QUERCUS SPP	OAK	12	X				2	
50 51	QUERCUS SPP SABAL PALMETTO	OAK CABBAGE PALM	12 13	Х				2	
52	QUERCUS SPP	OAK	40	X	Х		X	2	DECEASED
53	SABAL PALMETTO	CABBAGE PALM	12					2	
54	SABAL PALMETTO	CABBAGE PALM	14					2	
55	SABAL PALMETTO	CABBAGE PALM	12					2	
56	SABAL PALMETTO	CABBAGE PALM	9					2	
57 58	SABAL PALMETTO SABAL PALMETTO	CABBAGE PALM CABBAGE PALM	11					2 2	
	SABAL PALMETTO	CABBAGE PALM	12					2	
60	SABAL PALMETTO	CABBAGE PALM	10				Х	2	
61	QUERCUS SPP	OAK	12	х				2	
62	SABAL PALMETTO	CABBAGE PALM	10					2	
63	QUERCUS SPP	OAK	12	Х				2	
64 65	QUERCUS SPP	OAK	10	X				2	
65 66	QUERCUS SPP QUERCUS SPP	OAK OAK	12 12	X X			X X	2	
66 67	SABAL PALMETTO	CABBAGE PALM	3	^				2	
68	TRIADICA SEBIFERA	CHINESE TALLOW				х	х	2	
69	QUERCUS SPP	OAK	14	Х				2	TRIPLE-TRUNK
70	SABAL PALMETTO	CABBAGE PALM	10				х	2	
71	SABAL PALMETTO	CABBAGE PALM	12					2	
72 72	SABAL PALMETTO	CABBAGE PALM	12					2	
73 74	SABAL PALMETTO SABAL PALMETTO	CABBAGE PALM CABBAGE PALM	12 12					2	
74 75	QUERCUS LAURIFOLIA	LAUREL OAK	14	Х			X	2	
		LIVE OAK	24	X					
76 77	SABAL PALMETTO	CABBAGE PALM	12	^				2	
77 78	SABAL PALMETTO	CABBAGE PALM	12					2	
79	SABAL PALMETTO	CABBAGE PALM	12					2	
80	SABAL PALMETTO	CABBAGE PALM	12					2	
81	SABAL PALMETTO	CABBAGE PALM	12					2	
82	QUERCUS SPP	OAK	12	X				2	
83	QUERCUS SPP	OAK	12	X			.,	2	
84 85	QUERCUS SPP QUERCUS SPP	OAK OAK	12 18	X X			X	2 2	
85 86	QUERCUS SPP	OAK	28	X				2	
87	SABAL PALMETTO	CABBAGE PALM	12					2	
88	SABAL PALMETTO	CABBAGE PALM	12					2	
89	QUERCUS SPP	OAK	28	Х				2	
90	SABAL PALMETTO	CABBAGE PALM	10					2	
	QUERCUS SPP	OAK	17	Х				2	
92	SABAL PALMETTO	CABBAGE PALM	13					2	
93_ 94	SABAL PALMETTO SABAL PALMETTO	CABBAGE PALM CABBAGE PALM	10					2	
94 95	QUERCUS SPP	OAK	12	Х				2	
96	QUERCUS SPP	OAK	12	X				2	
97	QUERCUS SPP	OAK	12	х				2	
98	CARYA ILLINOENSIS	PECAN	17	Х			х	1	
90 99	CARYA ILLINOENSIS	PECAN	17	l x	_		x	1	

\dashv	#	SCIENTIFIC	BRUCE BEAG		PROTECTED		INVASIVE	REMOVED	PHASE	NOTES
						HERITAGE	INVASIVE			NOTES
_	101	CARYA ILLINOENSIS	PECAN CALLOVA	15	Х		v	X	1	
_	102	TRIADICA SEBIFERA	CHINESE TALLOW	10			Х	X	1	
		PRUNUS CAROLINIANA	CHERRY LAUREL					X	1	
-	104	MELIA AZEDARACH	CHINA BERRY				X	X	1	
\dashv		MELIA AZEDARACH	CHINA BERRY	40	V		Х	X	1	
\dashv	106	QUERCUS SPP	OAK CARRACE BALM	12	Х			X	1	
\dashv	107	SABAL PALMETTO	CABBAGE PALM	16				X	1	
	108	SABAL PALMETTO	CABBAGE PALM	16				X	1	
	109	SABAL PALMETTO	CABBAGE PALM	14				X	1	
		SABAL PALMETTO	CABBAGE PALM CABBAGE PALM	14				X X	1	
\dashv	111	SABAL PALMETTO		14	V				1	DISEASED
	112	QUERCUS NIGRA	WATER OAK	19 12	X			X X	1	DISEASED
\dashv		SABAL PALMETTO	CABBAGE PALM	12				X	1	
	114	SABAL PALMETTO SABAL PALMETTO	CABBAGE PALM CABBAGE PALM	16				x x	1	
-										
\dashv		SABAL PALMETTO SABAL PALMETTO	CABBAGE PALM	12 12				X X	1	
\dashv	117		CABBAGE PALM LAUREL OAK	12	X			^	1	
\dashv	118	SABAL PALMETTO	CABBAGE PALM	10				X	1	
\dashv	120	SABAL PALMETTO	CABBAGE PALM	10				X	1	
\dashv		MELIA AZEDARACH	CHINA BERRY	10			Х	x x	1	
		MELIA AZEDARACH	CHINA BERRY				X	X	1	
\dashv		MELIA AZEDARACH	CHINA BERRY				X	X	1	
\dashv	123	QUERCUS SPP	OAK	20	X		^	X	1	
\dashv	125	SABAL PALMETTO	CABBAGE PALM	10	^				1	
		SABAL PALMETTO	CABBAGE PALM	10					1	
-	127	QUERCUS VIRGINIANA	LIVE OAK	8	X			X	1	
-			LIVE OAK	8	X			^	1	
\dashv			LIVE OAK	8	X				1	
-			LIVE OAK	8	X				1	
-			LIVE OAK	8	X				1	
-			LIVE OAK	8	X				1	
	133	QUERCUS VIRGINIANA	LIVE OAK	8	x				1	
-	134		LAUREL OAK	8	X				1	
-			LAUREL OAK	3	X				1	
-		MELIA AZEDARACH	CHINA BERRY		^		Х	x	1	
		MELIA AZEDARACH	CHINA BERRY				X	x	1	
		MELIA AZEDARACH	CHINA BERRY				X	X	1	
\dashv		MELIA AZEDARACH	CHINA BERRY				X	x	1	
\dashv		MELIA AZEDARACH	CHINA BERRY				X	x	1	
\dashv		SABAL PALMETTO	CABBAGE PALM	14			•	,	2	
\dashv		SABAL PALMETTO	CABBAGE PALM	10					2	
\dashv		SABAL PALMETTO	CABBAGE PALM	14				X	2	
\dashv	144	SABAL PALMETTO	CABBAGE PALM	14					2	
\dashv	-	SABAL PALMETTO	CABBAGE PALM	16					2	
\dashv		SABAL PALMETTO	CABBAGE PALM	17					2	
\dashv	-	SABAL PALMETTO	CABBAGE PALM	13					2	
\dashv		SABAL PALMETTO	CABBAGE PALM	10					1	
\dashv	-	SABAL PALMETTO	CABBAGE PALM	12					1	
\dashv	-	SABAL PALMETTO	CABBAGE PALM	15					1	
\dashv	-	SABAL PALMETTO	CABBAGE PALM	14					1	
\dashv	-	SABAL PALMETTO	CABBAGE PALM	14					1	
\dashv		SABAL PALMETTO	CABBAGE PALM	8					1	
\dashv	154	SABAL PALMETTO	CABBAGE PALM	10					1	
\dashv			CABBAGE PALM	14				x	1	



		PHASE	1 PHASE	2 TOTAL
TREES REMOVED		33	10	43
PROTECTED TREES REM	OVED	7	5	12
TOTAL DBH PROTECTED	SPECIES REMOVED	108	90	198
NUMBER OF REPLACEME	NT TREES REQUIRED	22	23	45
NUMBER OF REPLACEME	NT TREES PROPOSED (CH 12-6 APPEI	IDIX B SPECIES)		
ILEX CASSINE ILEX VOMITORIA MAGNOLIA VIRGINIANA QUERCUS NUTTALLII QUERCUS VIRGINIANA SABAL PALMETTO TAXODIUM DISTICHUM	DAHOON HOLLY 8' HT YAUPON HOLLY 6' HT SWEETBAY MAGNOLIA 10' HT NUTTALL OAK 4" CAL LIVE OAK 4" CAL CABBAGE PALM VARIED BALD CYPRESS 4" CAL			3 3 13 9 63 27 2







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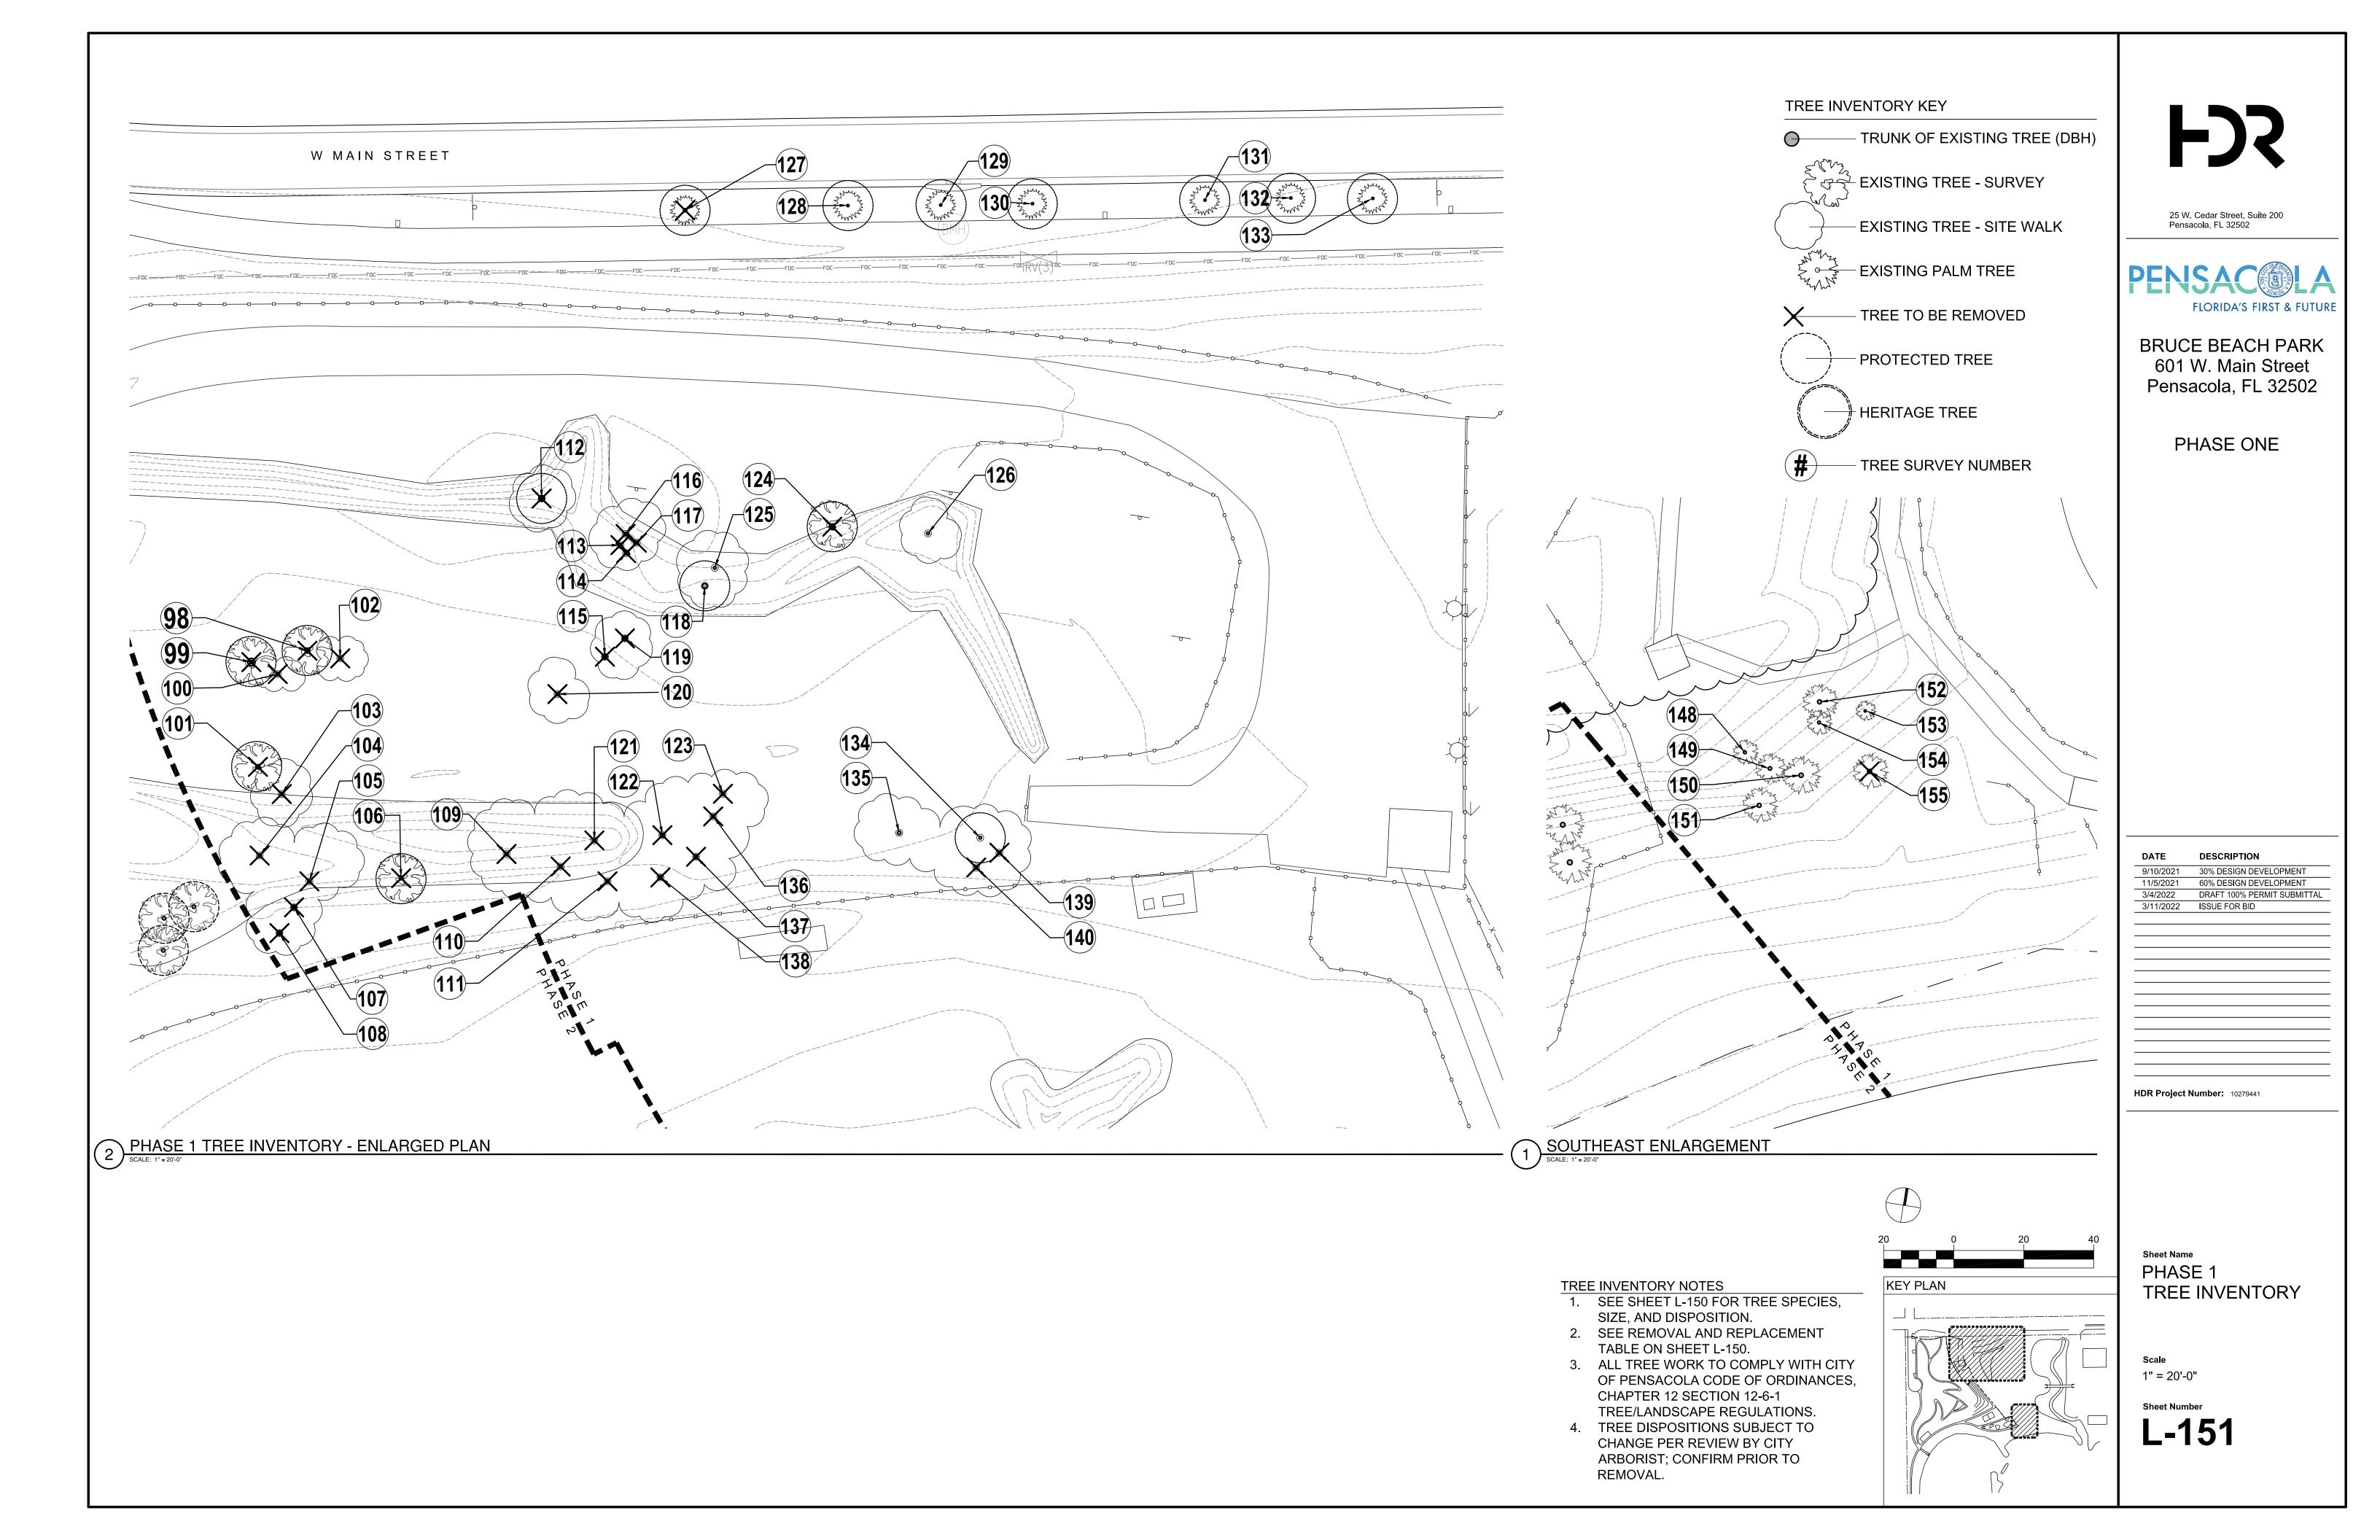
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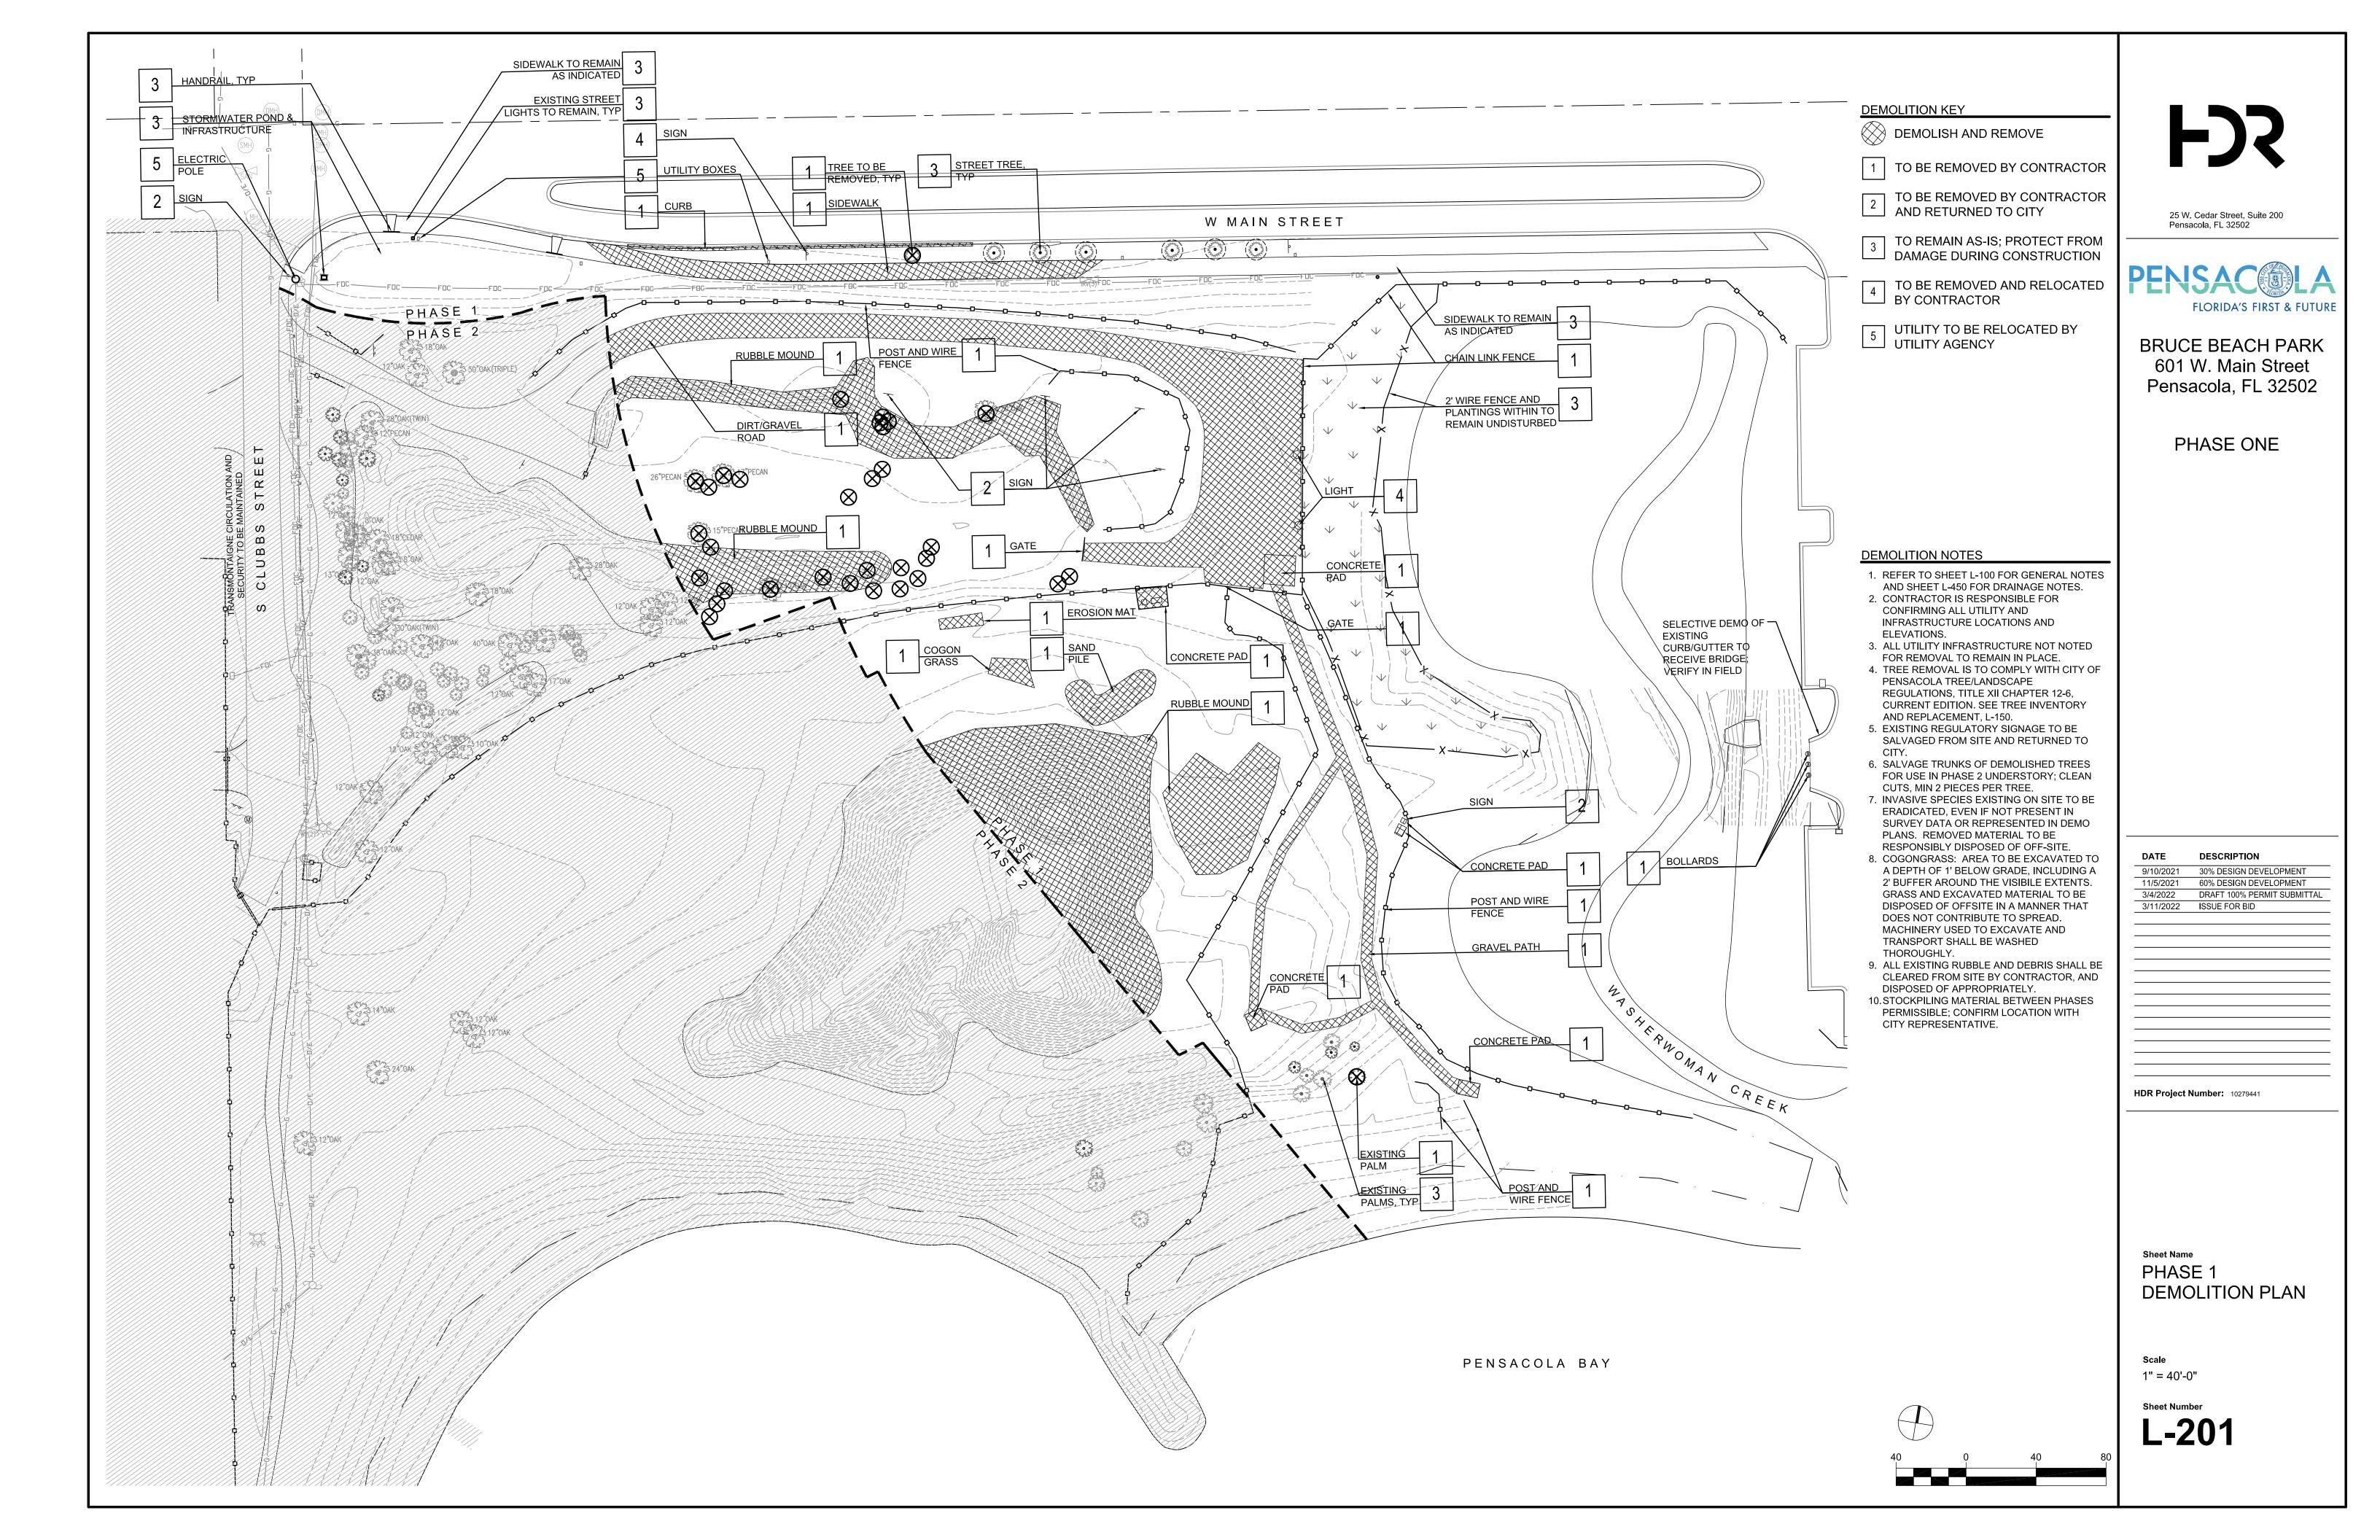
HDR Project Number: 10279441


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TREE INVENTORY
AND REPLACEMENT
SUMMARY

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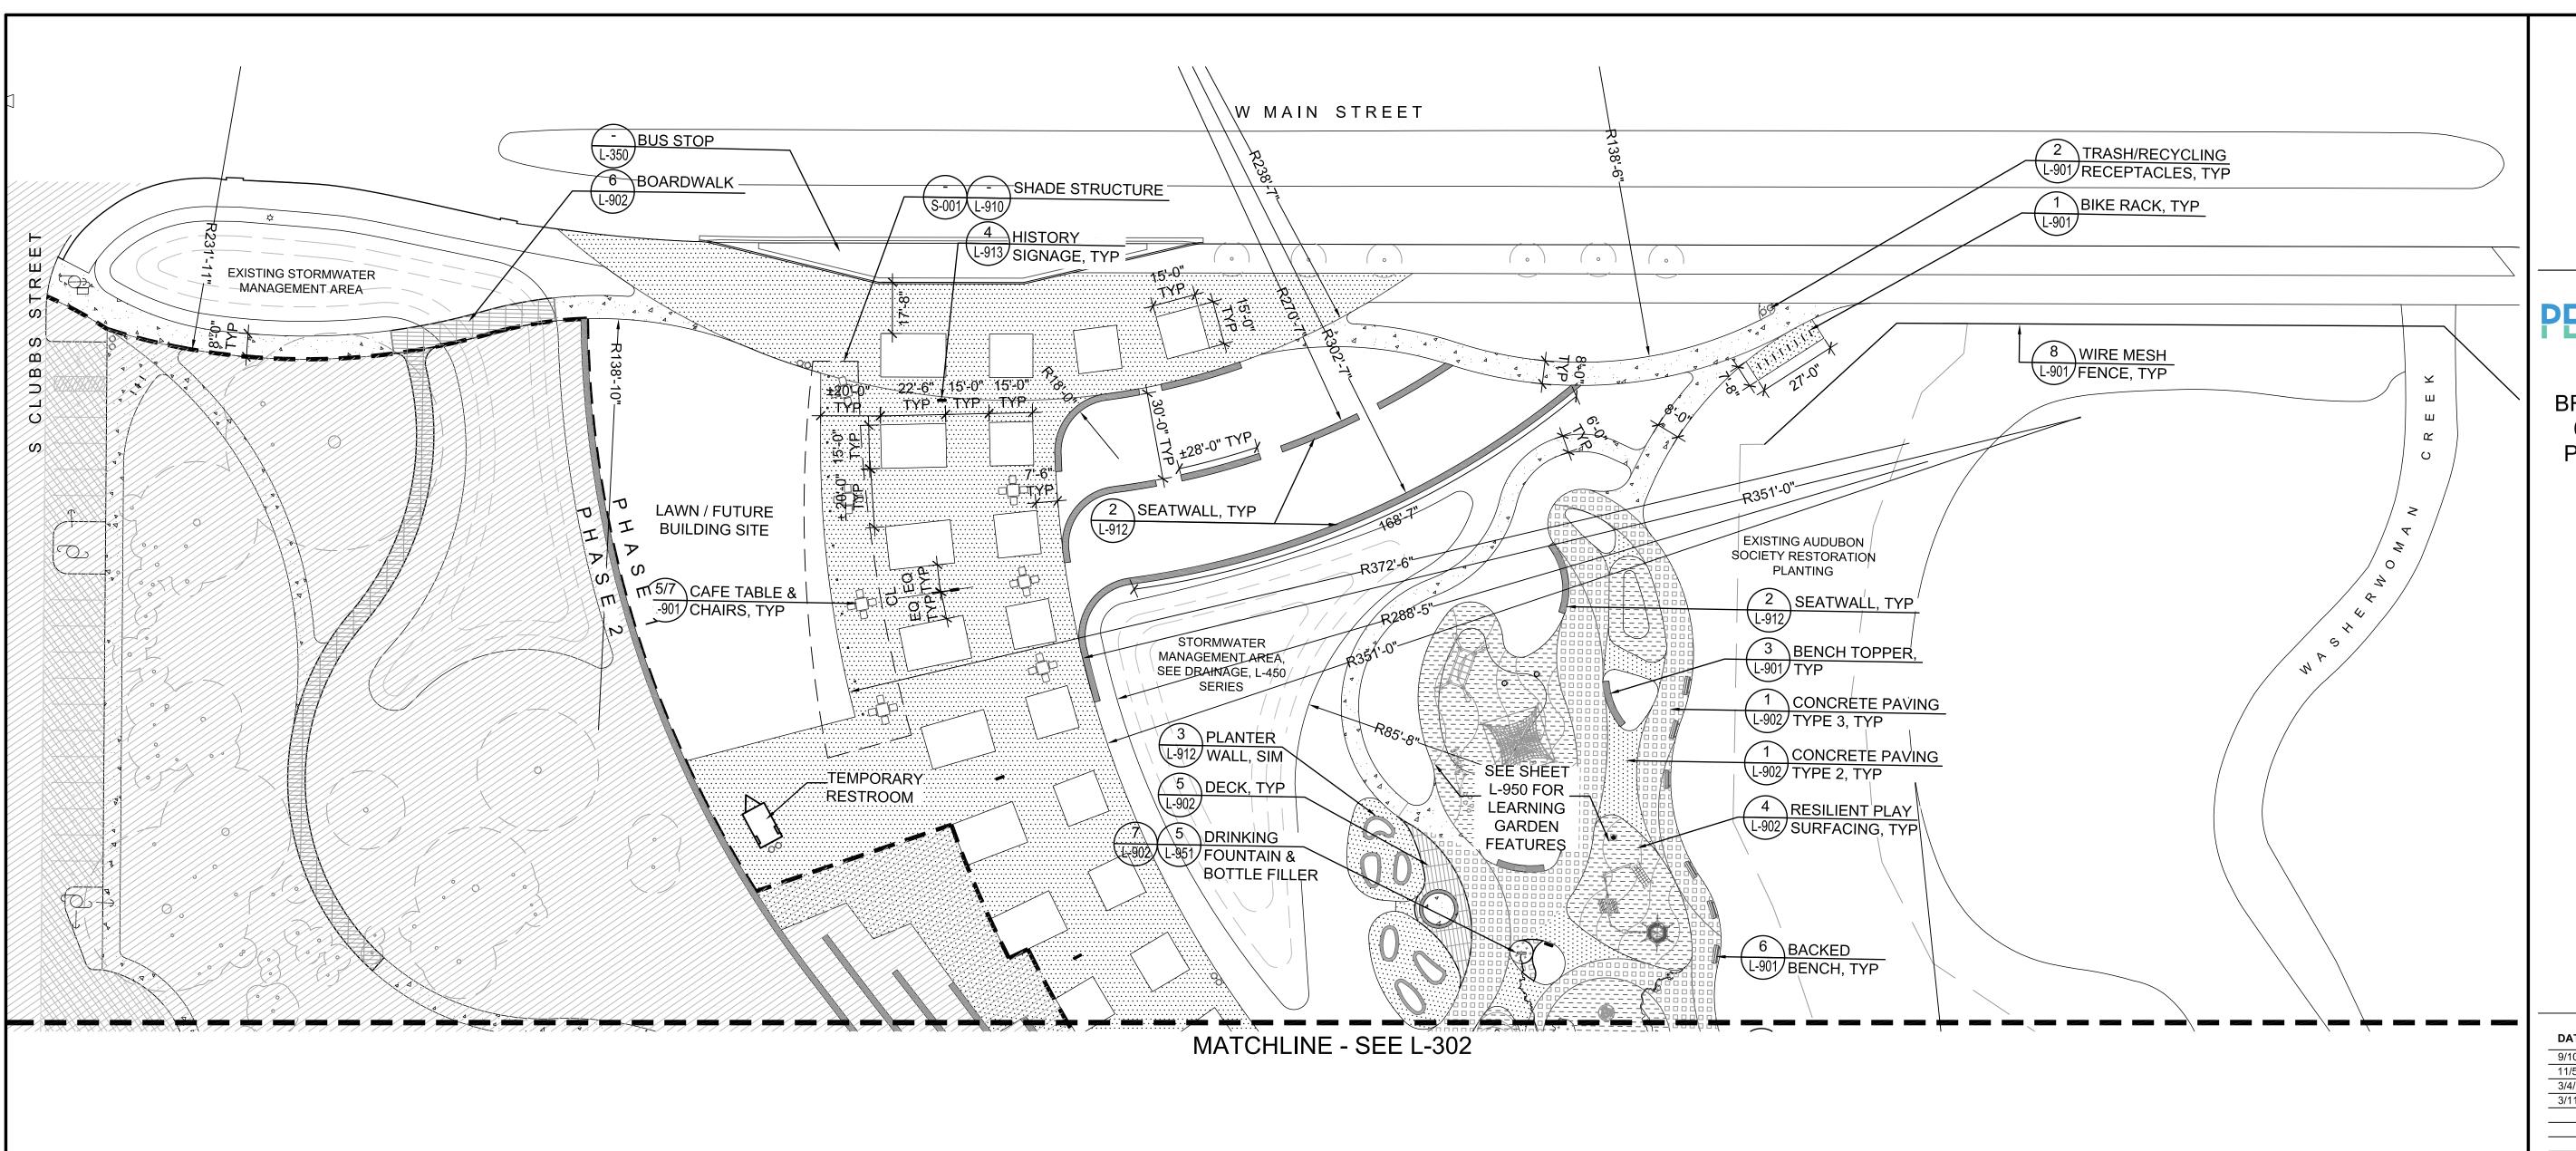
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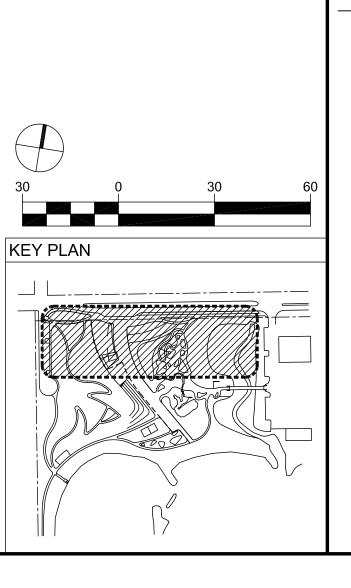






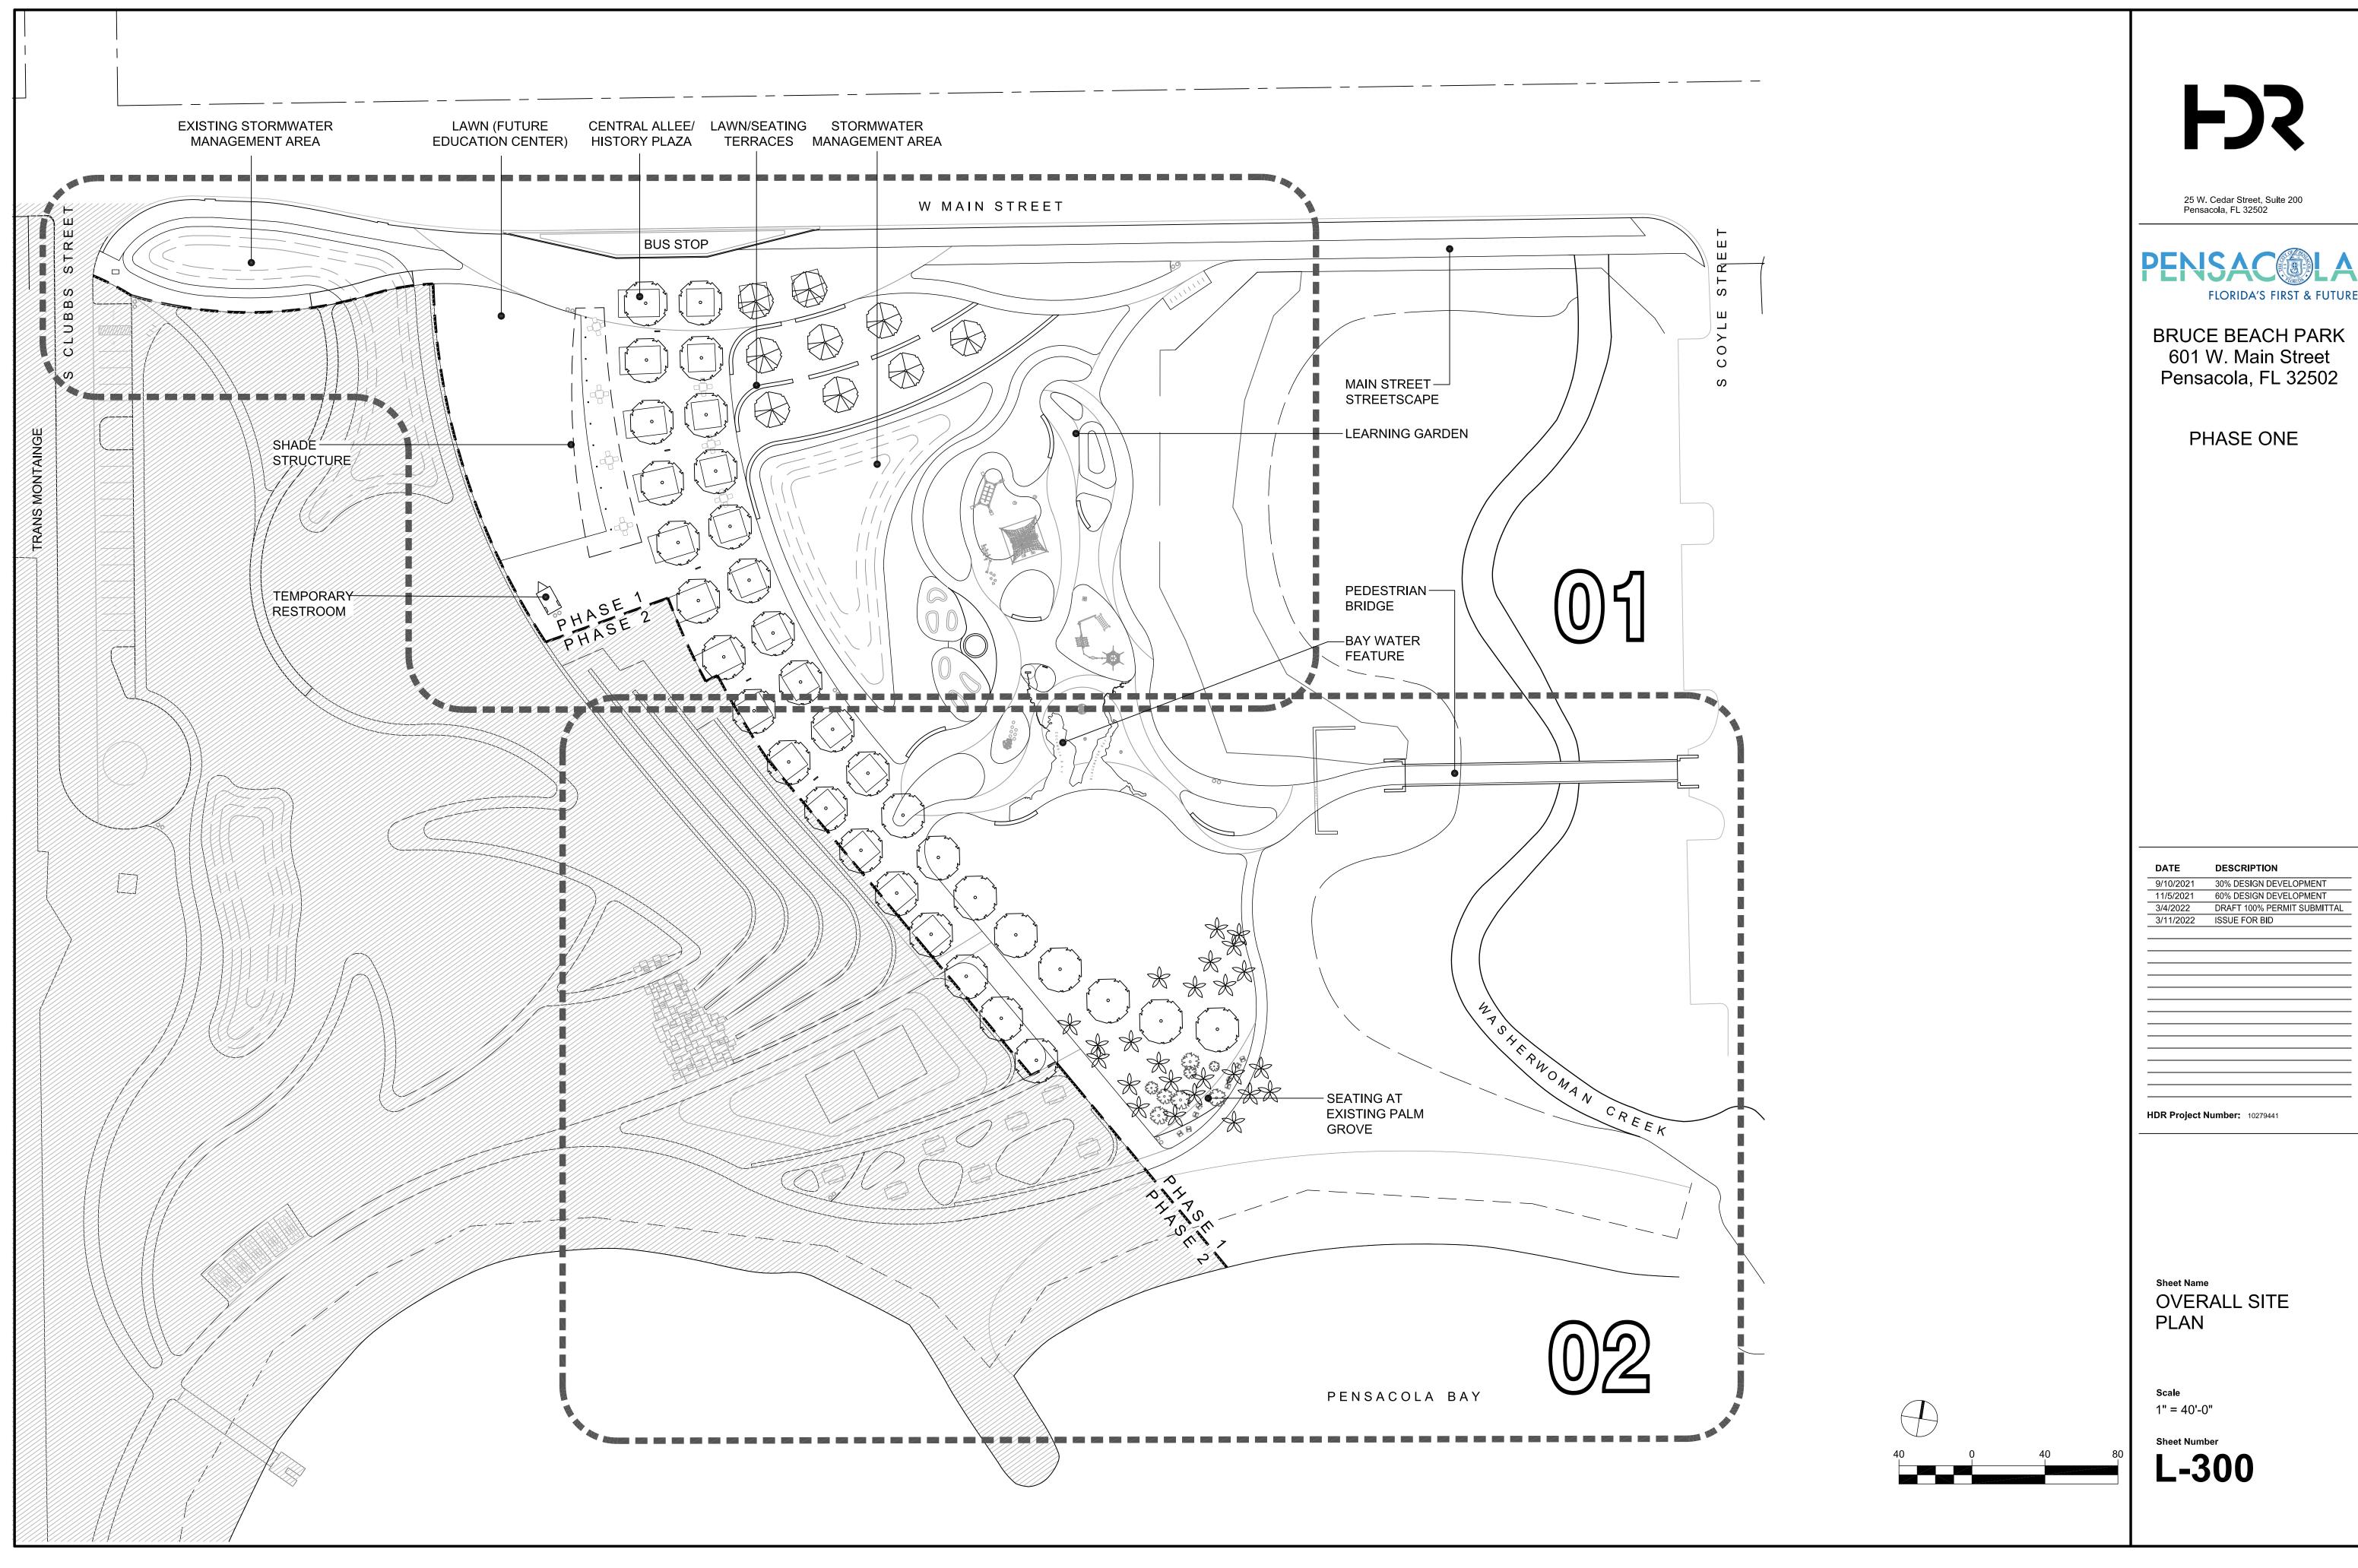

PHASE 1 -	LAYOUT & MATERIALS	KEY			PHASE 1 - LAYOUT & MATERIALS KEY					
	HARDSCAPE	MATERIAL/COLOR	FINISH	NOTES		FURNISHING	MANUFACTURER	MODEL/MATERIAL	FINISH/COLOR	NOTES
	—BOARDWALK / DECK	MODIFIED ASH	NATURAL, SEALED		-	—LOUNGE CHAIR	LANDSCAPEFORMS	AMERICANA CHAIR	LEAF GREEN	SURFACE MOUNT
A A	—CONCRETE TYPE 1	NATURAL GRAY	BROOM			—CAFE TABLE	LANDSCAPEFORMS	PARC CENTRE SQUARE	SILVER POWDERCOAT	SURFACE MOUNT
	—CONCRETE TYPE 2	NATURAL GRAY	SHELL SEEDED			—CAFE CHAIR	LANDSCAPEFORMS	PARC CENTRE CHAIR	SILVER POWDERCOAT	ARMLESS, FREESTANDING
	—CONCRETE TYPE 3	NATURAL GRAY	ROCK SALT FINISH		=	—BACKED BENCH	LANDSCAPEFORMS	GLIDE BENCH	LEAF GREEN	4 PER CAFE TABLE SURFACE MOUNT
**************************************	—CONCRETE TYPE 4	NATURAL GRAY	BLUE GLASS AGGREGATE		_	BENCH TOPPER	ANOVA	INFINITY INF24L6WT	MODIFIED ASH	
<u> </u>	—SAND	NATURAL			111	—BICYCLE RACK	FORMS + SURFACES	CAPITOL BIKE RACK	SILVER POWDERCOAT	EMBED
	—PLAY SURFACING	COLOR PER PLAN	N/A		00-	—TRASH RECEPTACLE	LANDSCAPEFORMS	LAKESIDE	SILVER	GRASS PATTERN,
	—SITE WALL	NATURAL GRAY	ROCK SALT FINISH					RECEPTACLE	POWDERCOAT	SURFACE MOUNTED



FJS

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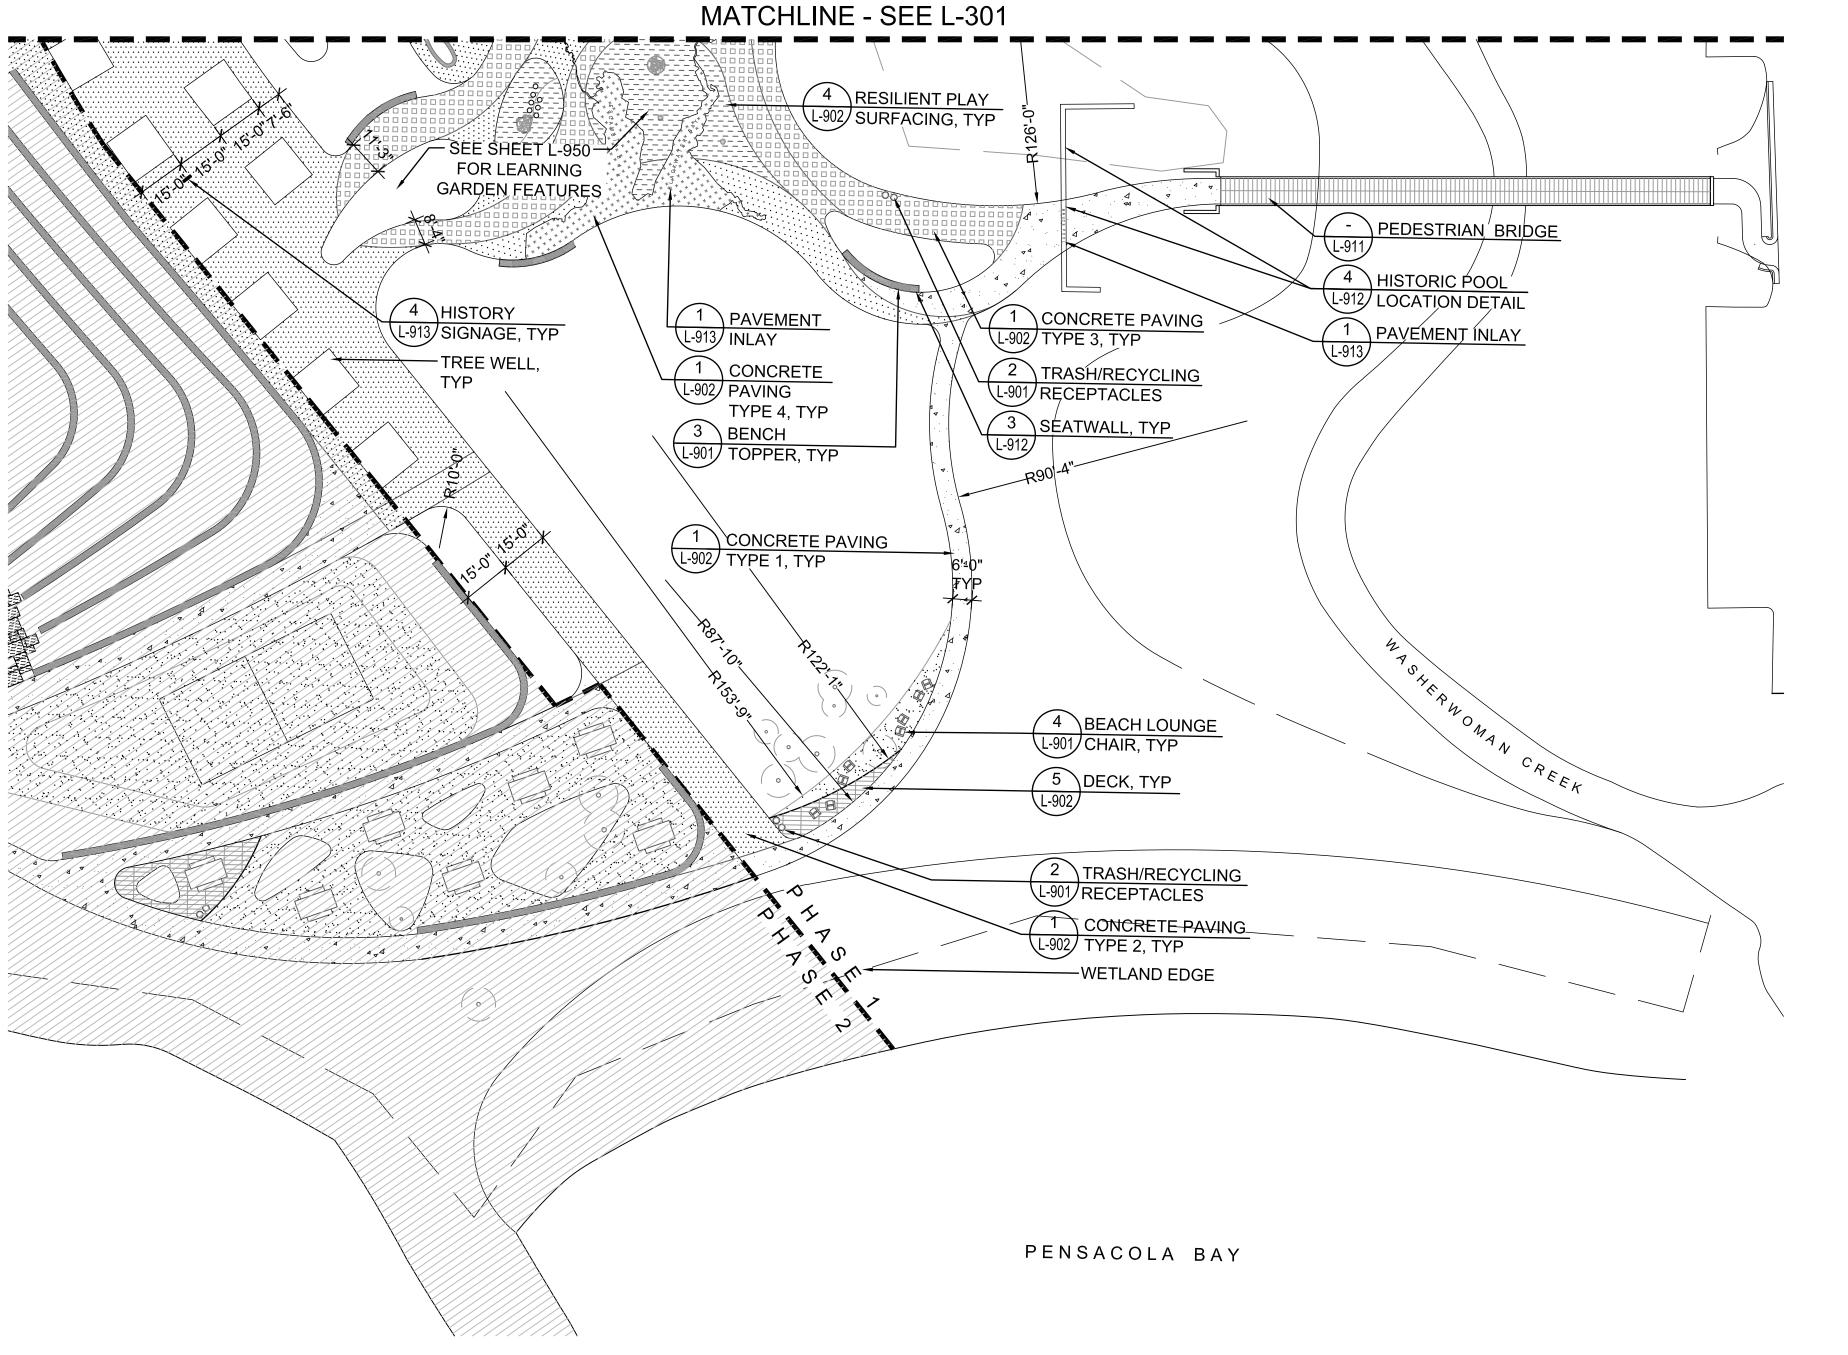
PHASE ONE


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LAYOUT AND STAKING PLAN -AREA 1

1" = 30'-0"







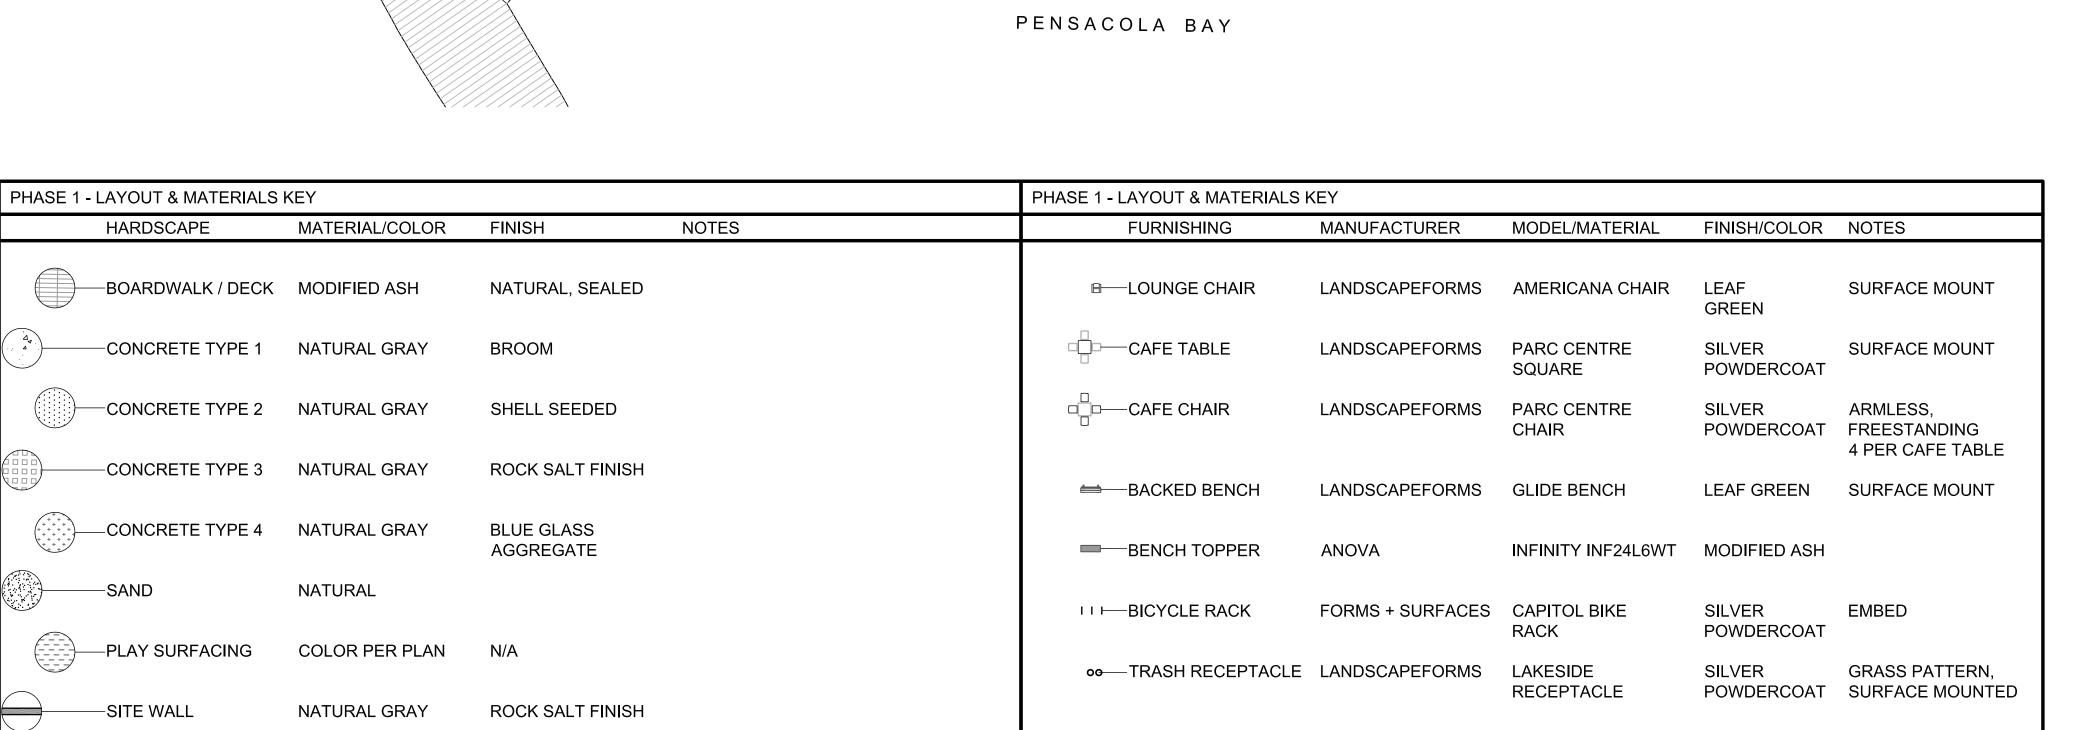

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PHASE ONE

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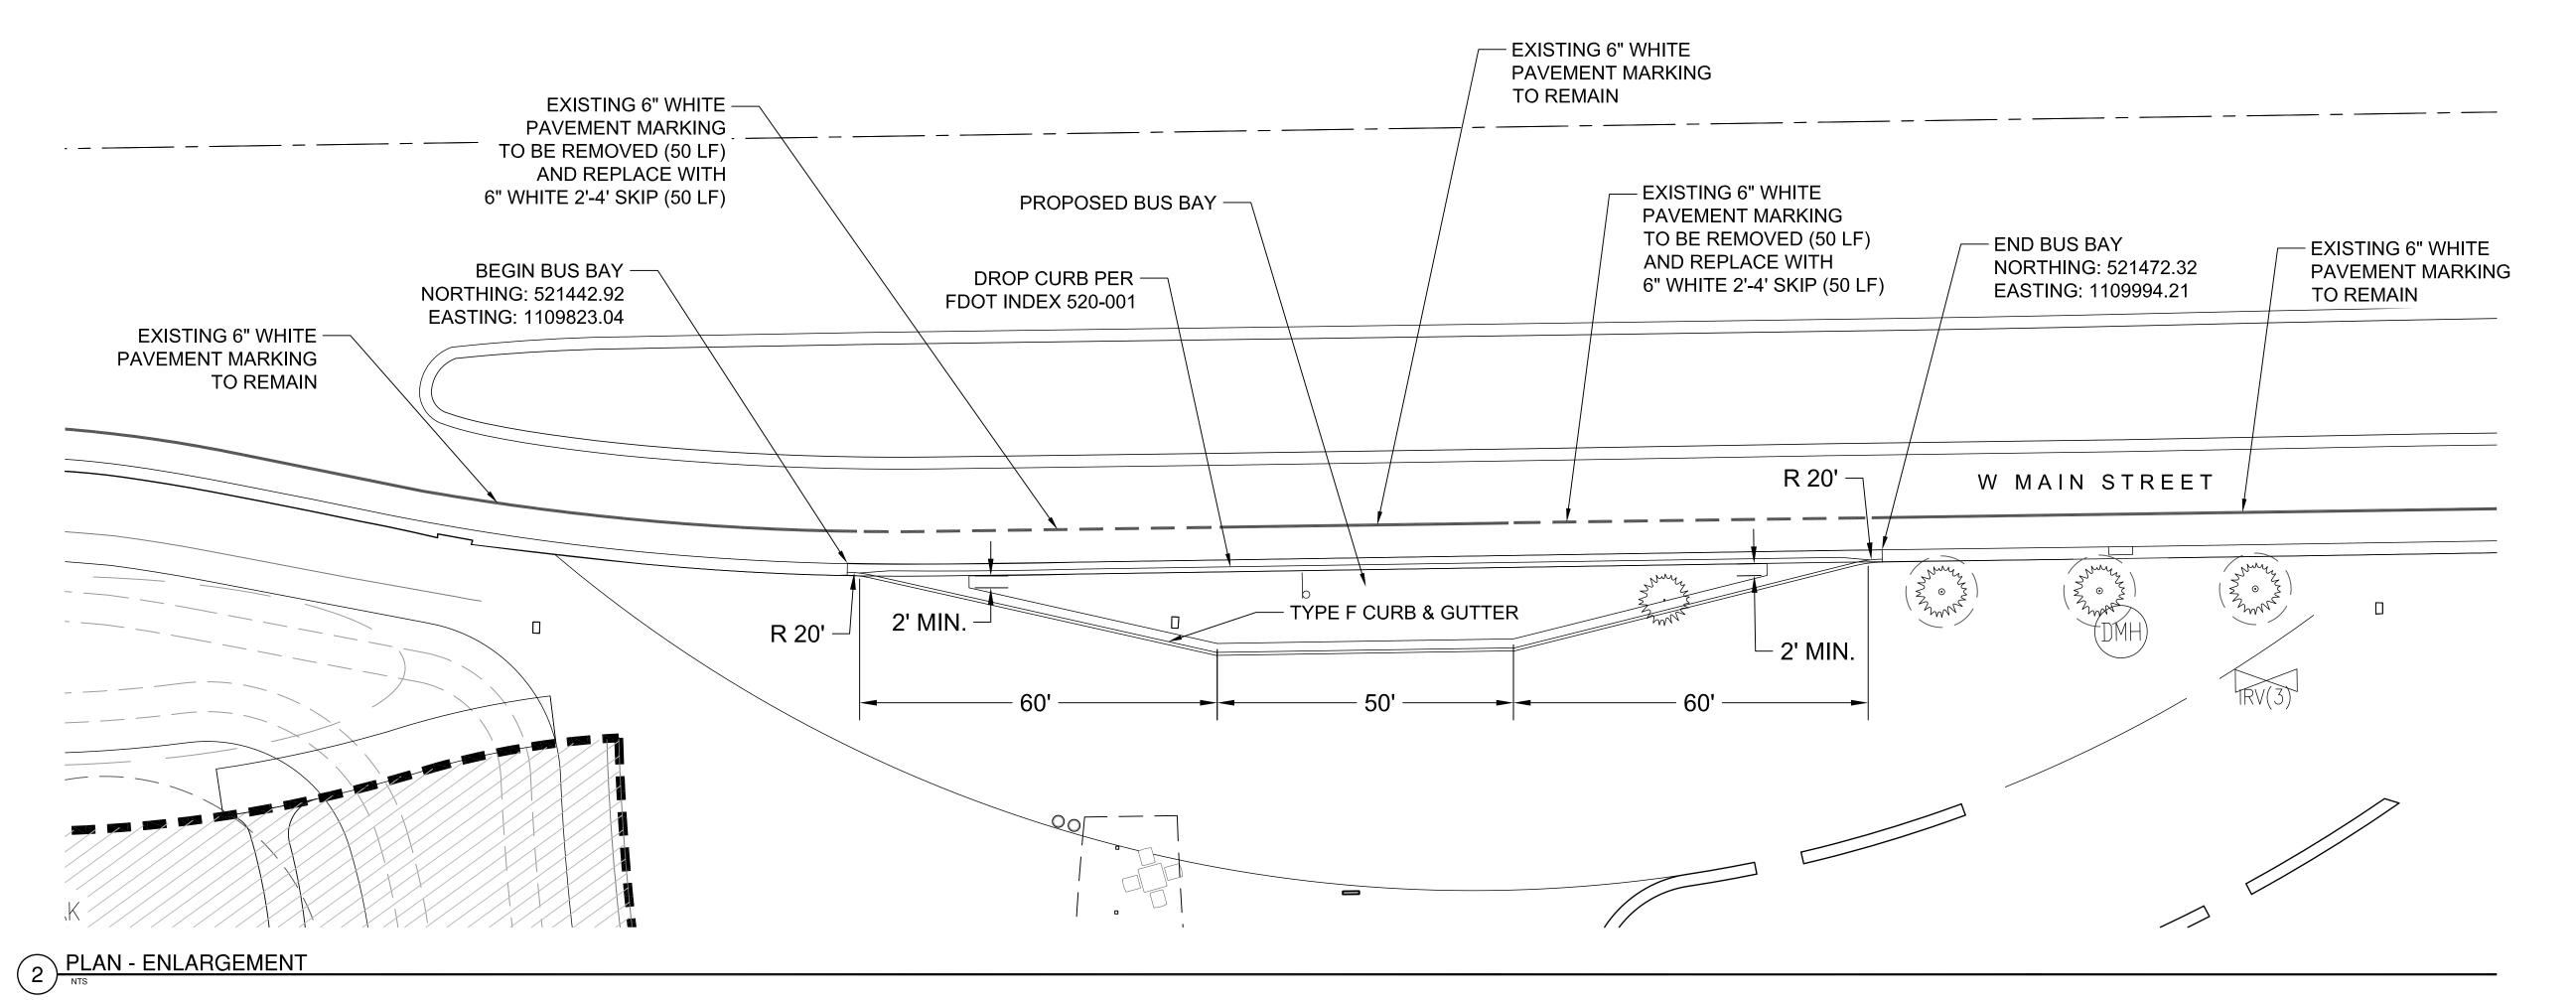
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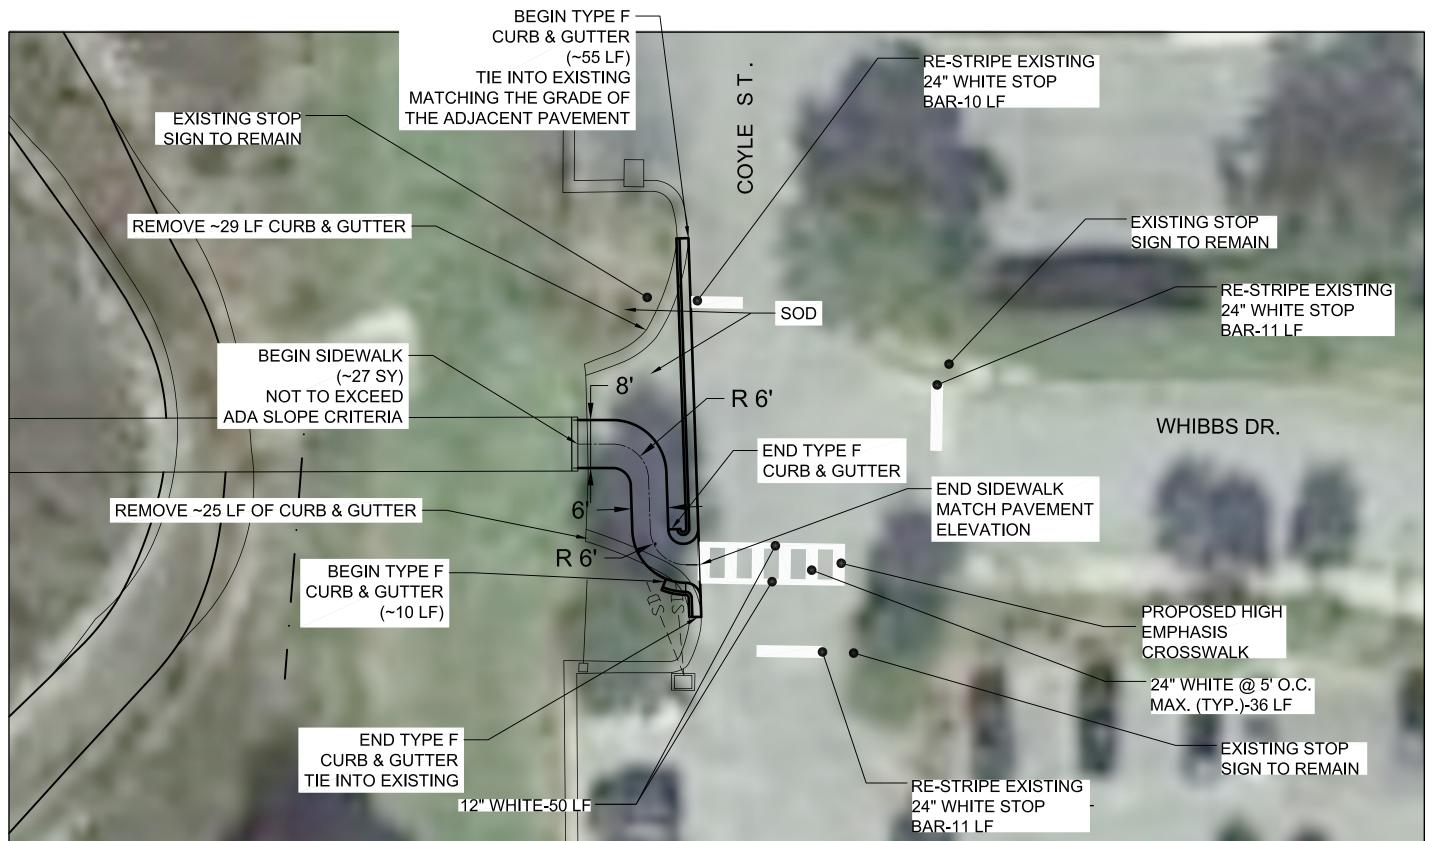
LAYOUT AND STAKING PLAN -AREA 2

KEY PLAN


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3 PLAN NTS



TYPICAL BUS BAY
URBAN/CURB & GUTTER CONDITION
WITH ASPHALT PAVEMENT
N.T.S.

1 TYPICAL BUS BAY

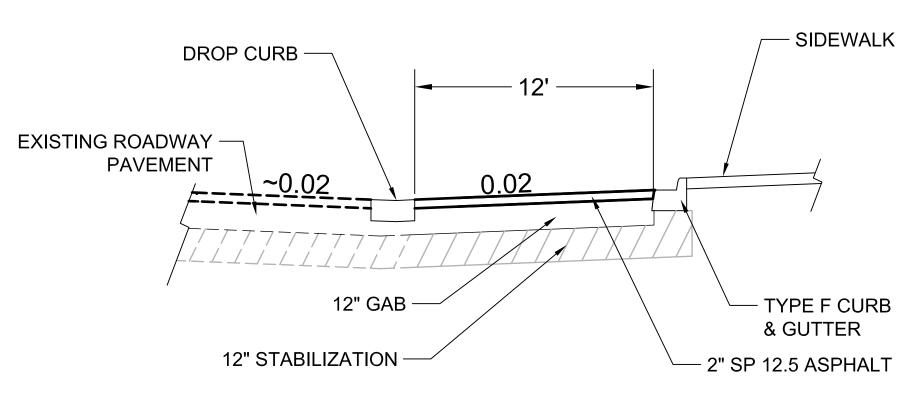

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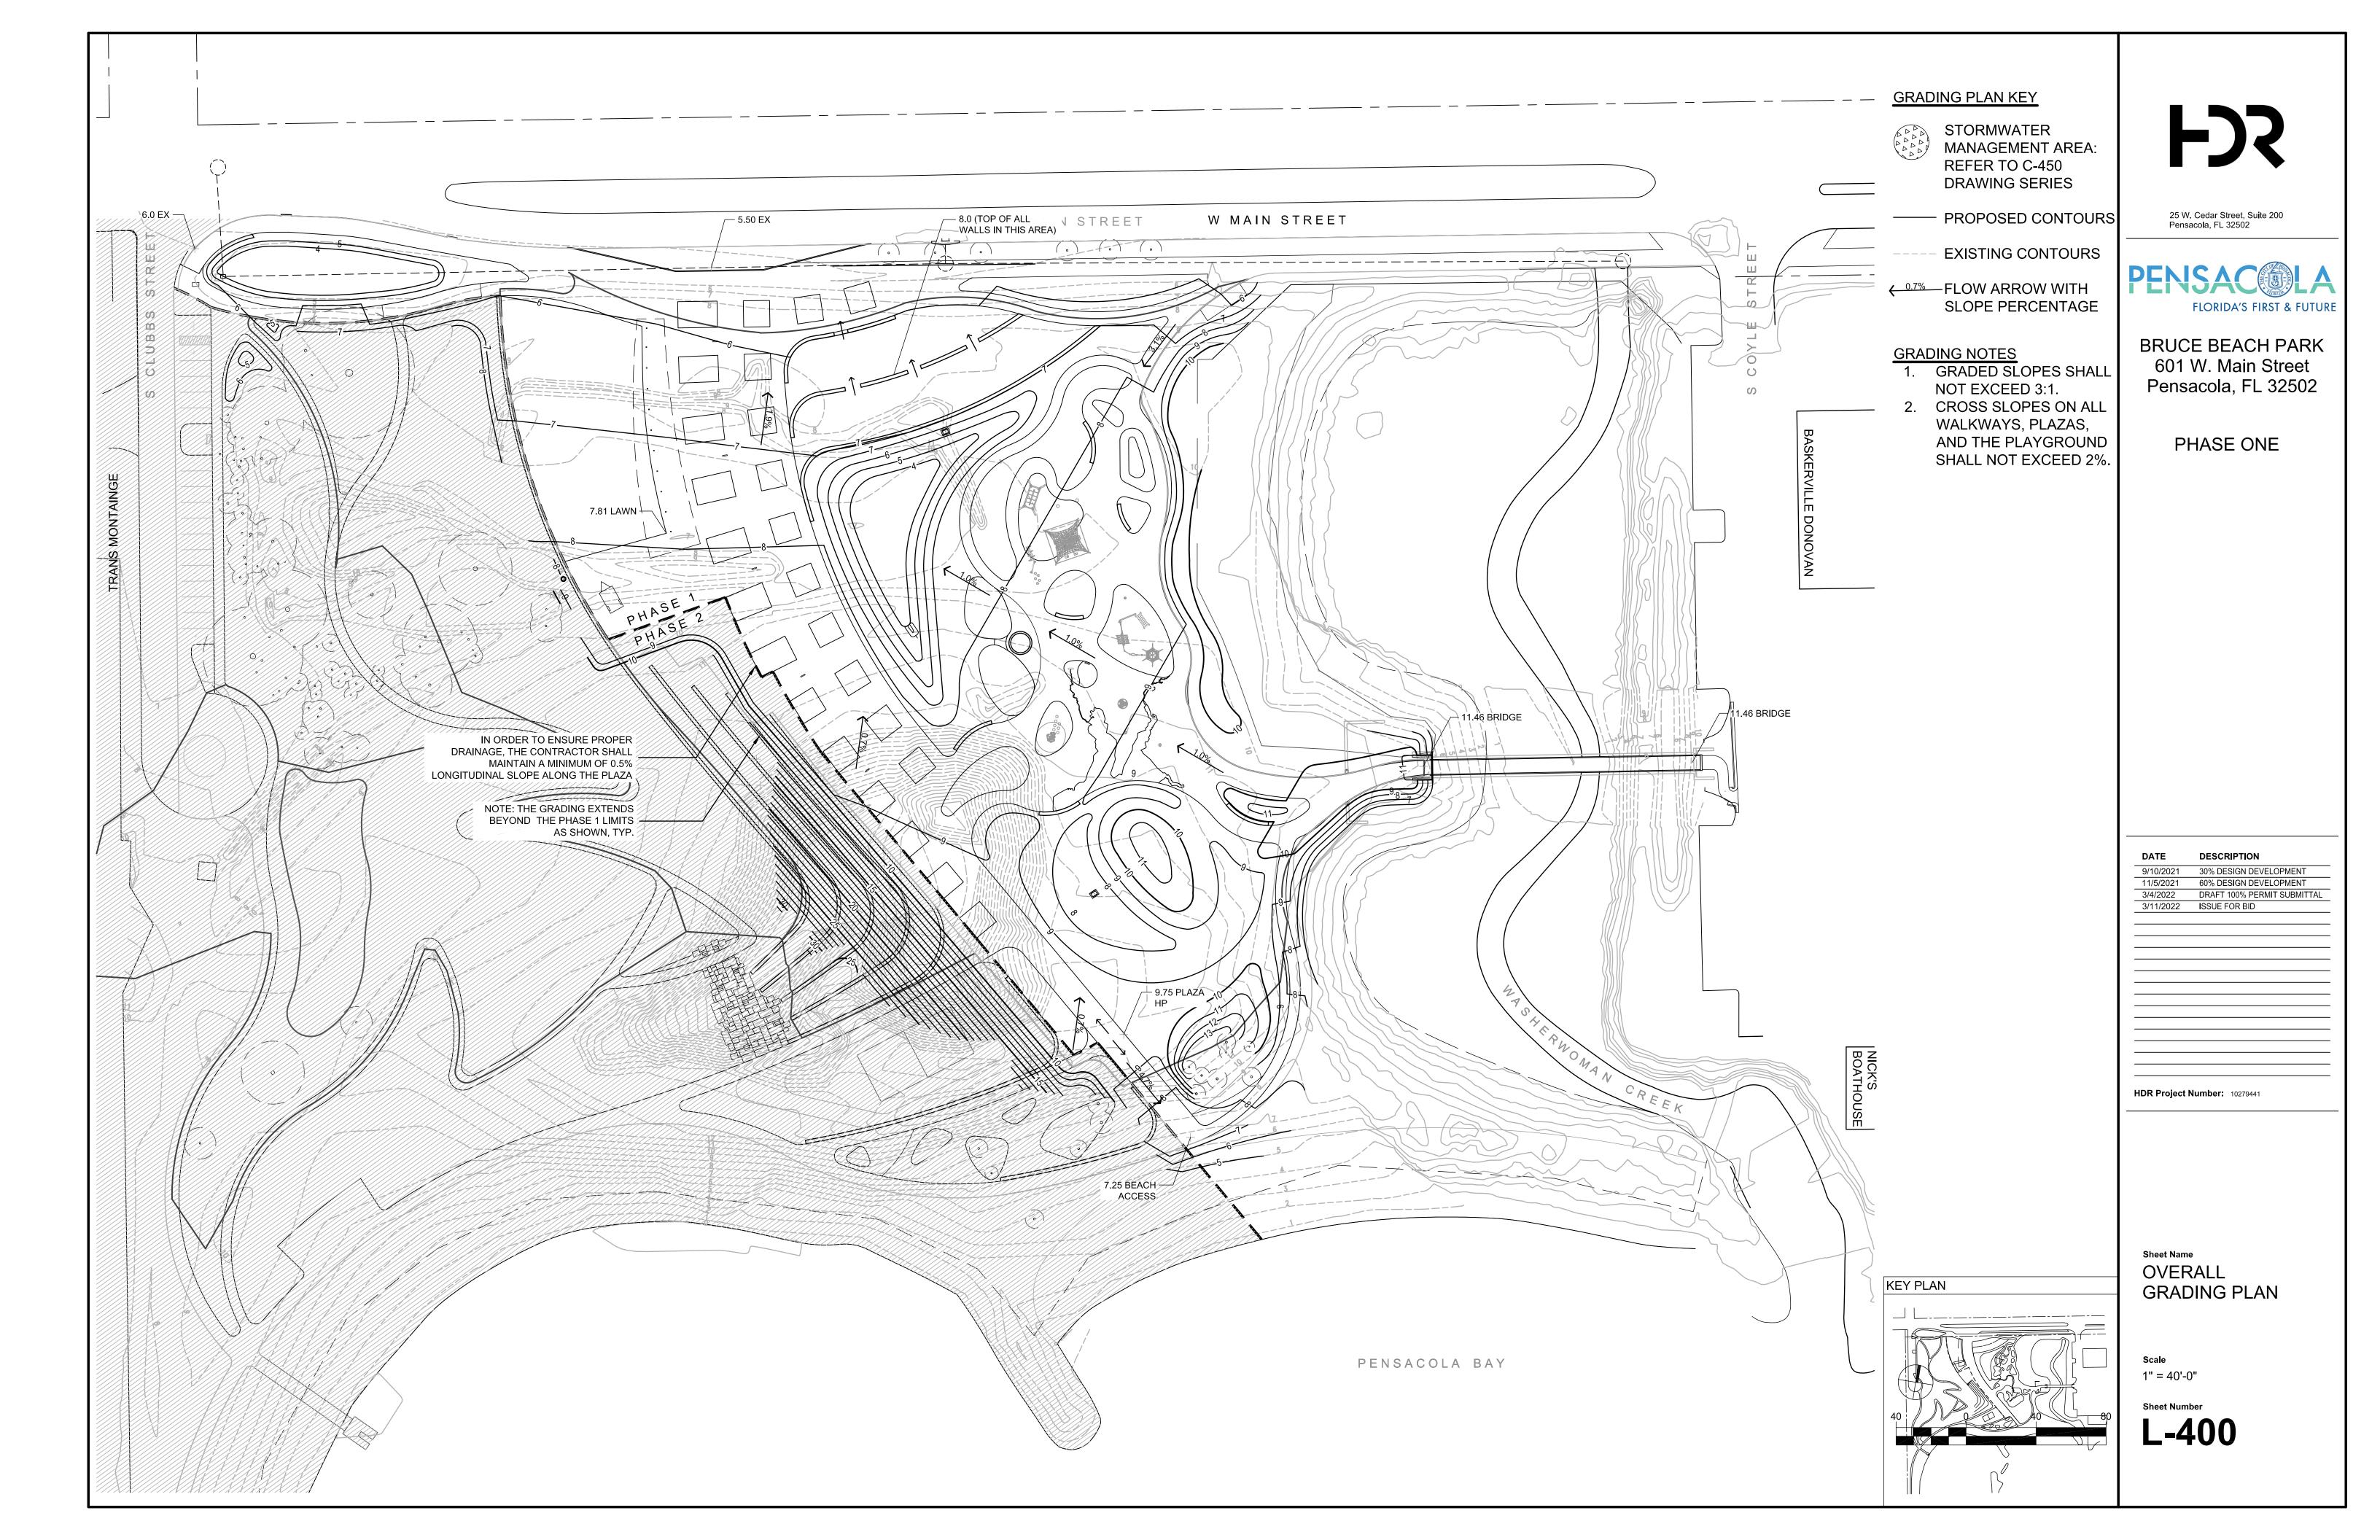
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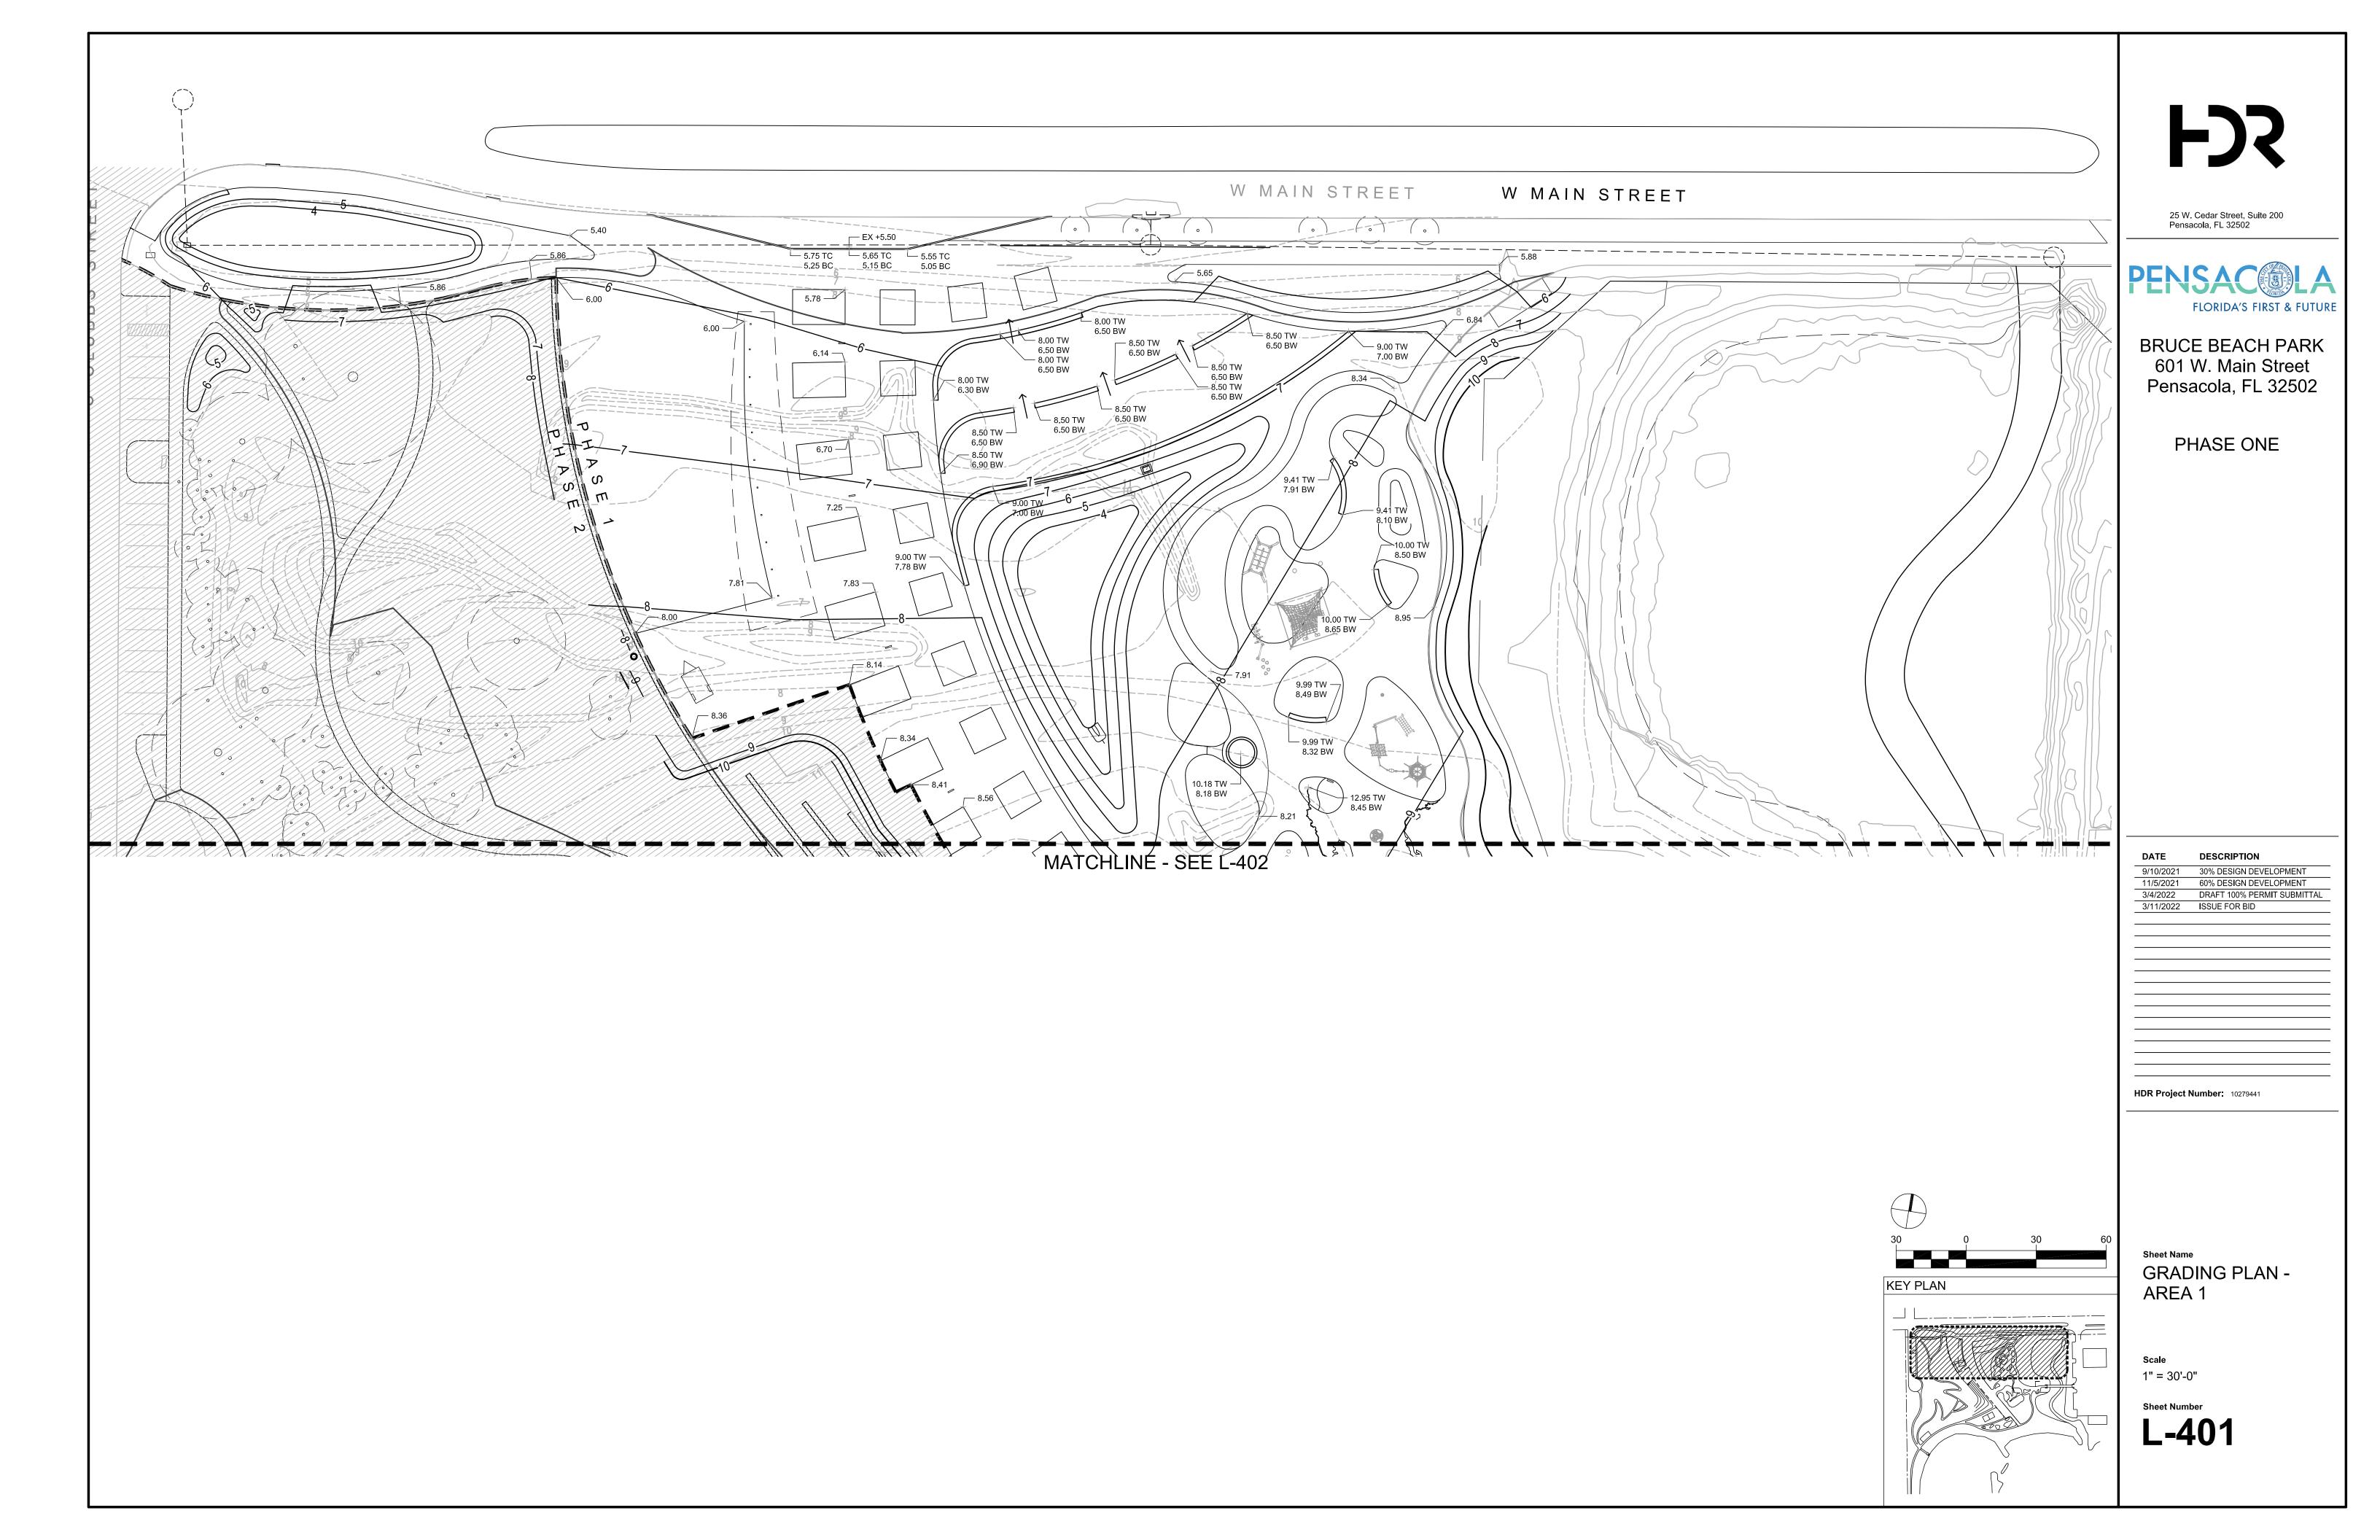
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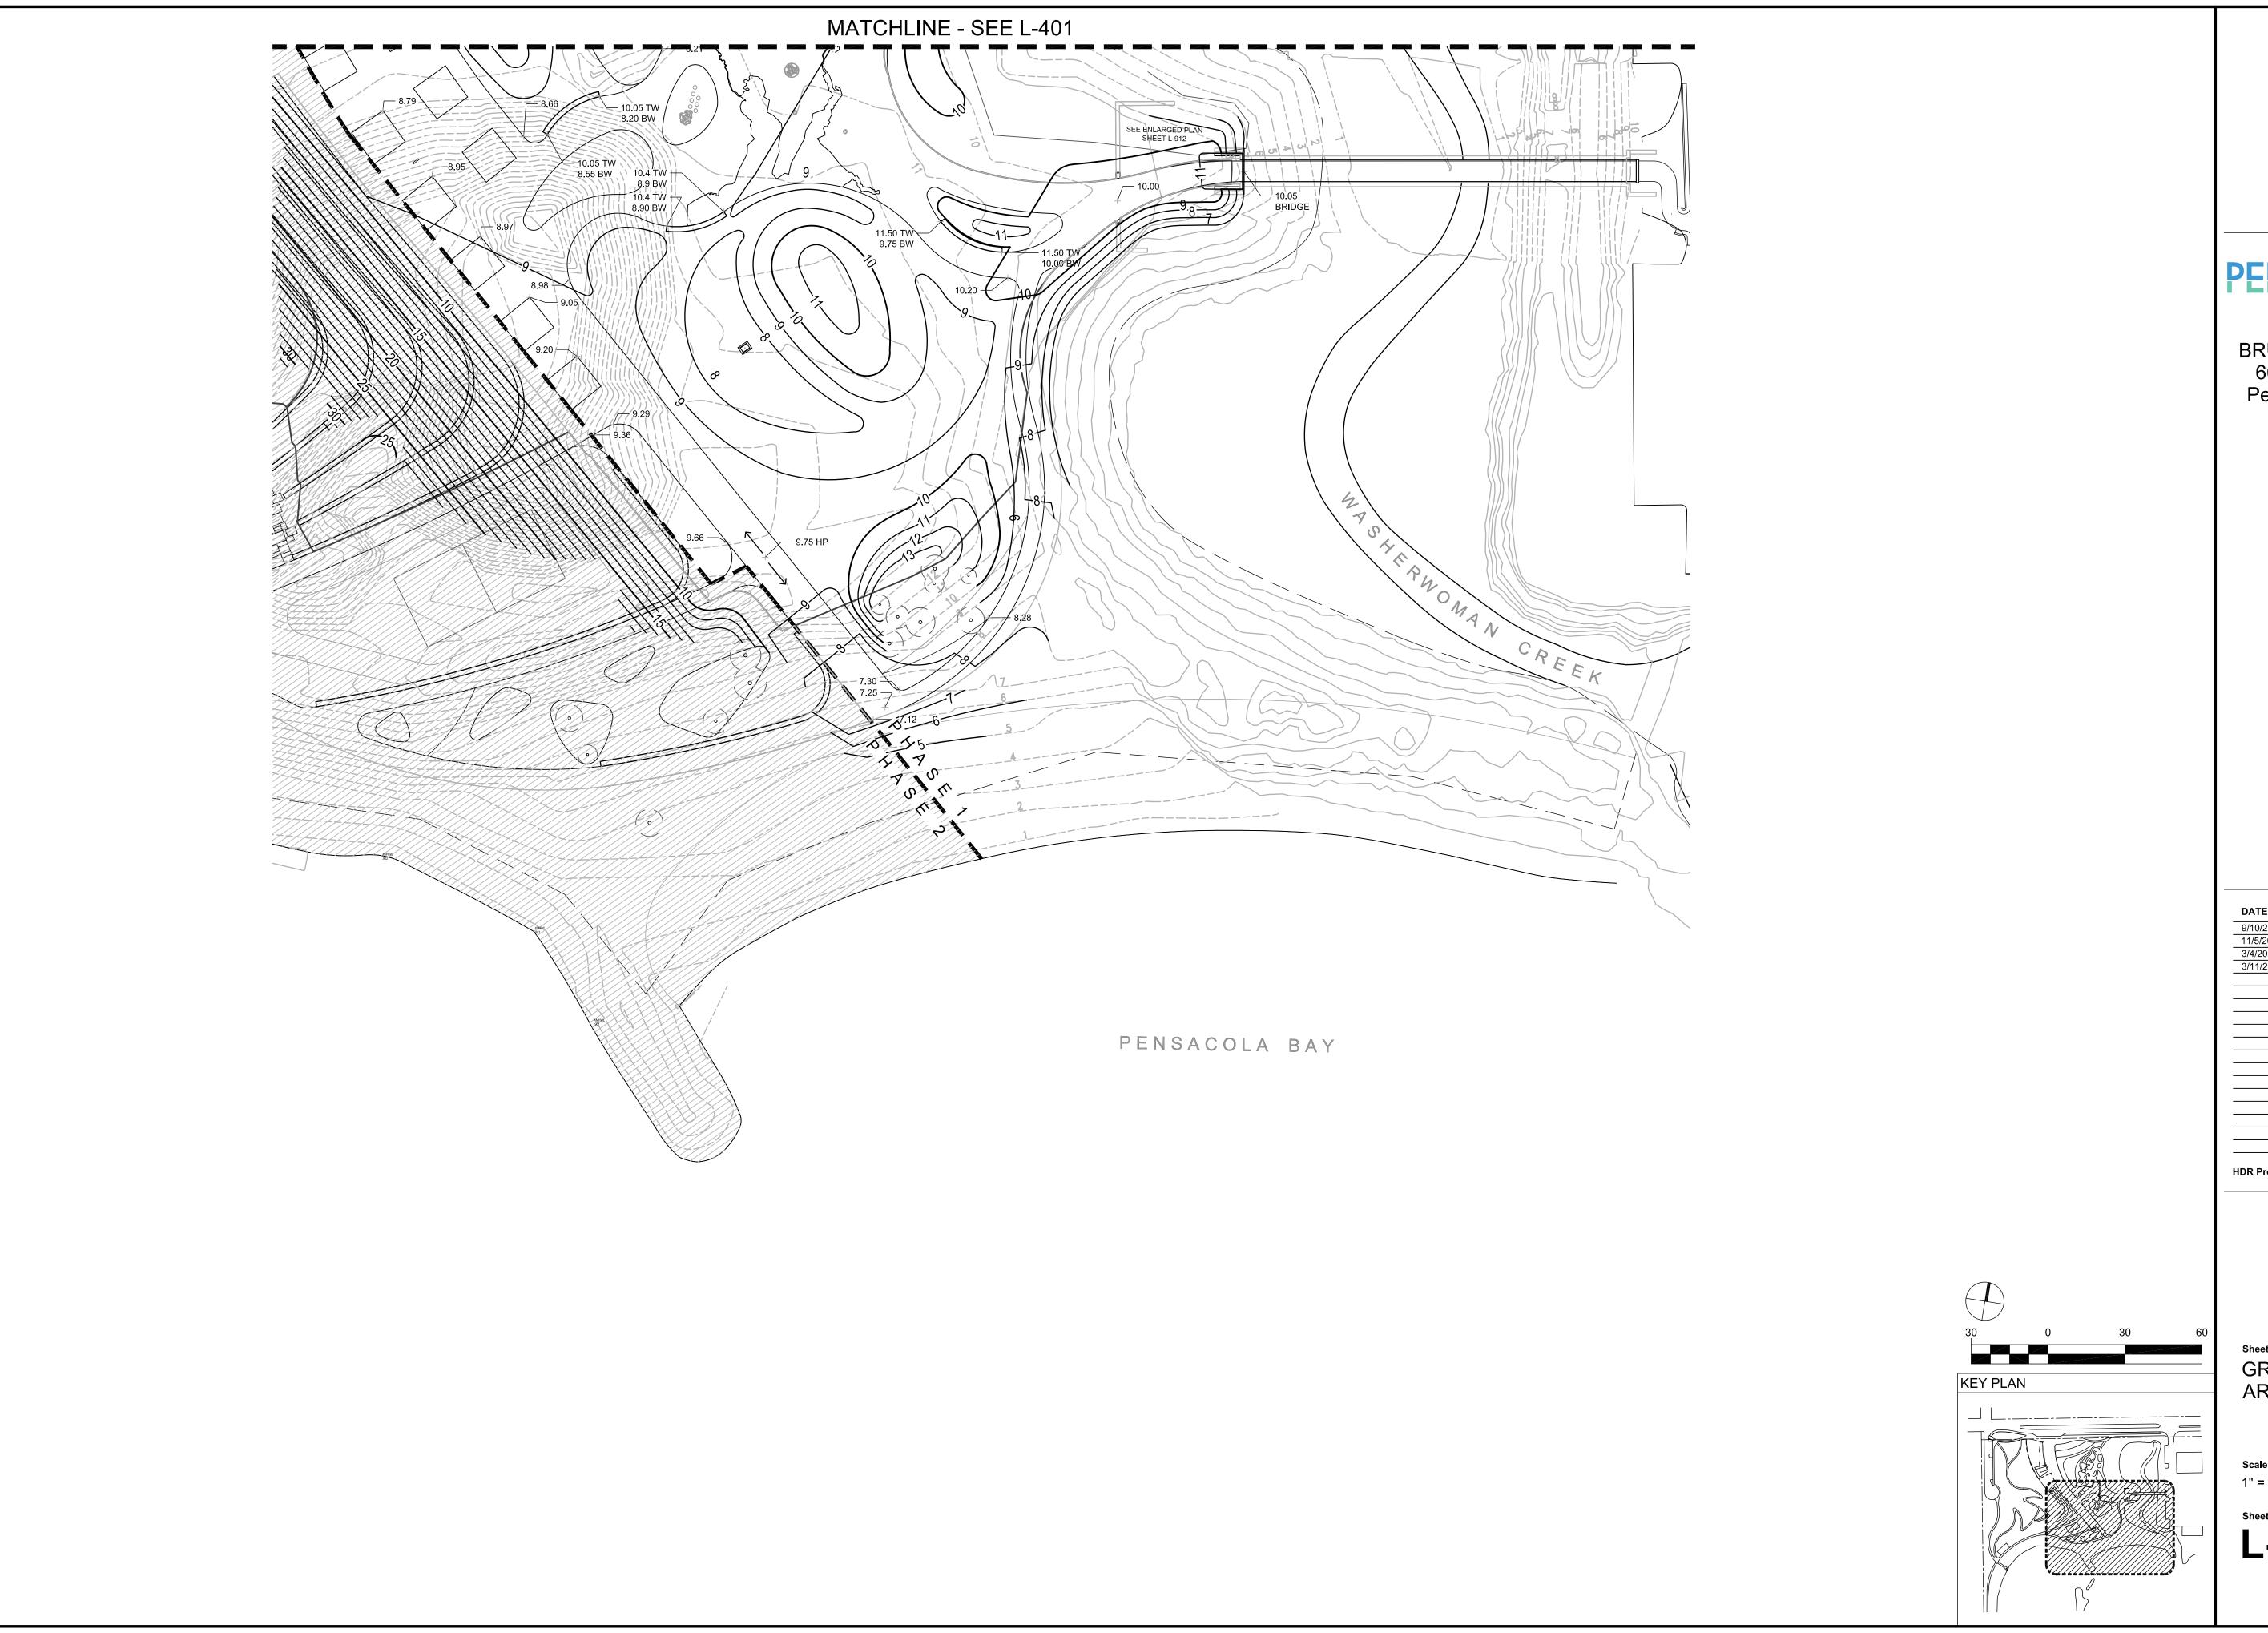
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KEY PLAN











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Sheet Name GRADING PLAN -AREA 2

Scale 1" = 30'-0"

Sheet Number

1 -402

GENERAL NOTES - DRAINAGE:

- 1. THE CONTRACTORS SHALL NOTIFY THE CITY DESIGN ENGINEER OR DESIGNEE 48 HOURS PRIOR TO CONSTRUCTION.
- 2. ALL CONDITIONS AND STIPULATIONS OF THE CONSTRUCTION PERMITS AND THE APPROVALS ISSUED BY THE CITY ENGINEER SHALL BE COMPLIED WITH IN EVERY DETAIL.
- 3. ALL ROADS DAMAGED BY CONSTRUCTION OPERATIONS ARE TO BE PATCHED OR RECONSTRUCTED AS DIRECTED BY THE CITY ENGINEER OR DESIGNEE.
- 4. THE CONTRACTOR SHALL TAKE STEPS NECESSARY TO PREVENT EROSION AND ANY OFF SITE SEDIMENT TRANSPORT RESULTING FROM INCREASED RUNOFF DURING CONSTRUCTION BY PROVIDING SILT FENCE AND/OR STAKED HAY BALES AS REQUIRED BY THE FLORIDA STORMWATER, EROSION, AND SEDIMENT CONTROL INSPECTOR'S MANUAL, JULY 2018 EDITION, OR AS INDICATED ON THE PLANS. ALL EROSION CONTROL MEASURES SHALL REMAIN IN PLACE UNTIL ASSOCIATED DISTURBED AREAS ARE STABILIZED AS TO REDUCE SEDIMENT RUNOFF, UNLESS OTHERWISE DIRECTED BY THE ENGINEER OR DESIGNEE.
- 5. ANY NECESSARY PERMITS WILL BE THE RESPONSIBILITY OF THE CONTRACTOR. CITY OF PENSACOLA OR ITS DESIGNEE WILL ASSIST CONTRACTOR WITH REQUIRED PERMITS.
- 6. THE CONTRACTOR IS CAUTIONED TO VISIT THE SITE AND FAMILIARIZE HIMSELF WITH THE PROJECT PRIOR TO BIDDING AND/OR CONSTRUCTION.
- 7. IT SHALL BE THE CONTRACTORS RESPONSIBILITY TO PRESERVE OR RELOCATE ALL BENCHMARKS (VERTICAL CONTROL) AS NEEDED DURING CONSTRUCTION. ALL PUBLIC OR PRIVATE CORNER MONUMENTATION SHALL BE PROTECTED. IF A PUBLIC OR PRIVATE CORNER MONUMENTATION IS IN DANGER OF BEING DESTROYED AND HAS NOT BEEN PROPERLY REFERENCED, THE CONTRACTOR SHALL NOTIFY THE ENGINEER OR DESIGNEE IMMEDIATELY. ANY ESCAMBIA COUNTY HARN/GPS NETWORK MONUMENTS OR BUREAU OF SURVEY AND MAPPING GPS NETWORK MONUMENTS WITHIN THE LIMITS OF CONSTRUCTION SHALL BE PROTECTED. IF A HARN/GPS NETWORK MONUMENTS OR BUREAU OF SURVEY AND MAPPING GPS NETWORK MONUMENTS ARE DISTURBED OR DESTROYED THE CONTRACTOR SHALL BE RESPONSIBLE FOR RELACEMENT OF THE MONUMENTS AND HAVE THE MONUMENTS POSITION DETERMINED BY A FLORIDA LICENSED PROFESSIONAL SURVEYOR AND MAPPER USING GUIDELINES AS ESTABLISHED BY NATIONAL GEODETIC SURVEY FOR BLUE BOOKING AND APPROVAL.
- 8. EXISTING DRAINAGE FEATURES WITHIN CONSTRUCTION LIMITS SHALL REMAIN UNLESS OTHERWISE NOTED.
- 9. THE CONTRACTOR SHALL MATCH EXISTING CONDITIONS AT THE BEGINNING AND END OF CONSTRUCTION AS DIRECTED BY THE CITY ENGINEER OR DESIGNEE.
- 10.EXISTING STREETS AND DRIVES SHALL BE MAINTAINED TO LOCAL TRAFFIC AND PROPERTY OWNERS.
- 11. ANY REFERENCE TO FDOT STANDARD SPECIFICATIONS FOR ROAD AND BRIDGE CONSTRUCTION, LATEST EDITION, DIVISION 1, GENERAL REQUIREMENTS AND COVENANTS, SHALL BE EXCLUDED AND NOT APPLICABLE TO ANY SPECIFICATION REFERRED HEREIN OR OTHERWISE LISTED IN THESE PLANS OR RELATED DOCUMENTS.
- 12. CONTRACTOR SHALL COMPLY WITH ALL F.D.E.P. AND ARMY CORP. OF ENGINEERS REQUIREMENTS. THE PROJECT IS PERMITTED BY FDEP (GEN-xxx-xxxxxx-x)

- 13. ONLY ACCESS TO THE EASEMENTS AS SHOWN ARE GUARANTEED BY THE CITY. PRIVATE R/W REQUIRED BY THE CONTRACTOR TO FACILITATE CONSTRUCTION SHALL BE ACQUIRED BY THE CONTRACTOR WITH NO ADDITIONAL COMPENSATION OR ASSISTANCE FROM THE CITY.
- 14.IN THE EVENT THAT SURVEY MONUMENTATION OR REFERENCE POINTS ARE MISSING OR HAVE BEEN DESTROYED, PLEASE CONTACT:

ROBERT SCOTT MILLS BASKERVILLE-DONOVAN INC. 449 W. MAIN ST. PENSACOLA, FL 32502

- 15. DIRECT SPECIAL ATTENTION TO THE PROTECTION OF ALL GEODETIC MONUMENTS, HORIZONTAL OR VERTICAL, AND PUBLIC LAND SURVEY CORNERS LOCATED WITHIN THE PROJECT. IF ANY GEODETIC MONUMENT OR PUBLIC LAND SURVEY CORNER, LOCATED WITHIN THE PROJECT, IS AT RISK OF BEING DAMAGEDOR DESTROYED, IMMEDIATELY NOTIFY THE CITY ENGINEER OR DESIGNEE. IN ADDITION, CONTACT JOE BARRETT, ESCAMBIA COUNTY SURVEYOR, TO OBTAIN APPROVAL TO LOCATE AND REPLACE ANY DAMAGED OR DESTROYED GEODETIC MONUMENTS OR PUBLIC LAND SURVEY CORNERS UNDER THE DIRECTION OF A PROFESSIONAL SURVEYOR AND MAPPER REGISTERED IN THE STATE OF FLORIDA.
- 16. VEGETATION ON R/W AND EASEMENTS SHALL BE RESTORED TO ORIGINAL CONDITION UNLESS OTHERWISE NOTED ON THE PLAN SHEETS. COST OF SAID RESTORATION SHALL BE CONSIDERED INCIDENTAL TO OTHER PAY ITEMS.
- 17. ALL COMPACTED FILL SHALL BE PLACED IN 4" LIFTS FOR HAND POWERED TAMPERS AND 8" LIFTS FOR HEAVY EQUIPMENT OPERATED TAMPERS.
- 18. PIPE LENGTHS SHOWN IN THE PLANS DO NOT INCLUDE THE LENGTH OF PIPE THAT MUST BE INSTALLED WITH THE MITERED END SECTION. THEREFORE, ALL PIPES LENGTHS ASSOCIATED WITH MITERED END NATURAL GAS: SECTIONS SHALL BE PAID FOR IN THE UNIT COST OF THE MITERED END SECTION.
- 19.IF ARCHAEOLOGICAL MATERIAL/PREHISTORIC ARTIFACTS SUCH AS POTTERY OR CERAMICS, STONE TOOLS OR METAL IMPLEMENTS, OR ANY OTHER PHYSICAL REMAINS THAT COULD BE ASSOCIATED WITH NATIVE AMERICAN CULTURES, OR EARLY COLONIAL OR AMERICAN SETTLEMENT ARE ENCOUNTERED AT ANY TIME, THE PROJECT SHOULD CEASE ALL ACTIVITIES INVOLVING SUBSURFACE DISTURBANCE IN THE IMMEDIATE VICINITY OF SUCH DISCOVERIES. THE APPLICANT/RECIPIENT, OR OTHER DESIGNEE, SHOULD CONTACT THE CITY OF PENSACOLA HISTORIC PRESERVATION PLANNER, FLORIDA DEPARTMENT OF STATE, DIVISION OF HISTORICAL RESOURCES, THE STATE HISTORIC PRESERVATION OFFICER (SHPO), THE DSH/FEMA REGION IV ENVIRONMENTAL OFFICER AND FDEM STATE ENVIRONMENTAL LIAISON OFFICER FOR FURTHER GUIDANCE. PROJECT ACTIVITIES SHOULD NOT RESUME WITHOUT VERBAL AND/OR WRITTEN AUTHORIZATION FROM THE DIVISION OF HISTORICAL RESOURCES.
- 20. THE APPLICANT/RECIPIENT, OR OTHER DESIGNEE, SHALL CONTACT THE DISTRICT 1 MEDICAL EXAMINER'S OFFICE AND THE CITY OF PENSACOLA HISTORIC PRESERVATION PLANNER IN THE EVENT THAT UNMARKED HUMAN REMAINS ARE ENCOUNTERED DURING PERMITTED ACTIVITIES; ALL WORK MUST STOP IMMEDIATELY AND THE PROPER AUTHORITIES NOTIFIED IN ACCORDANCE WITH F.S. 872.05.

UTILITY NOTES:

- 1. THE LOCATION SHOWN FOR EXISTING UNDERGROUND UTILITIES IS APPROXIMATE. THE CONTRACTOR SHALL DETERMINE THE EXACT LOCATION OF ALL EXISTING UTILITIES BEFORE COMMENCING WORK IN EACH AREA. THE CONTRACTOR AGREES TO BE COMPLETELY RESPONSIBLE FOR ALL DAMAGES WHICH MIGHT OCCUR BY HIS FAILURE TO EXACTLY LOCATE AND PRESERVE ALL UTILITIES.
- 2. UTILITY OWNERS SHALL BE NOTIFIED AT LEAST 48 HOURS PRIOR TO ANY CONSTRUCTION SO THAT THE UTILITY OWNER CAN SPOT VERIFY AND/OR EXPOSE THEIR UTILITIES. KNOWN UTILITIES OWNERS ACCORDING TO THE SUNSHINE ONE CALL INCLUDE:

WATER/SEWER:

EMERALD COAST UTILITY AUTHORITY

BRANDON KNIGHT

P.O. BOX 15311 PENSACOLA, FL. 32514 PH: (850) 969-3310 BKNIGHT@ECUA.ORG

ELECTRIC: **GULF POWER**

> **CHAD SWAILS** 5120 DOGWOOD DRIVE

MILTON, FL 32570 PH: (850) 429-2446 CHAD.SWAILS@NEXTERAENERGY.COM

AT&T FLORIDA TELEPHONE:

> JONATHON BLANKENCHIP 605 WEST GARDEN STREET

PENSACOLA, FL 32502 PH: (850) 624-7093

JB966P@ATT.COM

COX COMMUNICATION:

TROY YOUNG 3405 MCLEMORE DR

PENSACOLA, FL 32514 PH: (850) 857-4510.

TROY.YOUNG@COX.COM

PENSACOLA ENERGY DIANE MOORE 1625 ATWOOD DRIVE

PENSACOLA, FL 32514 PH: (850) 474-5319 DMOORE@CITYOFPENSACOLA.COM

SUNSHINE STATE ONE-CALL

7200 LAKE ELLENOR DRIVE, SUITE 200 ORLANDO, FL. 32809 PH: (800) 432-4770

- 3. CONTRACTOR IS TO USE CAUTION WHEN WORKING IN OR AROUND AREAS OF OVERHEAD TRANSMISSION LINES AND UNDERGROUND UTILITIES.
- 4. UTILITIES TO REMAIN AND BE PROTECTED DURING CONSTRUCTION. NECESSARY REPAIRS SHALL BE CONSIDERED INCIDENTAL TO OTHER PAY ITEMS AND SHALL BE TO THE SATISFACTION OF UTILITY OWNERS.



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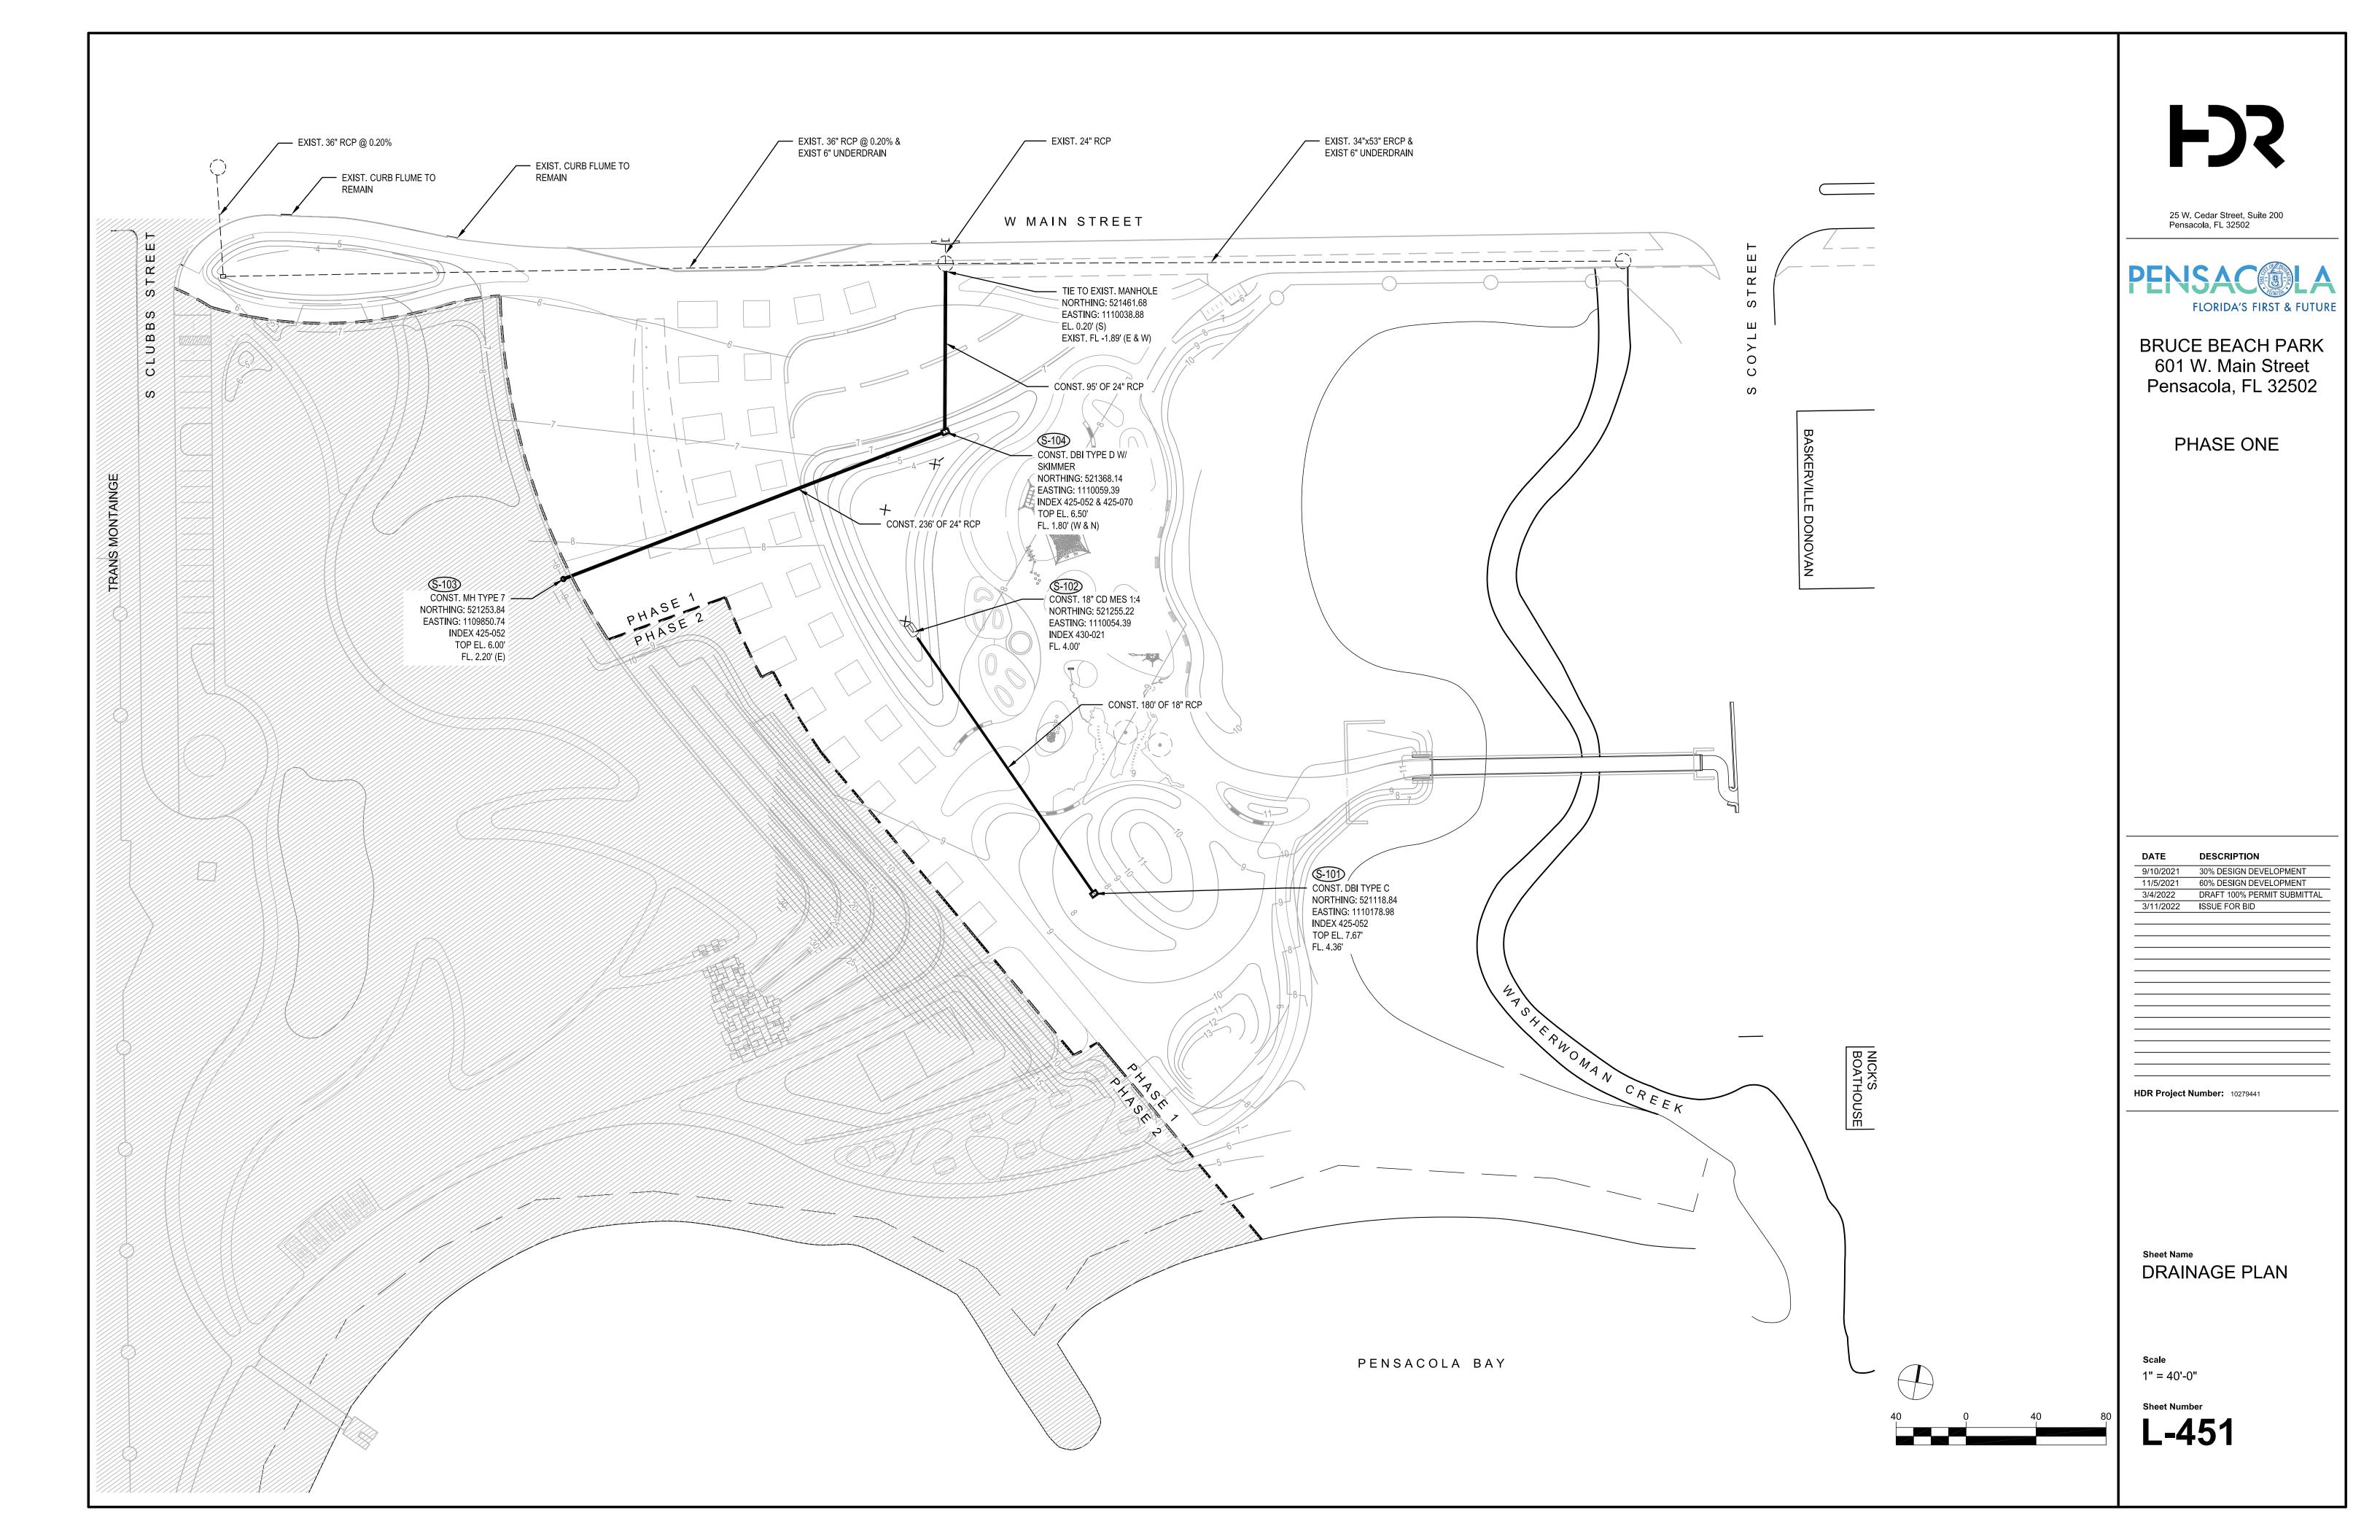
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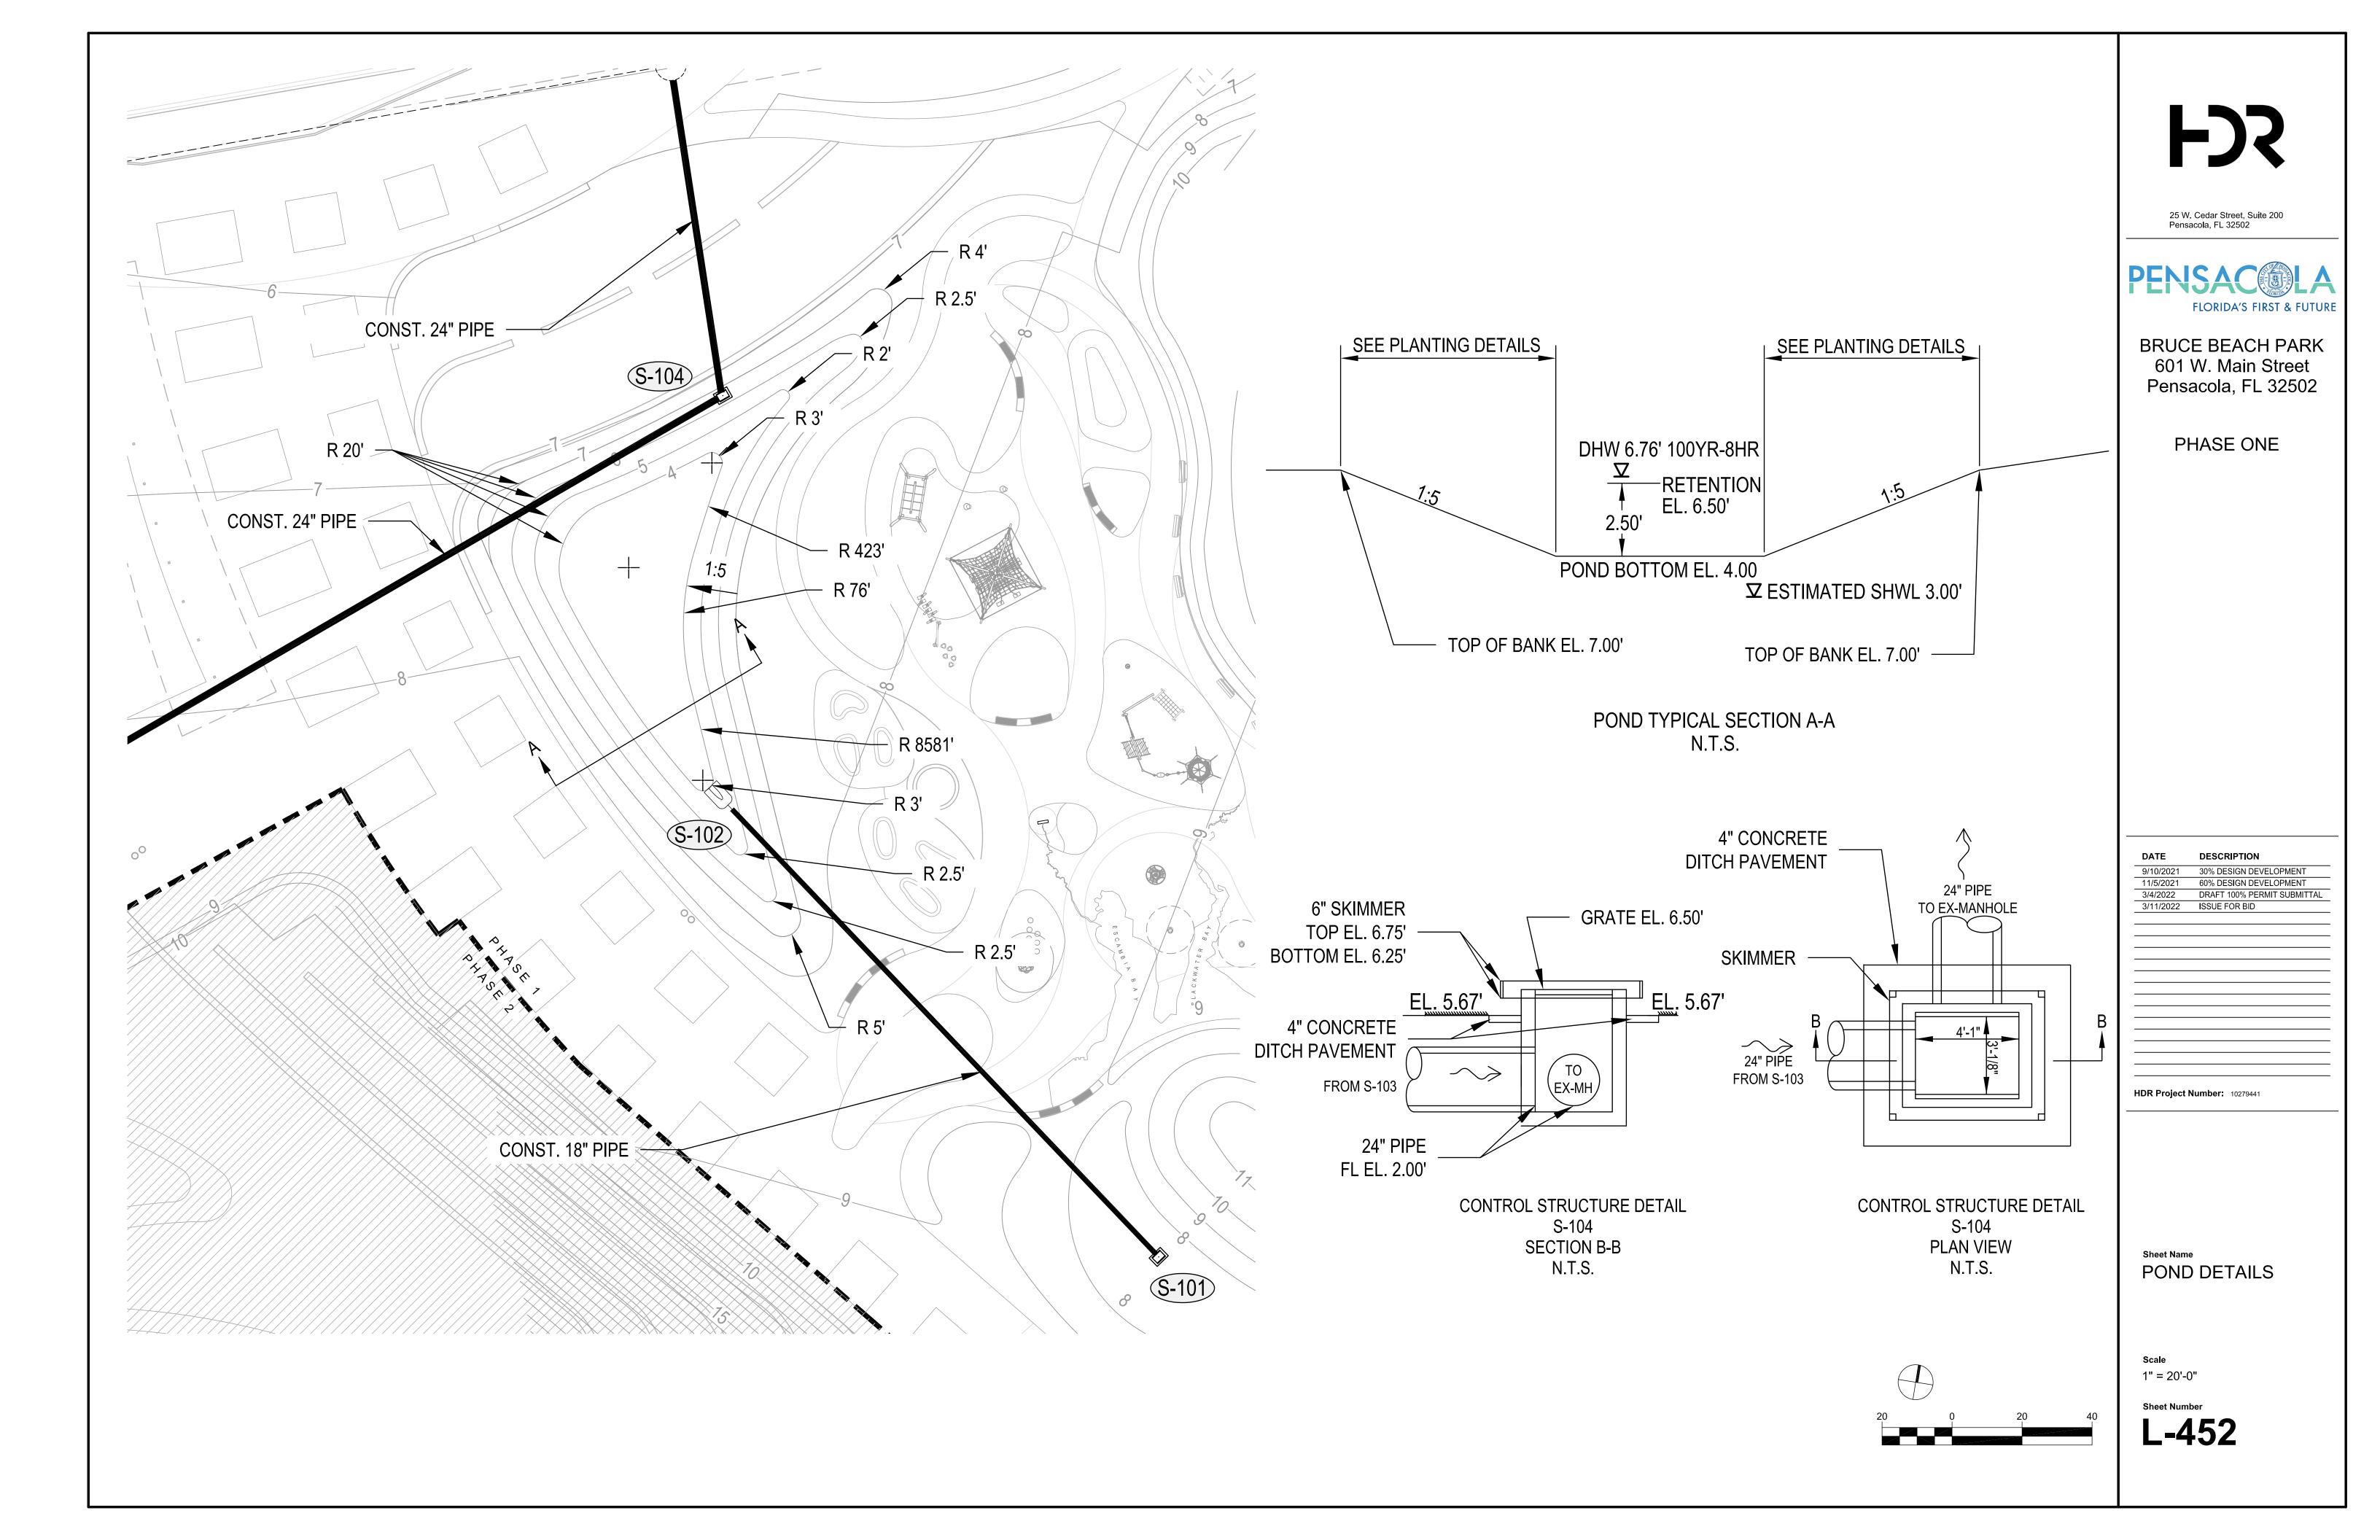
PHASE ONE

DESCRIPTION 9/10/2021 30% DESIGN DEVELOPMENT 11/5/2021 60% DESIGN DEVELOPMENT 3/4/2022 DRAFT 100% PERMIT SUBMITTAL
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DRAINAGE NOTES





SITE-SPECIFIC EROSION AND SEDIMENT CONTROL PLAN

THE CONTRACTOR'S PROFESSIONAL ENGINEER (PE), OR CERTIFIED PROFESSIONAL IN EROSION AND SEDIMENT CONTROL (CPESC) WILL PREPARE AND SUBMIT A SITE-SPECIFIC EROSION AND SEDIMENT CONTROL PLAN TO CITY OF PENSACOLA FOR REVIEW AND APPROVAL PRIOR TO ANY WORK BEING PERFORMED. THE EROSION AND SEDIMENT CONTROL PLAN SHALL FOLLOW GUIDELINES DOCUMENTED IN THE STATE OF FLORIDA, EROSION AND SEDIMENT CONTROL - DESIGNER AND REVIEWER MANUAL, DATED JUNE 2007, UPDATED 2013 (http://www.fdot.govroadway/drainage/files/Erosion-Sediment-Control.pdf).

AT A MINIMUM, THE EROSION AND SEDIMENT CONTROL PLANS FOR THIS PROJECT REQUIRE SEDIMENT BARRIER TO BE PLACED WHERE THERE IS POTENTIAL FOR TURBID STORMWATER RUNOFF TO DISCHARGE OFF-SITE. INLET PROTECTION IS REQUIRED FOR ALL INLETS THAT COULD RECEIVE RUNOFF FROM DISTURBED AREAS. ARTIFICIAL COVERINGS AND TEMPORARY SLOPE DRAINS ARE REQUIRED IN AREAS WITH HIGH SLOPES. RUNOFF CONTROL STRUCTURES WILL BE REQUIRED WITHIN ALL CHANNELS. A SOIL TRACKING PREVENTION DEVICE SHALL BE INSTALLED AT POINTS OF EGRESS FROM UN-STABLIZED AREAS OF THE PROJECT TO PUBLIC ROADS WHERE OFF-SITE TRACKING OF MUD COULD OCCUR.

PAY PARTICULAR ATTENTION TO THE PROTECTION OF UPLAND BUFFERS, NON-IMPACTED WETLANDS, AND SURFACE WATERS ADJACENT TO THE LIMITS OF WORK TO PREVENT TURBID DISCHARGES TO THESE AREAS.

THE MEASURES LISTED ABOVE AND SHOWN ON THE PLANS ARE THE MINIMUM REQUIREMENTS WITH ADDITIONAL CONTROLS TO BE UTILIZED AS NEEDED, DEPENDENT UPON ACTUAL SITE CONDITIONS AND CONSTRUCTION OPERATIONS AND PHASING.

1. SITE DESCRIPTION:

CONSTRUCTION ACTIVITY INCLUDES NEW CONSTRUCTION, STORM SEWER, SITE GRADING, SIDEWALK, PLAY GROUND AMENITIES, AND SEDIMENT BASIN GRADING.

PROJECT LIMITS:

THE PROJECT IS LOCATED SOUTH OF MAIN STREET BETWEEN CLUBBS STREET AND S COYLE STREET IN PENSACOLA, FLORIDA

CONSTRUCTION OF SIDEWALKS, PLAYGROUND EQUIPMENT, PARK AMENITIES, AND STORMWATER MANAGEMENT FACILITIES.

THE MAJOR SOIL DISTURBING ACTIVITIES INCLUDE SITE GRADING.

TOTAL AREA TO BE DISTURBED: TOTAL SITE AREA: 7.63 AC TOTAL IMPERVIOUS AREA: 2.88 AC TOTAL PERVIOUS AREA: 4.75 AC

RUNOFF COEFFICIENTS:

C= 0.35 (BEFORE)

C= 0.50 (DURING) C= 0.55 (AFTER)

(2) ESTIMATES OF SIZE OF PROJECT AREA FOR EACH OUTFALL:

WASHERWOMANS CREEK - TOTAL AREA 8.25 ACRES (INCLUDES OFFSITE FLOWS ROUTED THROUGH PROJECT AREA)

(3) LOCATIONS OF OUTFALLS:

POND OUTFALL: LAT N33° 35' 23", LONG. W79° 00' 38" (WASHERWOMANS CREEK)

(4) DESCRIPTION OF SOIL OR QUALITY OF DISCHARGE:

SOILS ARE PRIMARILY ARENTS-URBAN LAND COMPLEX.

THE CONSTRUCTION PLANS SHALL BE USED FOR THE SITE MAP.

2. CONTROLS:

TEMPORARY EROSION CONTROL MEASURES ARE SHOWN ON THE EROSION CONTROL PLANS AND PERMANENT EROSION CONTROL MEASURES ARE SHOWN IN THE CONSTRUCTION PLANS.

a. EROSION AND SEDIMENT CONTROLS:

(1) STABILIZATION PRACTICES: X TEMPORARY SODDING X ARTIFICIAL COVERING X BUFFER ZONES TEMPORARY GRASSING

PRESERVATION OF NATURAL RESOURCES X PERMANENT PLANTING, SODDING, OR SEEDING TEMPORARY MULCHING

-LOCATION OF ARTIFICIAL COVERING IS TO BE DETERMINED BASED ON SITE CONDITIONS -THIS LIST MAY NOT INCLUDE ALL MEASURES BASED ON ACTUAL SITE CONDITIONS

STABILIZATION MEASURES SHALL BE INITIATED AS SOON AS PRACTICAL, BUT IN NO CASE MORE THAN 14 DAYS, IN PORTIONS OF THE SITE WHERE CONSTRUCTION ACTIVITIES HAVE TEMPORARILY OR PERMANENTLY CEASED.

OTHER:

THE CONTRACTOR IS ALSO RESPONSIBLE FOR DOCUMENTING THIS PORTION OF THE SWPPP IN THE EROSION CONTROL PLAN SUBMITTED TO THE CITY.

(2) STRUCTURAL PRACTICES:

X INLET PROTECTION

SEDIMENT TRAPS SAND BAGGING X SEDIMENT BARRIER X SEDIMENT BASINS ____ STORM INLET SEDIMENT TRAP __SYNTHETIC BALES X BERMS STONE OUTLET STRUCTURES DIVERSION, INTERCEPTOR, OR PERIMETER DITCHES CURBS AND GUTTERS X PIPE SLOPE DRAINS _X_ STORM SEWERS _____ VELOCITY CONTROL DEVICES FLUMES _χ_FLOATING TURBIDITY BARRIER X ROCK BEDDING AT CONSTRUCTION EXIT X RIPRAP TIMBER BEDDING AT CONSTRUCTION EXIT X WATTLES X RUNOFF CONTROL STRUCTURE

LOCATIONS OF SEDIMENT BASINS, STORM DRAINS, AND RIP RAP ARE SHOWN ON THE CONSTRUCTION PLANS. THIS LIST MAY NOT INCLUDE ALL CONTROL MEASURES. ACTUAL SITE CONDITIONS MAY REQUIRE ADDITIONAL CONTROL MEASURES.

SEDIMENT BARRIER WILL BE USED TO PROTECT ALL UNDISTURBED WETLANDS.

OTHER:

THE CONTRACTOR IS ALSO RESPONSIBLE FOR DOCUMENTING THIS PORTION OF THE SWPPP IN THE EROSION CONTROL PLAN SUBMITTED TO THE CITY.

b. DESCRIPTION OF SEDIMENT BASINS:

THERE ARE 3 SEDIMENT BASIN FACILITIES TO BE CONSTRUCTED WITH THIS PROJECT. ONE IN PHASE I, TWO IN PHASE 2.

(1) WASTE DISPOSAL:

c. OTHER CONTROLS

THE CONTRACTOR IS SOLELY RESPONSIBLE FOR DOCUMENTING THIS PORTION OF THE SWPPP IN THE EROSION CONTROL PLAN SUBMITTED TO THE CITY.

(2) OFFSITE VEHICLE TRACKING:

X HAUL ROADS DAMPENED FOR DUST CONTROL X LOADED HAUL TRUCKS TO BE COVERED WITH TARPAULIN

X EXCESS DIRT ON ROAD REMOVED DAILY X STABILIZED CONSTRUCTION ENTRANCES

THE CONTRACTOR IS ALSO RESPONSIBLE FOR DOCUMENTING THIS PORTION OF THE SWPPP IN THE EROSION CONTROL PLAN SUBMITTED TO THE CITY.

(3) SANITARY WASTE:

THE CONTRACTOR IS SOLELY RESPONSIBLE FOR DOCUMENTING THIS PORTION OF THE SWPPP IN THE EROSION CONTROL PLAN SUBMITTED TO THE CITY.

(5) TOXIC SUBSTANCES (INCLUDING SPILL REPORTING):

- THE CONTRACTOR IS RESPONSIBLE FOR DOCUMENTING THIS PORTION OF THE SWPPP IN THE EROSION CONTROL PLAN SUBMITTED TO THE CITY. IF CONTAMINATED SOIL OR GROUNDWATER IS
- ENCOUNTERED, CONTACT THE CITY PROJECT MANAGER IMMEDIATELY.

d. FEDERAL, STATE, AND LOCAL PLANS, AND PERMITS:

- FLORIDA DEPARTMENT OF ENVIRONMENTAL PROTECTION, ERP PERMIT IS ANTICIPATED.
- FDEP NPDES GENERIC PERMIT FOR STORMWATER DISCHARGE FROM CONSTRUCTION SITE,
- (CH 62-621 FAC) TO BE OBTAINED BY THE CONTRACTOR

3. MAINTENANCE:

MAINTENANCE OF PERMANENT AND TEMPORARY FEATURES SHALL BE DONE IN ACCORDANCE WITH THE CITY OF PENSACOLA SPECIFICATIONS.


THE CONTRACTOR IS ALSO RESPONSIBLE FOR DOCUMENTING THIS PORTION OF THE SWPPP IN THE EROSION CONTROL PLAN SUBMITTED TO THE CITY.

4. INSPECTION:

- THE CONTRACTOR IS SOLELY RESPONSIBLE FOR INSPECTIONS OF EROSION CONTROL FEATURES. QUALIFIED PERSONNEL SHALL INSPECT THE FOLLOWING ITEMS AT LEAST ONCE EVERY SEVEN CALENDAR DAYS AND WITHIN 24 HOURS OF THE END OF A STORM THAT IS 0.25 INCHES OR GREATER. WHERE SITES HAVE BEEN FINALLY STABILIZED, INSPECTIONS SHALL BE CONDUCTED AT LEAST ONCE EVERY MONTH.
- -POINTS OF DISCHARGE FROM THE PROJECT SITE
- -DISTURBED AREAS OF THE SITE THAT HAVE NOT BEEN FINALLY STABILIZED
- -AREAS USED FOR STORAGE OF MATERIALS THAT ARE EXPOSED TO PRECIPITATION
- -STRUCTURAL CONTROLS -SEDIMENT BASINS
- -LOCATIONS WHERE VEHICLES ENTER OR EXIT THE SITE

5. NON-STORMWATER ACTIVITIES:

THE CONTRACTOR IS RESPONSIBLE FOR OBTAINING ALL DEWATERING PERMITS AND IDENTIFYING ALL ANTICIPATED NON-STORMWATER DISCHARGES.

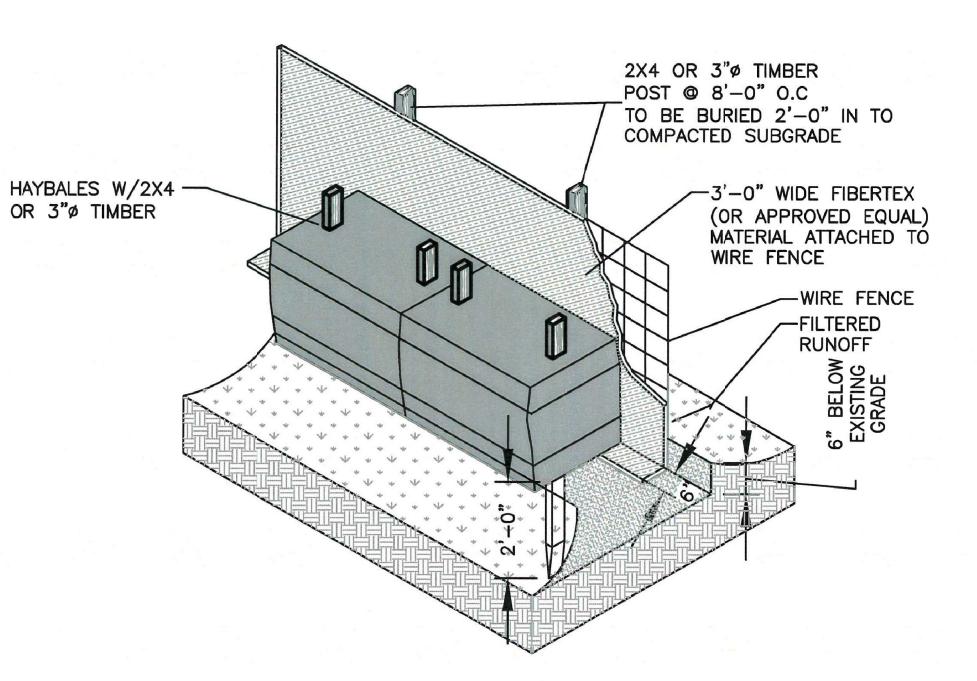

NOTE: AT THE COMPLETION OF THE PROJECT AND AFTER SOIL STABILIZATION AND VEGETATIVE GROWTH HAVE BEEN ASSURED, THE SILT FENCE MUST BE COMPLETELY REMOVED AND THE EMBEDMENT TRENCH RESTORED TO A NATURAL CONDITION.

HAYBALES & SILT FENCE DETAIL SCALE: N.T.S.



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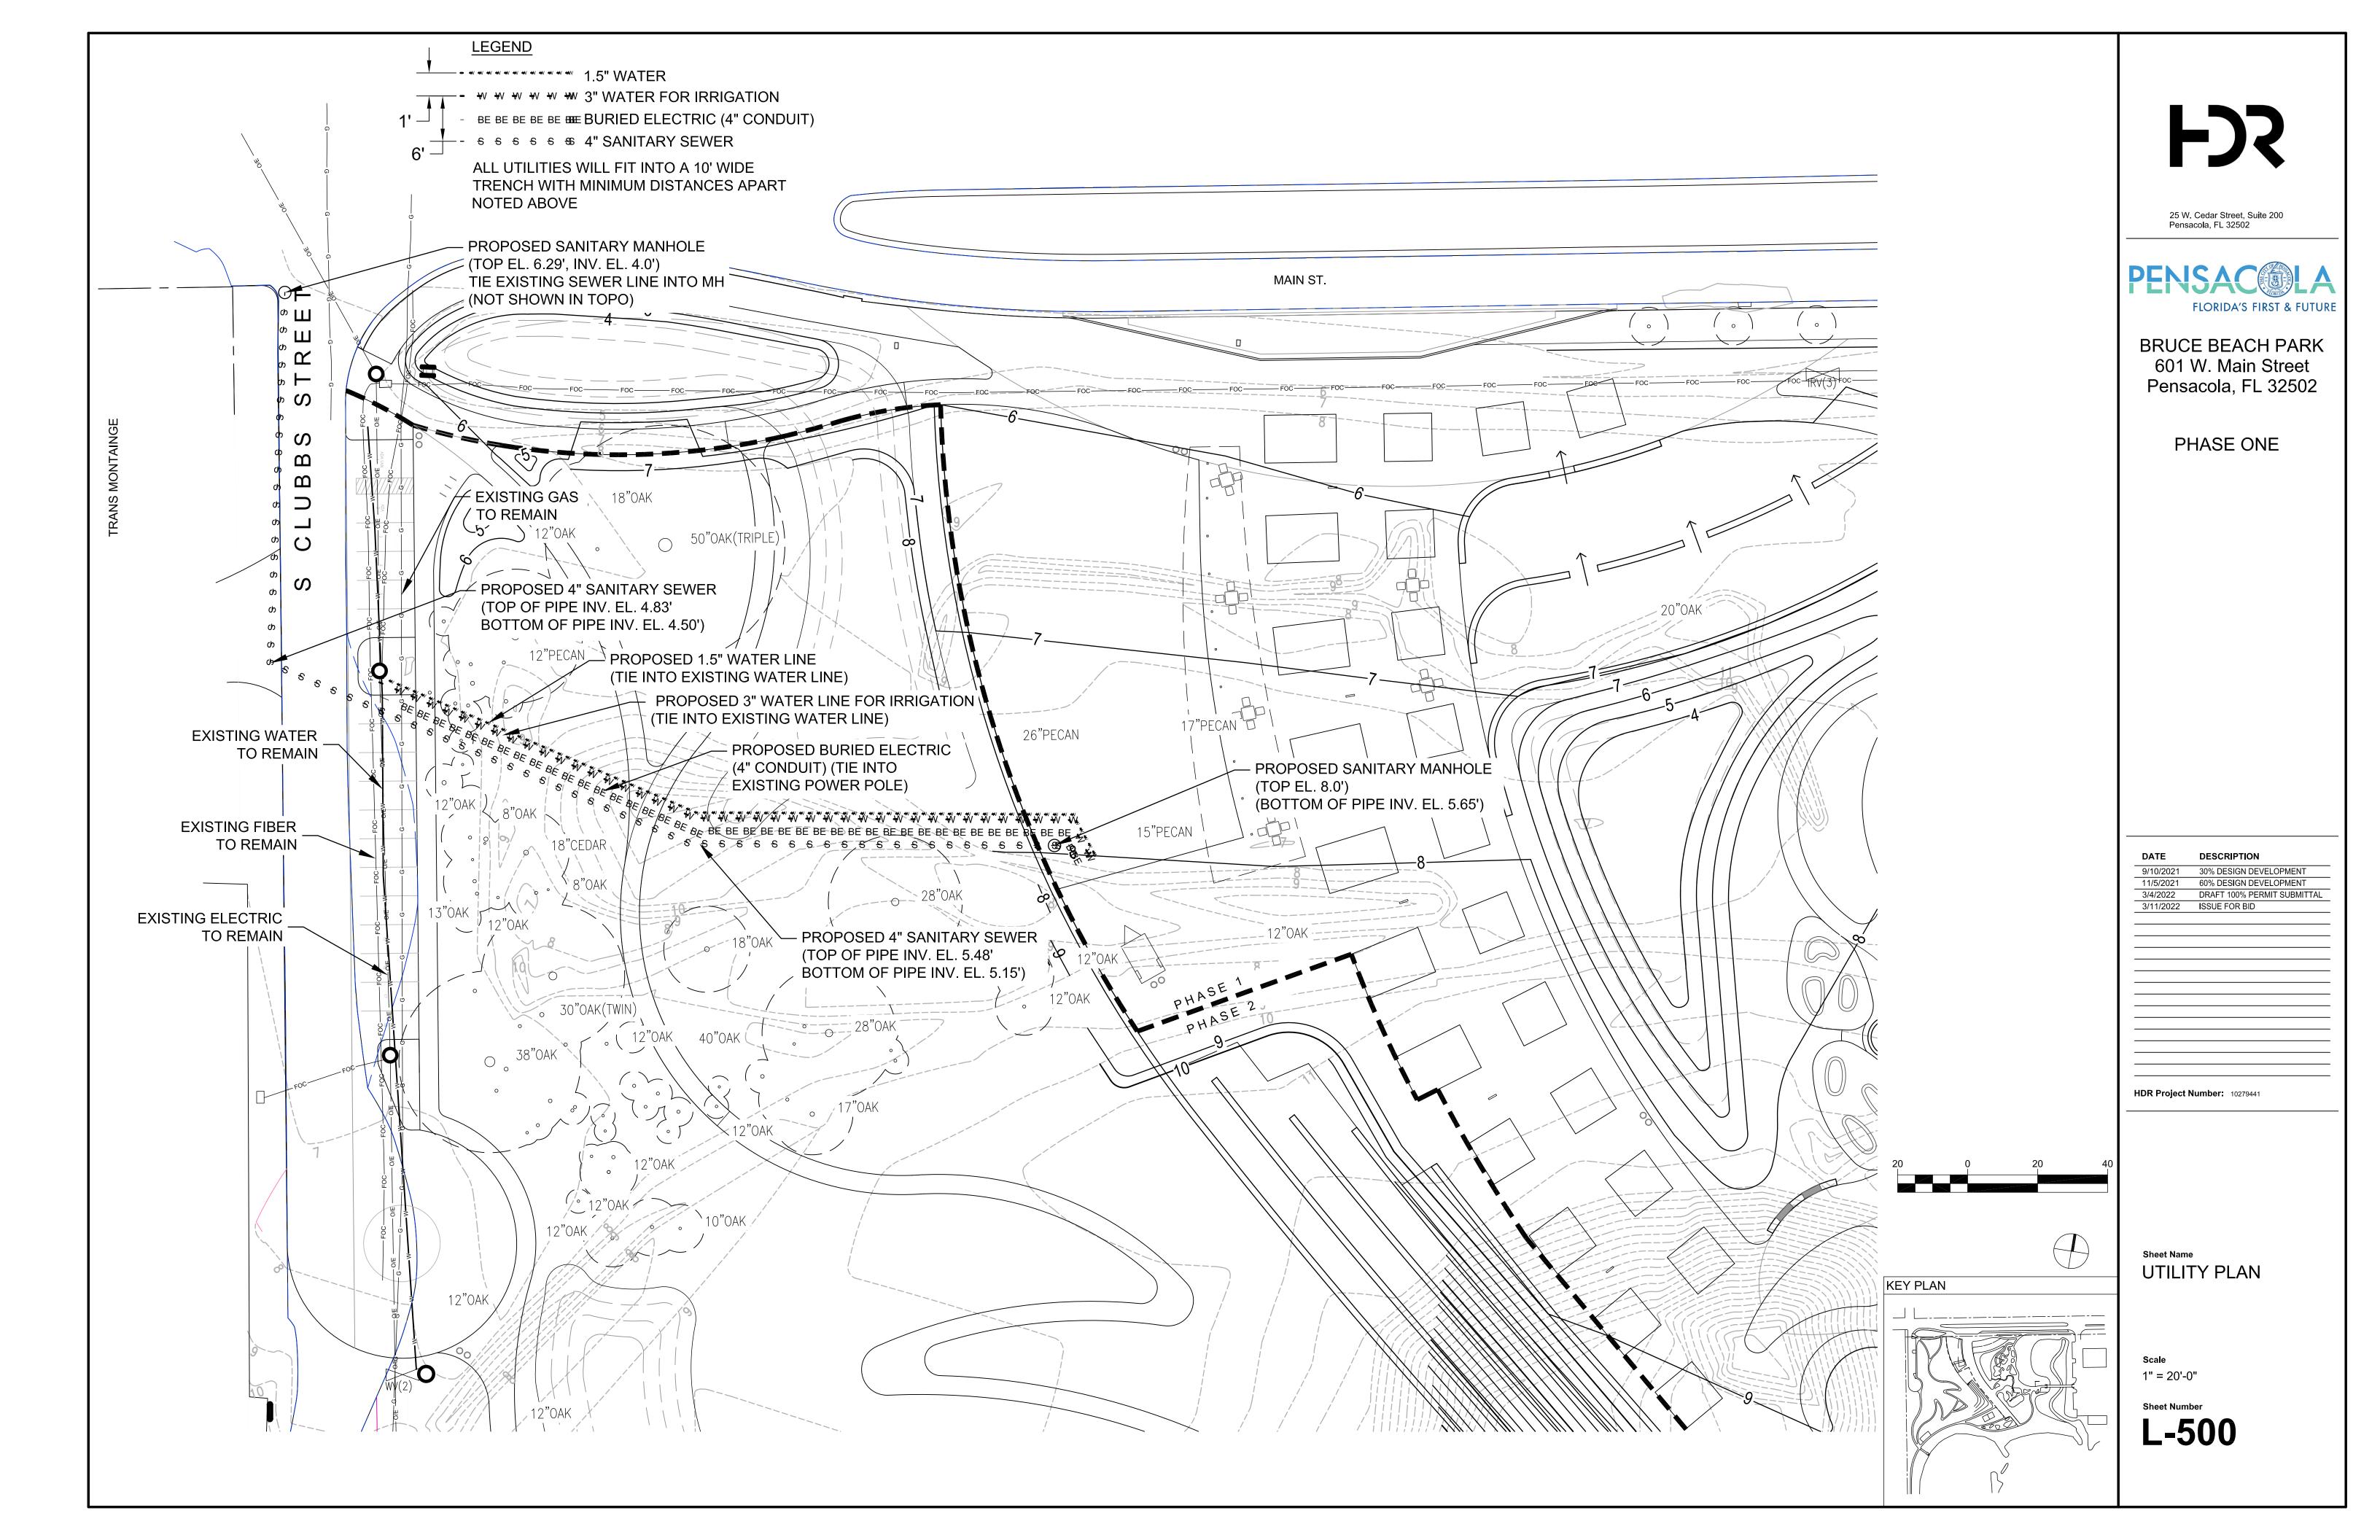
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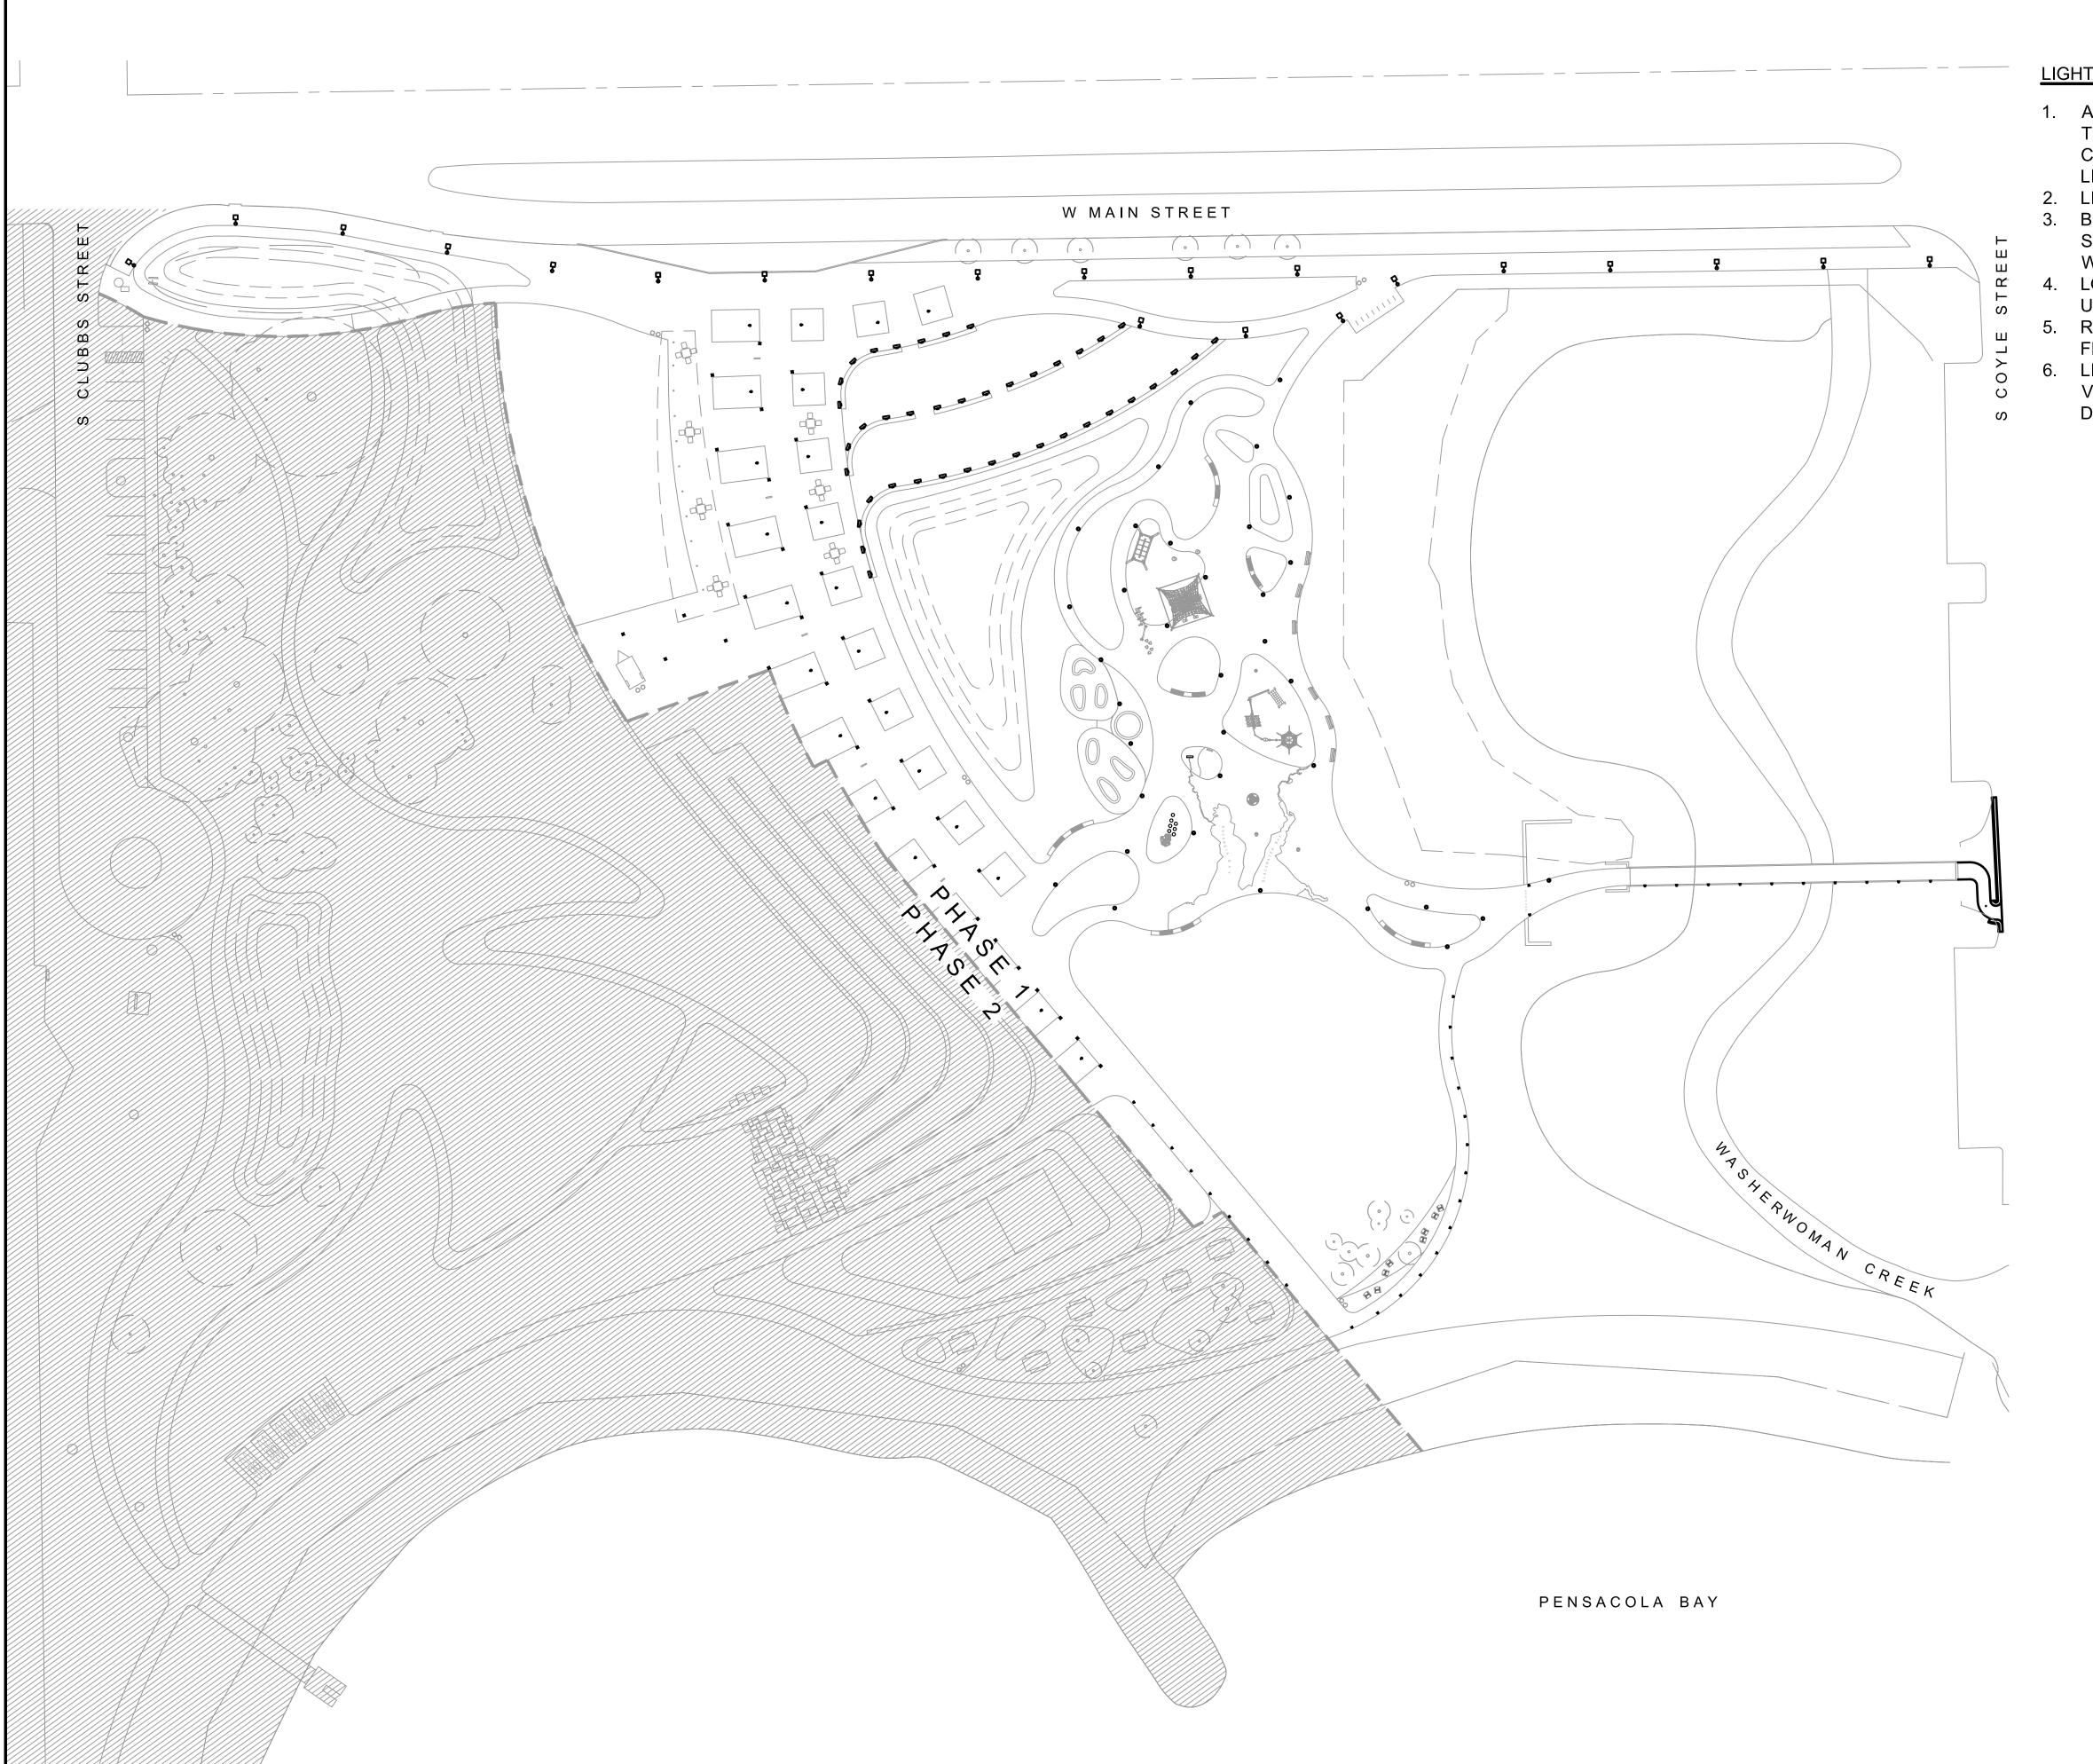
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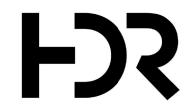
Sheet Name STORMWATER POLLUTION PREVENTION PLAN





LIGHTING NOTES

- 1. ALL LIGHT FIXTURES TO BE CERTIFIED BY THE FLORIDA FISH AND WILDLIFE CONSERVATION COMMISSION'S WILDLIFE LIGHTING CERTIFICATION PROGRAM.
- 2. LIGHT MUST BE DOWNWARD DIRECTED.
- 3. BEACHSIDE SHIELDS AND/OR LOUVERS SHALL BE USED FOR ANY FIXTURE WITHIN LINE OF SIGHT OF THE BEACH.
- LONG-WAVELENGTH LIGHTS SHALL BE USED TO PROTECT SEA TURTLES.
- 5. REFER TO SHEET L-650 FOR LIGHTING FIXTURE SCHEDULE.
- 6. LIGHT FIXTURES SHALL BE CONTROLLED VIA PHOTOSENSOR TO OPERATE FROM DUSK TO DAWN.



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BRUCE BEACH PARK 601 W. Main Street Pensacola, FL 32502


PHASE ONE

DATE	DESCRIPTION
9/10/2021	30% DESIGN DEVELOPMENT
11/5/2021	60% DESIGN DEVELOPMENT
3/4/2022	DRAFT 100% PERMIT SUBMITTAL
3/11/2022	ISSUE FOR BID

HDR Project Number: 10279441

Sheet Name
SITE LIGHTING OVERALL PLAN
AND GENERAL
NOTES

Scale

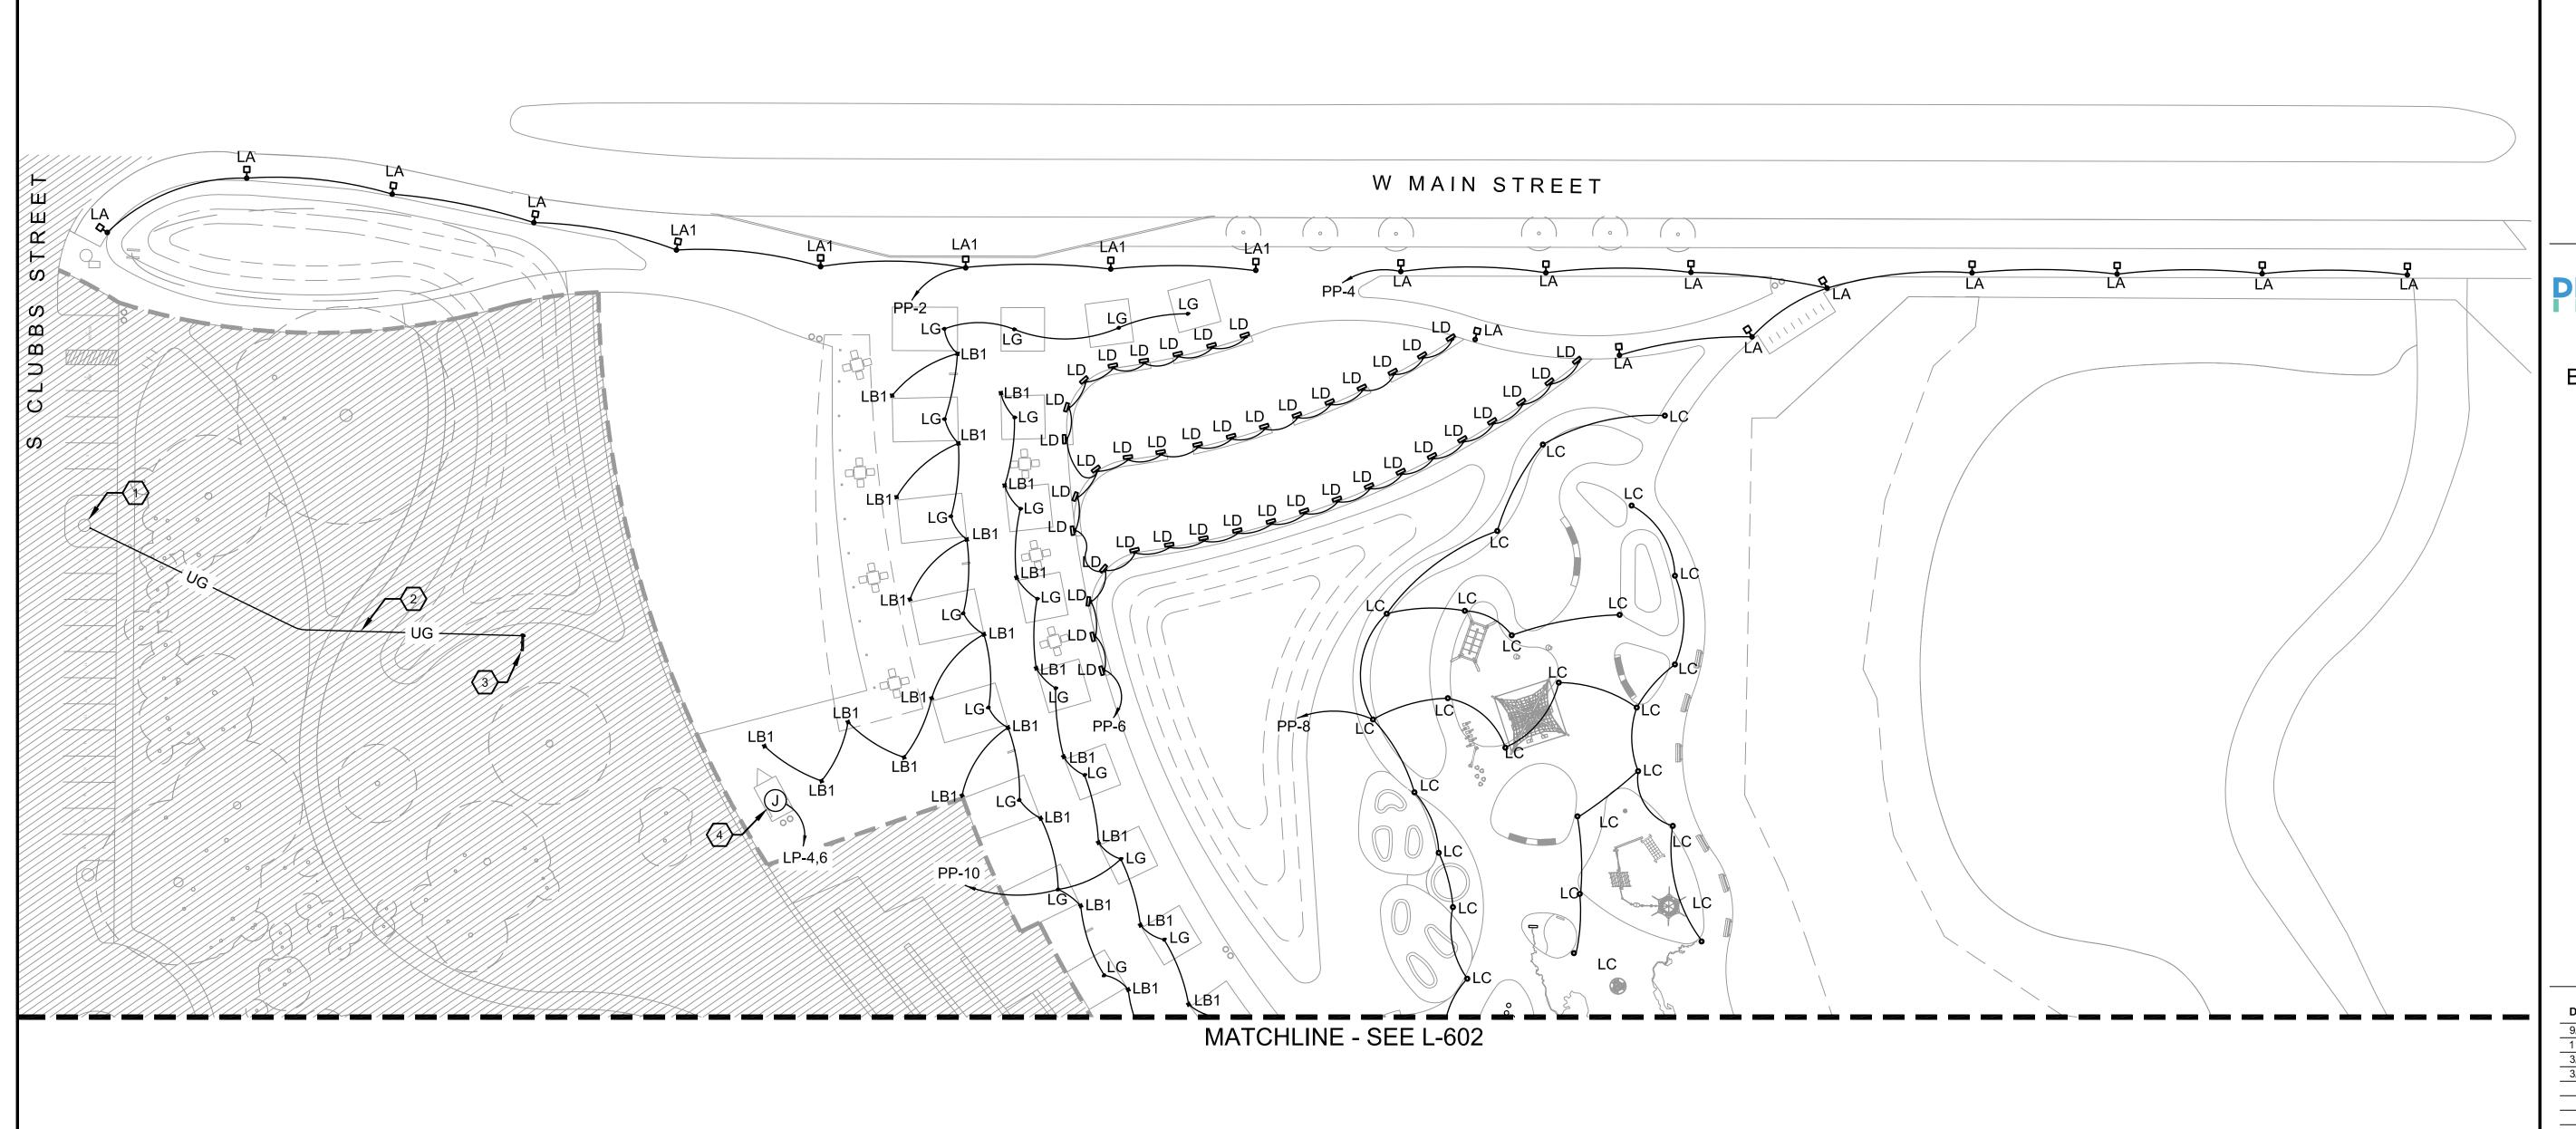





BRUCE BEACH PARK 601 W. Main Street Pensacola, FL 32502

PHASE ONE

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LIGHTING FIXTURES

LA, LA1: PARKING LOT & SIDEWALK -LUMEC, METROSCAPE



LB, LB1: MARKER LIGHT -



C LC: PLAYGROUND LIGHT - LITHONIA, KBR8



LD: WALL/STEP LIGHT -



LG: TREE UPLIGHT



KEY NOTES: (#)

TO DAWN.

LIGHTING NOTES

2. LIGHT MUST BE DOWNWARD DIRECTED.

- EXISTING UTILITY COMPANY POWER POLE WITH OVERHEAD 3-PHASE PRIMARY.
 CONTRACTOR TO COORDINATE WITH UTILITY COMPANY FOR THE INSTALLATION OF A
 480/277 VOLT, 3-PHASE TRANSFORMER BANK. CONTRACTOR TO PROVIDE CONDUIT AND
 HARDWARE ON POLE AS REQUIRED FOR OVERHEAD TO UNDERGROUND 3-PHASE
 SECONDARY SERVICE.
- 2. NEW UNDERGROUND SECONDARY SERVICE BY CONTRACTOR. SEE ONE-LINE DIAGRAM FOR WIRE AND CONDUIT SIZE. CONTRACTOR TO COORDINATE ROUTE OF TRENCHING TO AVOID DISTURBANCE OF EXISTING TREES.
- 3. ELECTRICAL EQUIPMENT RACK, SEE DETAIL SHEET L-651.
- 4. CONNECTION TO CIRCUITS IN RESTROOM, COORDINATE EXACT LOCATION.

1. ALL LIGHT FIXTURES TO BE CERTIFIED BY THE FLORIDA FISH AND WILDLIFE


4. LONG-WAVELENGTH LIGHTS SHALL BE USED TO PROTECT SEA TURTLES.

5. REFER TO SHEET L-650 FOR LIGHTING FIXTURE SCHEDULE.

CONSERVATION COMMISSION'S WILDLIFE LIGHTING CERTIFICATION PROGRAM.

3. BEACHSIDE SHIELDS AND/OR LOUVERS SHALL BE USED FOR ANY FIXTURE WITHIN LINE


6. LIGHT FIXTURES SHALL BE CONTROLLED VIA PHOTOSENSOR TO OPERATE FROM DUSK

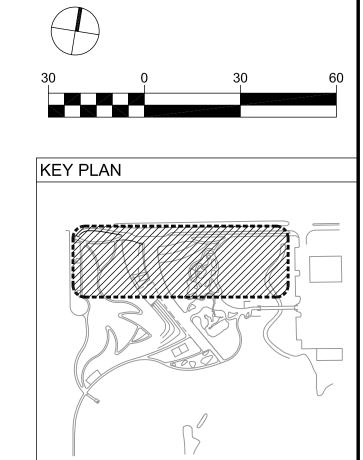

SITE LIGHTING -AREA 1

HDR Project Number: 10279441

Scale 1" = 30'-0"

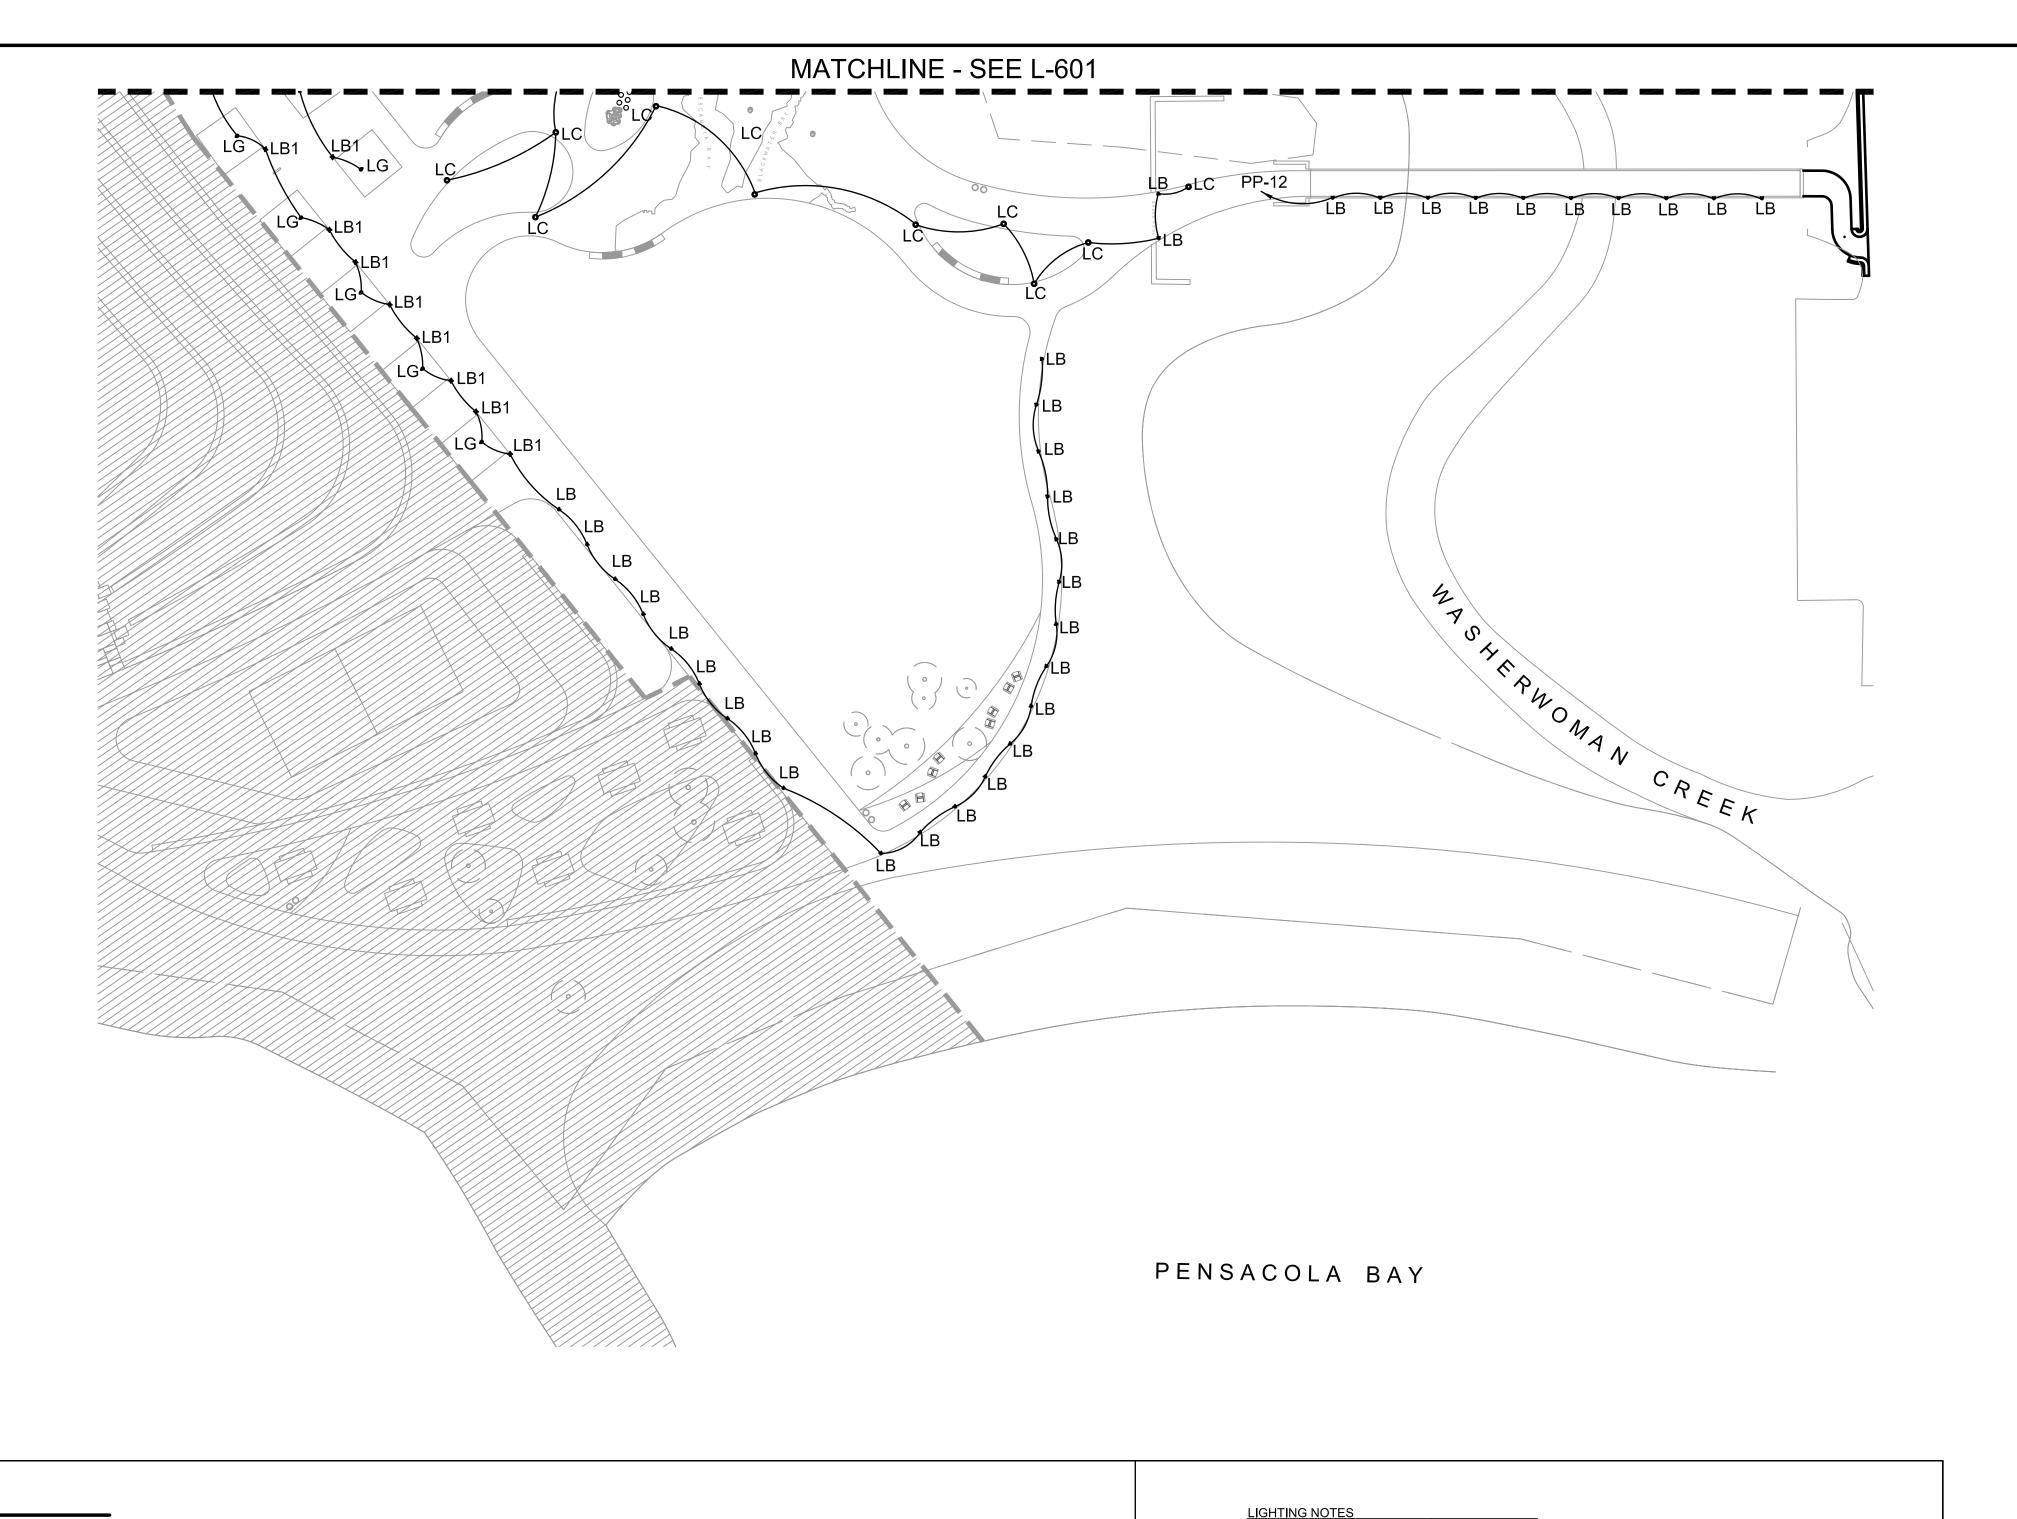

FJS

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HDR Project Number: 10279441

KEY PLAN

SITE LIGHTING -AREA 2

1" = 30'-0"

LIGHTING FIXTURES





LB, LB1: MARKER LIGHT -LUMASCAPE, LS553LED



LC: PLAYGROUND LIGHT -LITHONIA, KBR8



LD: WALL/STEP LIGHT -BEGA, 33017



LG: TREE UPLIGHT



5. REFER TO SHEET L-650 FOR LIGHTING FIXTURE SCHEDULE. 6. LIGHT FIXTURES SHALL BE CONTROLLED VIA PHOTOSENSOR TO OPERATE FROM DUSK

3. BEACHSIDE SHIELDS AND/OR LOUVERS SHALL BE USED FOR ANY FIXTURE WITHIN LINE

1. ALL LIGHT FIXTURES TO BE CERTIFIED BY THE FLORIDA FISH AND WILDLIFE

4. LONG-WAVELENGTH LIGHTS SHALL BE USED TO PROTECT SEA TURTLES.

2. LIGHT MUST BE DOWNWARD DIRECTED.

OF SIGHT OF THE BEACH.

CONSERVATION COMMISSION'S WILDLIFE LIGHTING CERTIFICATION PROGRAM.



						LUMINAIRESCHEDULE		
			LAMP	DATA				
TYPE	DESCRIPTION	TYPE	INPUT WATTS	LUMEN OUTPUT	INPUT VOLTS	PROPOSED LUMINAIRE TYPE	APPROVED ALTERNATES	NOTES
LA	Pole top mounted full cutoff LED fixture with tapered head and decorative top with finial. Fixture shall have type II distribution. Fixture to be mounted on 12' pole with decorative base.	3000K LED	54 W	5,623 lm	120 V	Lumec #MPTR-55W32LED-3K-G3-LE2-120V-DMG	Sternberg	- UL listed suitable for wet locations. Protection class IP66.
LA1	Pole top mounted full cutoff LED fixture with tapered head and decorative top with finial. Fixture shall have type VI distribution. Fixture to be mounted on 12' pole with decorative base.	3000K LED	101 W	10,073 lm	120 V	Lumec #MPTR-97W32LED-3K-G3-LE5-120V-DMG	Sternberg	- UL listed suitable for wet locations. Protection class IP66.
LB	In grade mounted walk over LED marker light with nominal 3.5" diameter by 0.5" high rounded marine grade stainless steel housing. Fixture shall have 120 degree light distribution and black marine grade finish.	Amber LED	2.4 W	n/a	120-277 V	Lumascape #LS553LED-2-RO-BL-01-21/23-09		- UL listed suitable for wet locations. Protection class IP67 When fixture is located in concrete, provide with LS698-K pre-installation kit. Pre-installation kit is not required for fixtures mounted in bridge deck.
	In grade mounted walk over LED marker light with nominal 3.5" diameter by 0.5" high rounded marine grade stainless steel housing. Fixture shall have 360 degree light distribution and black marine grade finish. Provide with pre-installation kit.	Amber LED	2.4 W	n/a	120-277 V	Lumascape #LS553LED-2-RO-BL-04-23-09 #LS698-K		- UL listed suitable for wet locations. Protection class IP67.
	Ground mounted LED bollard with nominal 8" diameter by 40" high round extruded aluminum housing and high-impact acrylic lens with full cutoff. Fixture shall have asymmetrical beam distribution.	Amber LED	16 W	324 lm	120-277 V	Lithonia #KBR8-LED-12C-450-AMBLW-ASY-MVOLT-DDBXD	Bega	- UL listed suitable for wet locations. Protection class IP66.
	Wall mounted full cutoff LED step light with nominal 6.63" wide by 2.75" high by 5" deep die-cast aluminum marine grade housing and louvered face.	Amber LED	5 W	10 lm	120-277 V	Bega #33017-AMB-BRZ		- UL listed suitable for wet locations. Protection class IP65.
LG	Block mounted adjustable accent light to illuminate trees along allee. Fixture shall have wide distribution. Located remote driver in secure location in NEMA 4 rated enclosure.	Amber LED	9 W	285 lm	120-277 V	Bega #77699-AMB-BLK-79511-19591		- UL listed suitable for wet locations. Protection class IP65.

LIGHTING FIXTURES

LA, LA1: PARKING LOT & SIDEWALK - LUMEC, METROSCAPE



© LB, LB1: MARKER LIGHT - LUMASCAPE, LS553LED



C: PLAYGROUND LIGHT -LITHONIA, KBR8



LD: WALL/STEP LIGHT - BEGA, 33017



LG: TREE UPLIGHT BEGA





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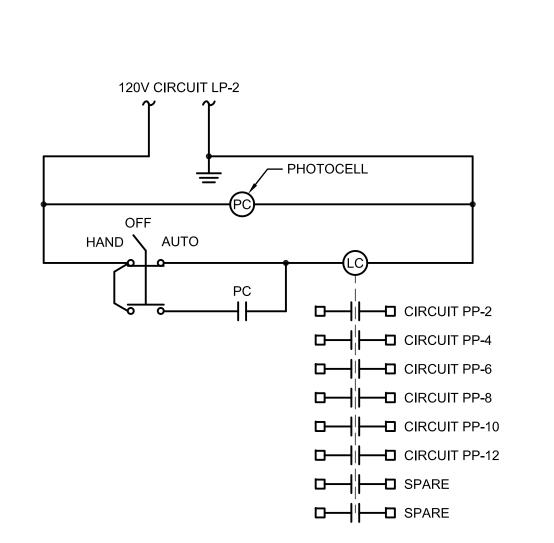
Sheet Name
SITE LIGHTING LIGHTING FIXTURE
SCHEDULE AND
DETAILS


Scale AS NOTED

Sheet Number

					PANELBOARD NO:	PPEB																	
					VOLTAGE (L-L):	480		BUS RA	ΓING (A):	:		100				ENCLOS	URE:	NEMA 4X					
					VOLTAGE (L-N):	277		MAIN O	DEVICE	E (A/PHA	SE):	MLO				MOUNTI	NG:	SURFACE					
					PHASE / WIRE:	3 / 4+G		INTERRU	JPTING F	RATING	(KA):	65				LOCATI	ON:	BRUCE BEACH					
					200% NEUTRAL:	NO		SERVICE	ENTRA	NCE LAI	BEL:	NO				BUILDIN	IG:	ELECTRICAL PEDESTAL					
	WIR	ING		СКТ		СО	NNECTE	D LOAD (VA)	ОСР)	OCF	>	СО	NNECTE	D LOAD (VA)		СКТ		WII	RING	
PHASE	NEUT.	GRND.			DESCRIPTION	LTS	REC	MECH		AMPS	Р	AMPS	Р	LTS				DESCRIPTION			NEUT.	GRND.	COND.
				1		200	0	0	0		Α	15	3	962				ROADWAY LIGHTING	2	12	12	12	1"
6	6	8	1 1/4"	3	TRANSFORMER LP	100	180	0	0	45	3 B			814				ROADWAY LIGHTING	4	12	12	12	1"
				5		0	0	0	300		С			500				SEAT WALL LIGHTING	6	12	12	12	1"
				7	SPACE ONLY						Α	15	3	560				PLAYGROUND LIGHTING	8	12	12	12	1"
				9	SPACE ONLY						В			903				PATHWAY LIGHTING	10	12	12	12	1"
				11	SPACE ONLY						С			760				BRIDGE LIGHTING	12	12	12	12	1"
				13	SPACE ONLY						Α	15	3				500	SPARE	14				1
				15	SPACE ONLY						В						500	SPARE	16				1
				17	SPACE ONLY						С						500	SPARE	18				1
				19	SPACE ONLY						Α	15	3					SPACE ONLY	20				1
				21	SPACE ONLY						В							SPACE ONLY	22				1
				23	SPACE ONLY						С							SPACE ONLY	24				1
				25	SPACE ONLY						Α	30	3					SPACE ONLY	26				
				27	SPACE ONLY						В							SPACE ONLY	28				
				29	SPACE ONLY						С							SPACE ONLY	30				
											Α								L1				
					SPD (TVSS)					N/A	3 B		3					FEED-THRU LUGS TO	L2				
					CONNECTED TO BUS						С							PANEL ???	L3]			
NOTES:										LO	AD SU	MMARY							•	NOTES	:		
						LTS	REC	MECH	MISC**	SPAR	E -	TOTAL						PHASE BALANCE		* REFE	R TO ON	ΙΕ-LINE Γ	DIAGRAM
				CON	NECTED LOAD (KVA)	4.8	0.2	0.0	1.8			6.8		480	LINE-TC	LINE VO	LTS	PHASE A (KVA)	2	** MISC	DEMAN	D INCLUE	DES 25%
				DEM/	AND FACTOR	1.25	NEC		1.00	20%			1	8	CONNE	CTED AM	PS	PHASE B (KVA)	2	OFL	ARGEST	MOTOR	KVA
				DESI	GN LOAD (KVA)	6.0	0.2	0.0	1.8	1.4		9.3	1	11	DESIGN	AMPS		PHASE C (KVA)	2	1			

					PANELBOARD NO:	LP																	
					VOLTAGE (L-L):	208		BUS RA	TING (A):	:		100				ENCLOS	URE:	NEMA 4X					
					VOLTAGE (L-N):	120				E (A/PHAS	E):	60				MOUNTI	NG:	SURFACE					
					PHASE / WIRE:	3 / 4+G				RATING (H		10				LOCATION	ON:	BRUCE BEACH					
					200% NEUTRAL:	NO				NCE LABI	-					BUILDIN	G:	ELECTRICAL PEDESTAL					
	WIF	RING		СКТ		COI	NNECTE	D LOAD (VA)	ОСР		OCF	•	CC	NNECTE	D LOAD (VA)		СКТ		WIF	RING	
PHASE	NEUT.	GRND.			DESCRIPTION	LTS	REC	MECH	MISC	AMPS I	5	AMPS	Р	LTS				DESCRIPTION	NO.	PHASE	NEUT.	GRND.	. COND.
				1	SPARE					20	1 A	20	1	200				LIGHTING CONTACTOR	2	12	12	12	3/4"
				3	SPARE					20	1 B	20	1	100	180			RESTROOM LTS, RECPTS	4	12	12	12	3/4"
				5	SPARE					20	1 C	20	1				300	RESTROOM FAN	6	12	12	12	3/4"
				7	SPACE ONLY						A							SPACE ONLY	8				
				9	SPACE ONLY						В							SPACE ONLY	10				
				11	SPACE ONLY						С							SPACE ONLY	12				
				13	SPACE ONLY						A							SPACE ONLY	14				
				15	SPACE ONLY						В							SPACE ONLY	16				
				17	SPACE ONLY						С							SPACE ONLY	18				
				19	SPACE ONLY						A							SPACE ONLY	20				
				21	SPACE ONLY						В							SPACE ONLY	22				
				23	SPACE ONLY						С							SPACE ONLY	24				
				25	SPACE ONLY						A							SPACE ONLY	26				
				27	SPACE ONLY						В							SPACE ONLY	28				
				29	SPACE ONLY						С							SPACE ONLY	30				
NOTES:	:	1			SPACE CINET					LOA	D SU	MMARY						DEALE CIVIT		NOTES:		1	
			Ī			LTS	REC	MECH	MISC**	SPARE	-	ΓΟΤΑL						PHASE BALANCE		* REFE	R TO ON	IE-LINE [DIAGRAM
			ļ	CONN	NECTED LOAD (KVA)	0.3	0.2	0.0	0.3			0.8		208	LINE-TO	D-LINE VO	LTS	PHASE A (KVA)	0	** MISC	DEMAN	D INCLUI	DES 25%
				DEMA	AND FACTOR	1.25	NEC		1.00	20%			1	2	CONNE	CTED AM	PS	PHASE B (KVA)	0	OF LA	RGEST	MOTOR	. KVA
			-	DESI	GN LOAD (KVA)	0.4	0.2	0.0	0.3	0.2	\top	1.0	1	3	DESIGN	JAMPS		PHASE C (KVA)	0				



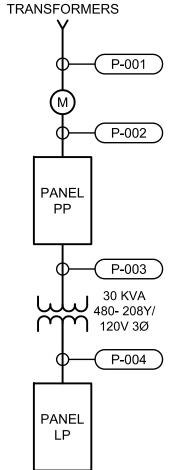

UTILITY SUPPLY

FROM POLE


MOUNTED

		UNDERGRO	OUND CONDUIT AND WI	RE SCHEDULE
CONDUIT NO.	SIZE	FROM	ТО	CONDUCTORS
P-001	3"	UTILITY POLE/TRANSFORMER	UTILITY METER	PULL CORD
P - 002	2"	UTILITY METER	PANEL PP	3-#1, 1-#6 GROUND
P-003	1 1/4"	PANEL PP	TRANSFORMER LP	3-#6, 1-#8 GROUND
P-003	2"	TRANSFORMER LP	PANEL LP	4-#1, 1-#6 GROUND

I DANIEL I					
PANEL PP	P-001	3"	UTILITY POLE/TRANSFORMER	UTILITY METER	PULL CORD
	P-002	2"	UTILITY METER	PANEL PP	3-#1, 1-#6 GROU
	P-003	1 1/4"	PANEL PP	TRANSFORMER LP	3-#6, 1-#8 GROU
P-003	P-003	2"	TRANSFORMER LP	PANEL LP	4-#1, 1-#6 GROL
30 KVA 480- 208Y/					
120V 3Ø					
P-004					
PANEL LP					


4 LIGHTING CONTACTOR CONTROL SCHEMATIC

5 ELECTRICAL ONE-LINE DIAGRAM

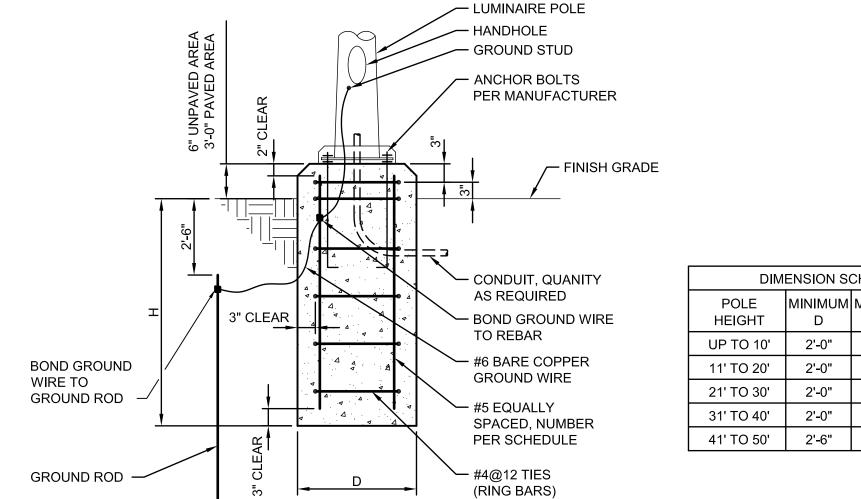

DIMENSION SCHEDULE								
POLE HEIGHT	MINIMUM D	MINIMUM H	VERTICAL REBAR EACH					
UP TO 10'	2'-0"	4'-6"	6					
11' TO 20'	2'-0"	6'-6"	6					
21' TO 30'	2'-0"	8'-6"	6					
31' TO 40'	2'-0"	9'-6"	8					
41' TO 50'	2'-6"	10'-6"	10					

3 LIGHT POLE FOUNDATION

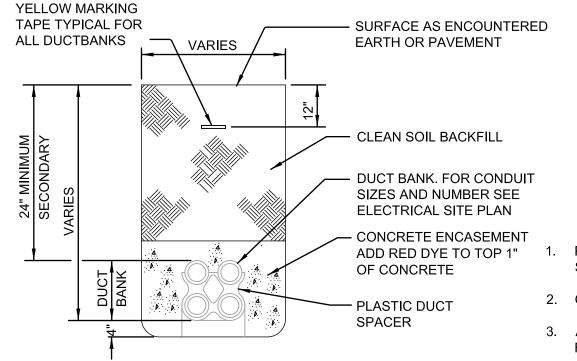


DUCT LINE NOTES

- PROVIDE PLASTIC DUCT SPACERS AT A MINIMUM OF 8' INTERVALS. SECURE DUCT TO SPACERS AND ANCHOR EACH SPACER.
- 2. CONCRETE ENCASEMENT SHALL BE 2500 PSI AT 28 DAYS.
- 3. ALL SPARE DUCTS SHALL BE PLUGGED WITH A STANDARD DUCT PLUG

2 DUCTBANK/TRENCHING DETAIL

NTS

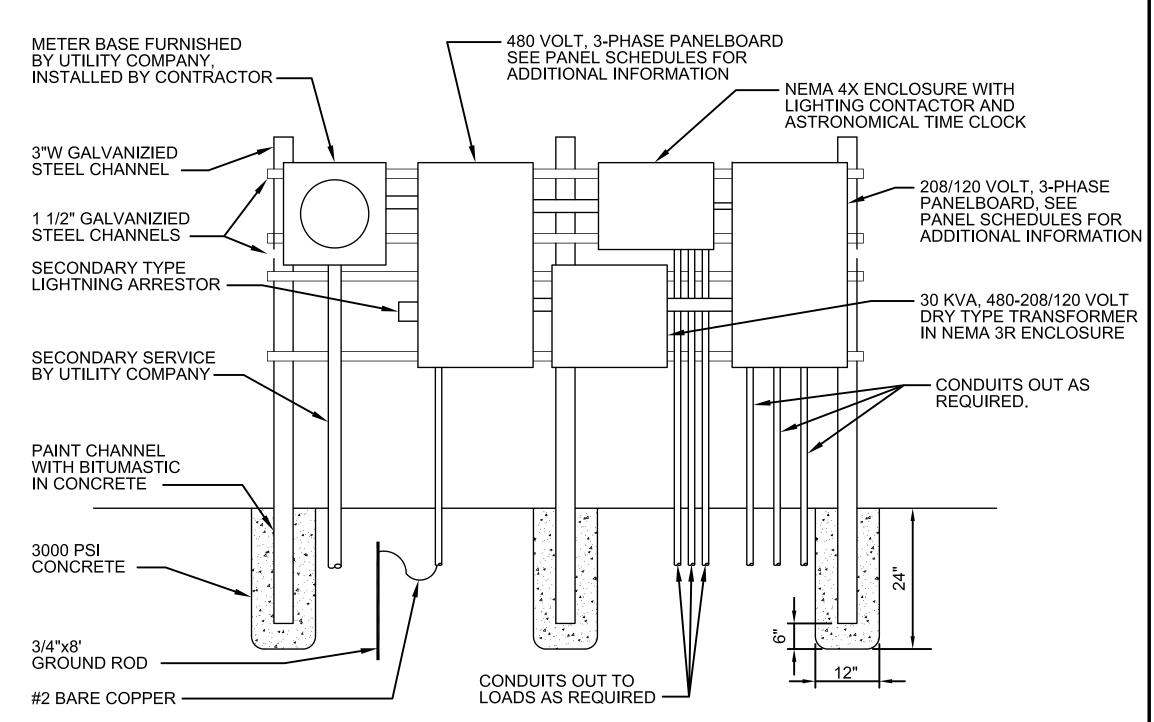

LELECTRICAL SERVICE EQUIPMENT RACK

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Sheet Name SITE LIGHTING -LIGHTING DETAILS AND PANEL SCHEDULES

AS NOTED

Sheet Number







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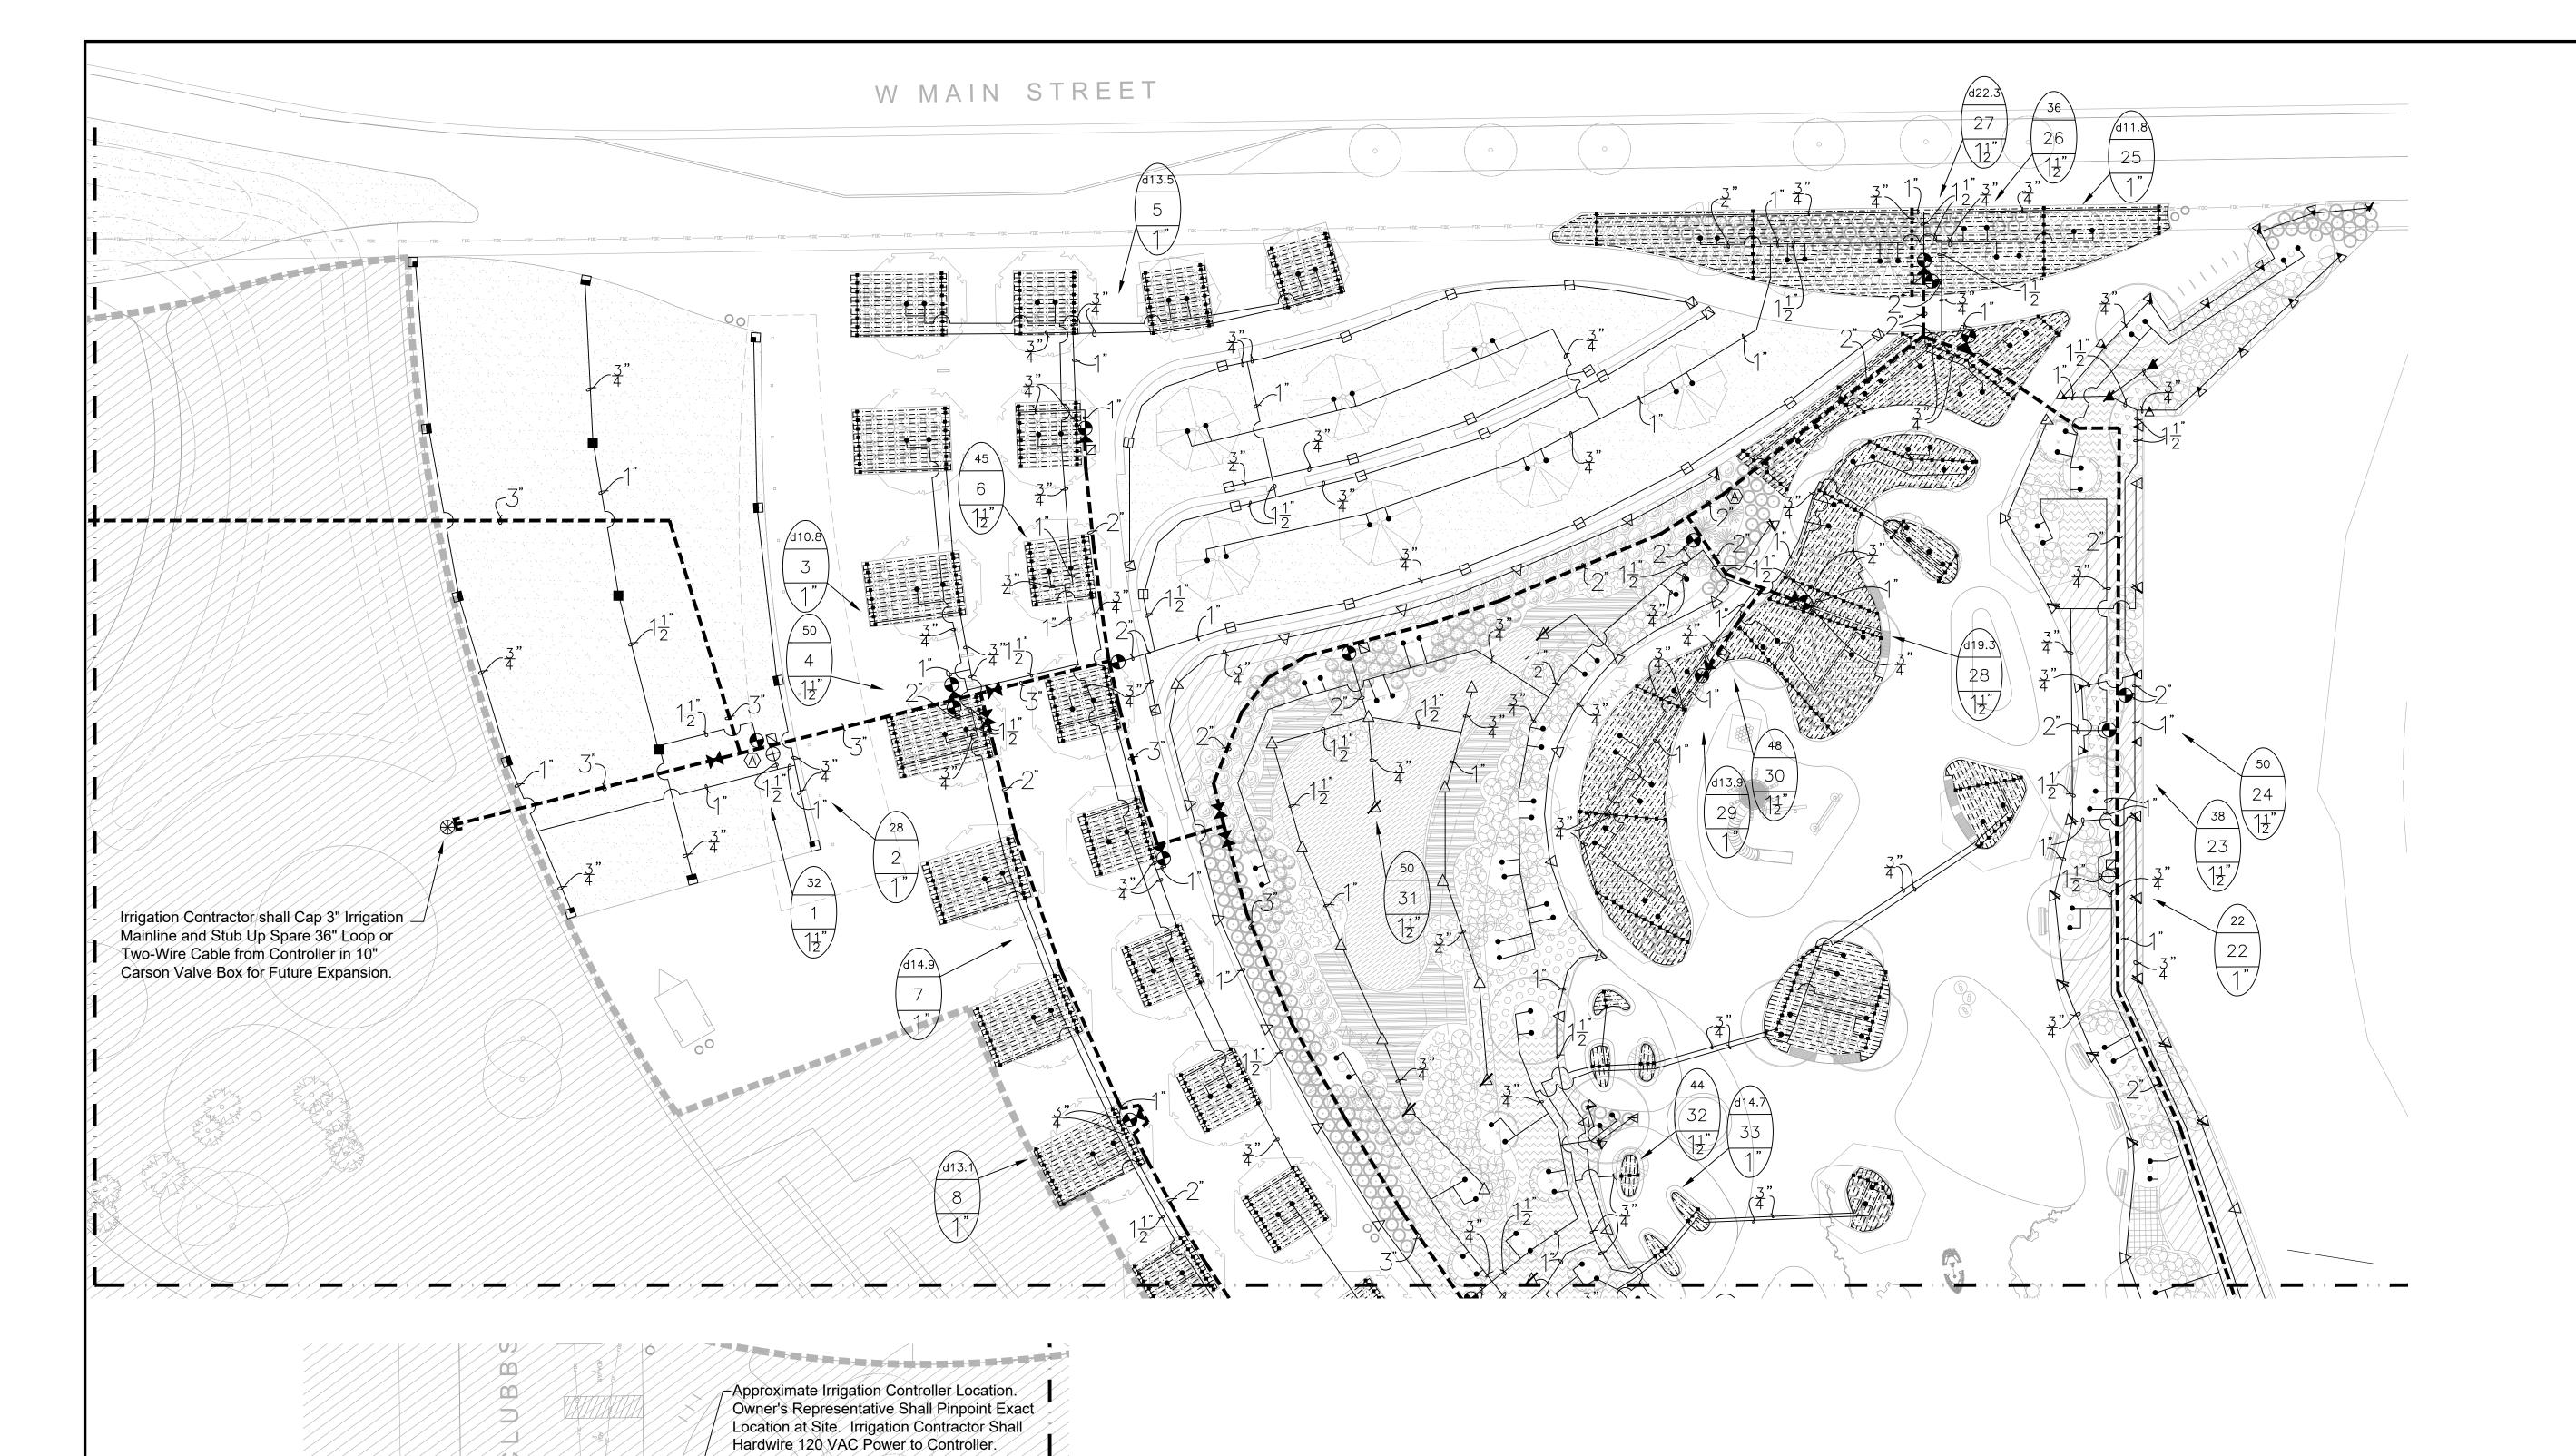
HDR Project Number: 10279441

IRRIGATION PLAN
- OVERALL

Scale 1" = 40'-0"

Sheet Number

I-100



2" Irrigation Water Meter. System

Site Before Starting Construction.

Requires 100 GPM @ 75 PSI Irrigation

Contractor shall Verify Requirements at

Coordinate with Civil Drawings and at


site to determine actual meter location.

Irrigation Contractor shall Cap 3" Irrigation—

Mainline and Stub Up Spare 36" Loop or Two-Wire Cable from Controller in 10"

Carson Valve Box for Future Expansion.

- 1. ALL SPRINKLER TO BE MOUNTED ON MARLEX ELLS OR UNITIZED SWING JOINTS (AS SPECIFIED ON DETAILS).
- 2. CONTRACTOR TO UTILIZE A AUTOMATIC DRAIN CHECK VALVE DEVICE WHERE LOW HEAD DRAINAGE MAY OCCUR.
- 3. ALL TWO-WIRE CABLE TO BE MINIMUM SIZE OF 14-2 MAXI-CABLE
- 4. ALL TWO-WIRE CABLE TO BE INSTALLED IN 1" SCH 40 PVC
- ELECTRICAL CONDUIT.
- 5. ALL ELECTRICAL CONDUITS OPENINGS TO BE FOAM SEALED. 6. ALL WIRE SPLICES TO BE MADE WITH 3M DBR/Y-6 CONNECTORS
- MOUNTED IN A MINIMUM OF 10" CARSON VALVE BOX
- 7. ALL PIPING AND WIRING UNDER HARDTOPS WILL BE IN CLASS 200 PVC PIPE SLEEVE.
- 8. LSP-1 SURGE ARRESTORS SHALL BE INSTALLED EVERY 300' OR EVERY 6 DECODERS (WHICHEVER IS SHORTER) ALONG TWO-WIRE PATH. LSP-1 SURGE ARRESTORS SHALL ALSO BE INSTALLED AT ALL TERMINAL ENDS OF TWO-WIRE CABLE PATHS (STAR CONFIGURATION). REFER TO DETAIL-T.
- 9. INSTALLATION CONTRACTOR SHALL ADHERE TO ALL MANUFACTURER SPECIFICATIONS FOR TWO-WIRE CONTROL SYSTEM INSTALLATION (WIRE SIZING, WIRE LENGTH OF RUNS, GROUNDING, ETC).

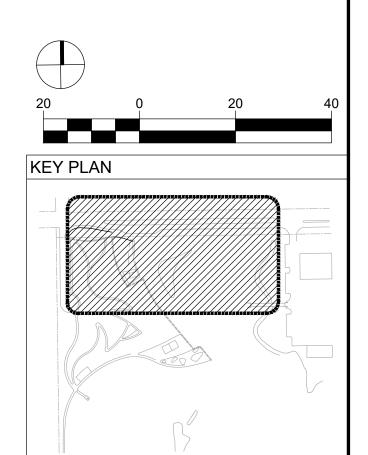



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PHASE ONE


DESCRIPTION
30% DESIGN DEVELOPMENT
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IRRIGATION PLAN - AREA 1

1" = 20'-0"

Sheet Number **I-101**



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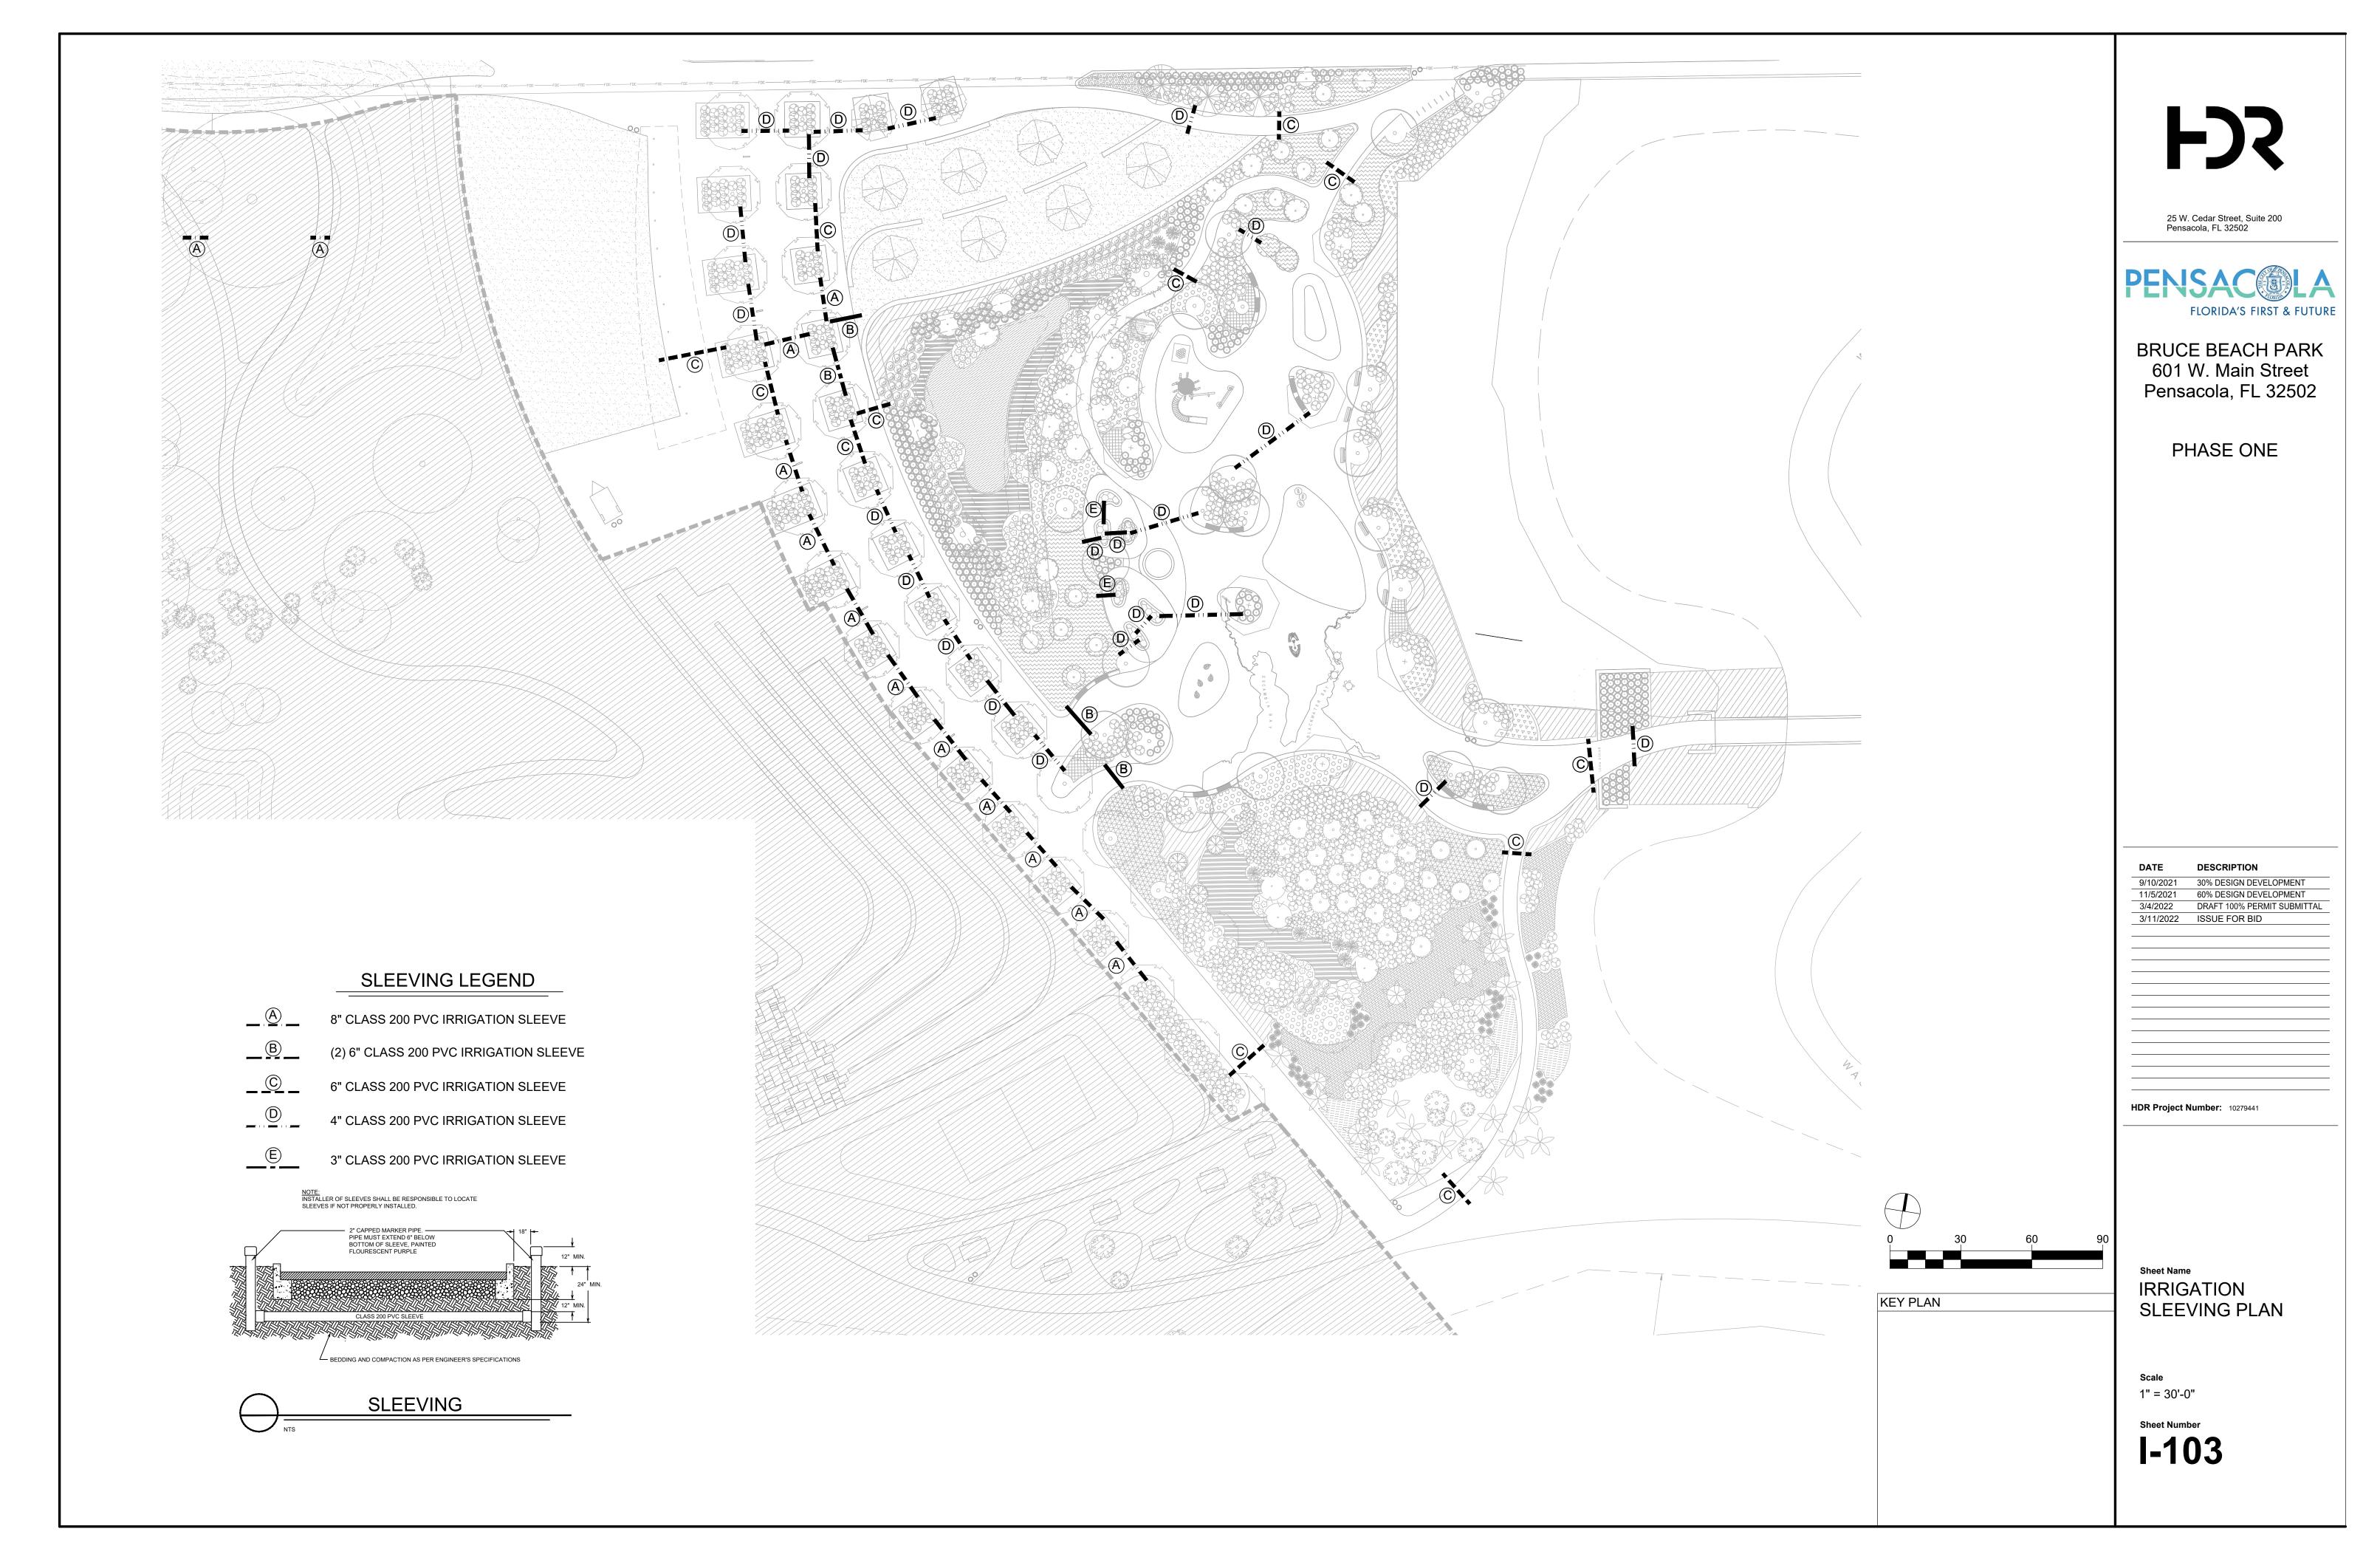
KEY PLAN

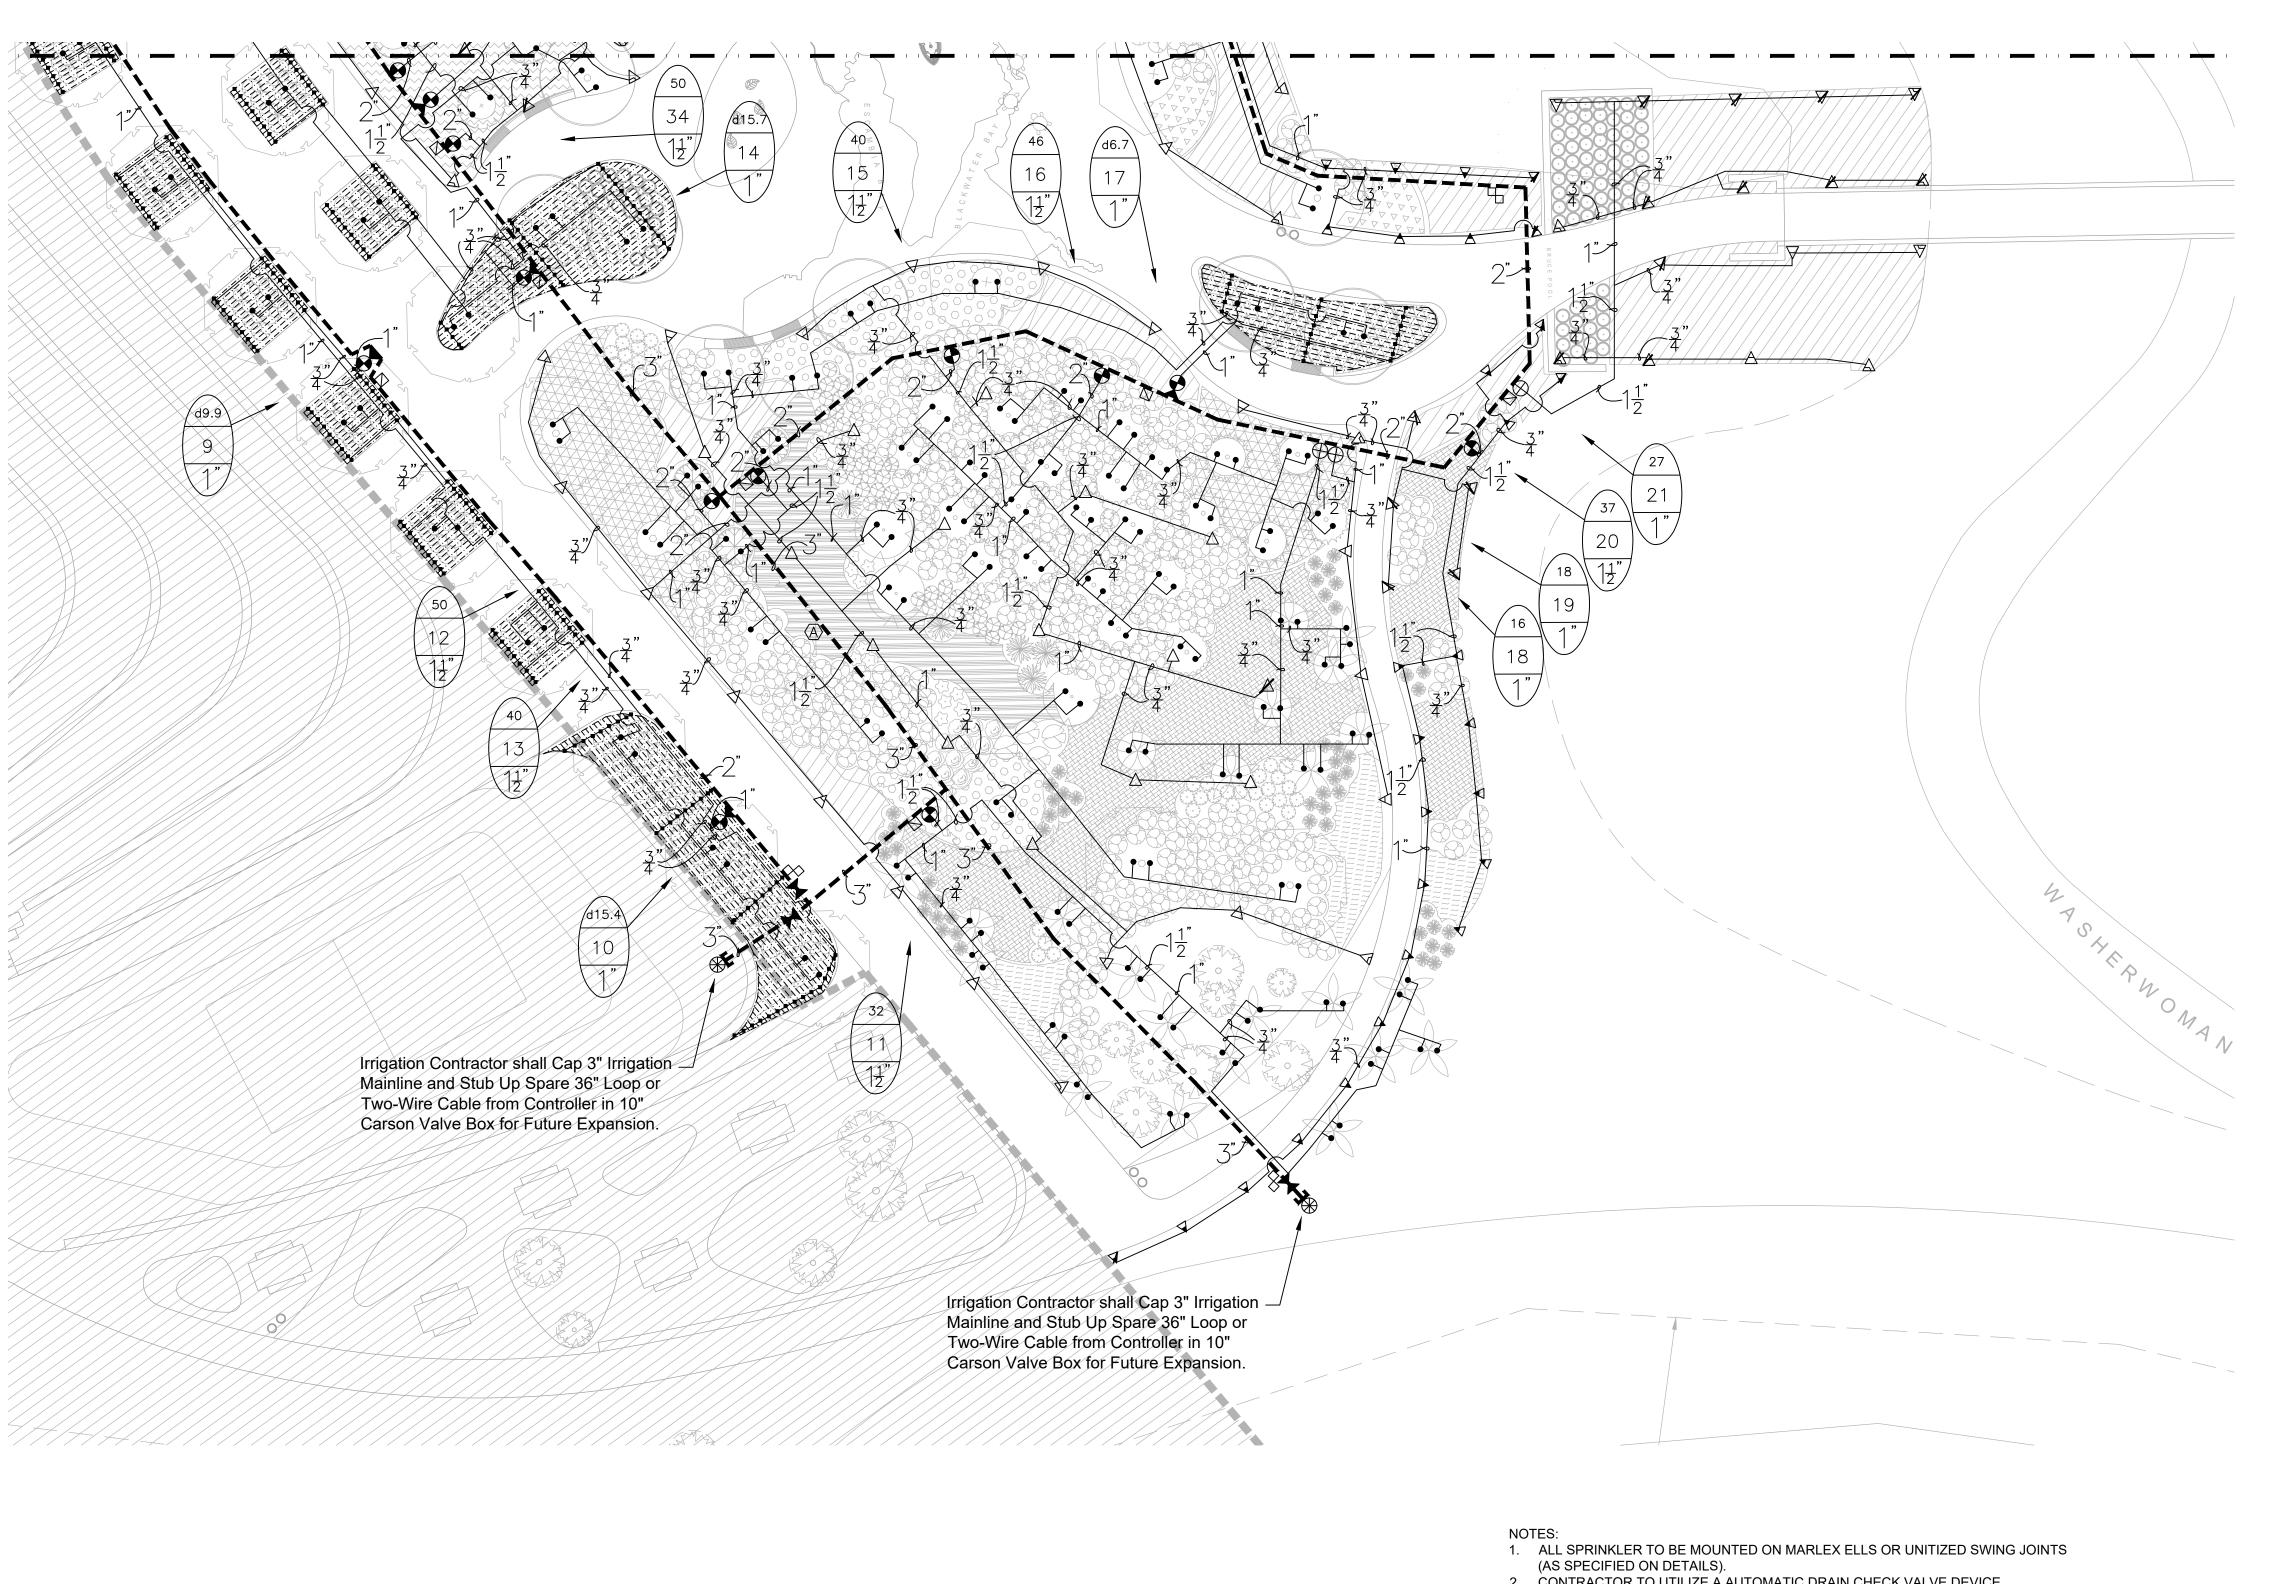
IRRIGATION PLAN - AREA 2

1" = 20'-0"


- 2. CONTRACTOR TO UTILIZE A AUTOMATIC DRAIN CHECK VALVE DEVICE
- WHERE LOW HEAD DRAINAGE MAY OCCUR.


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- 5. ALL ELECTRICAL CONDUITS OPENINGS TO BE FOAM SEALED.6. ALL WIRE SPLICES TO BE MADE WITH 3M DBR/Y-6 CONNECTORS MOUNTED IN A MINIMUM OF 10" CARSON VALVE BOX
- 7. ALL PIPING AND WIRING UNDER HARDTOPS WILL BE IN CLASS 200 PVC PIPE SLEEVE.
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- 9. INSTALLATION CONTRACTOR SHALL ADHERE TO ALL MANUFACTURER SPECIFICATIONS FOR TWO-WIRE CONTROL SYSTEM INSTALLATION (WIRE SIZING, WIRE LENGTH OF RUNS, GROUNDING, ETC).



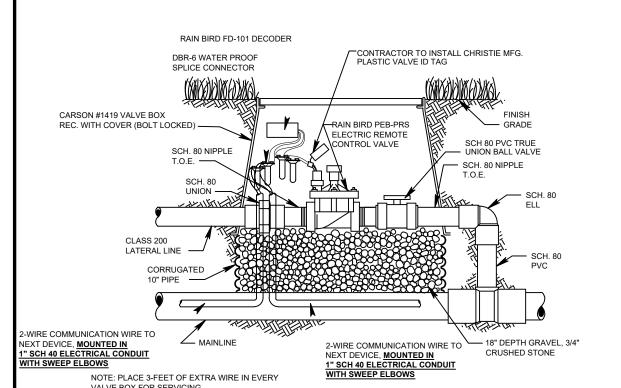

CONTROL VALVE

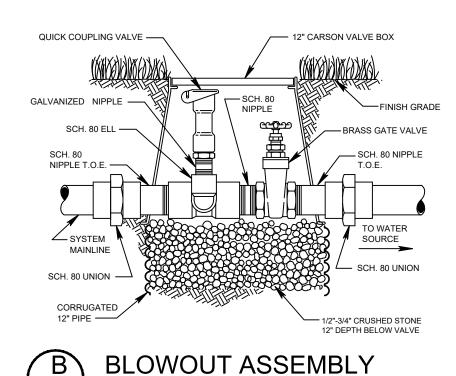


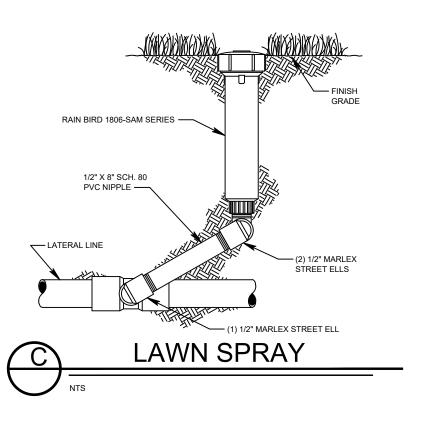



ALL VALVE BOXES SHALL BE BLACK IN COLOR AND INSTALLED IN


LANDSCAPE BEDS (ANYTHING SHOWN IN TURF AREAS IS


DIAGRAMMATIC FOR READABILITY PURPOSES ONLY)

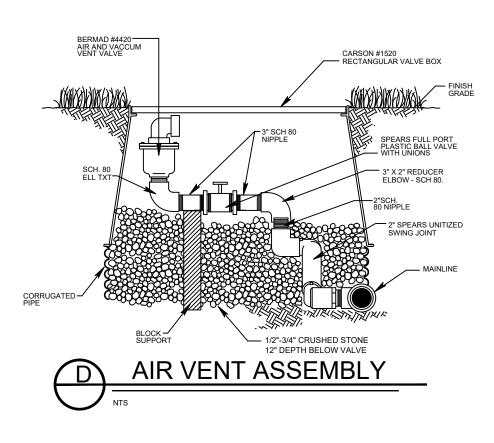


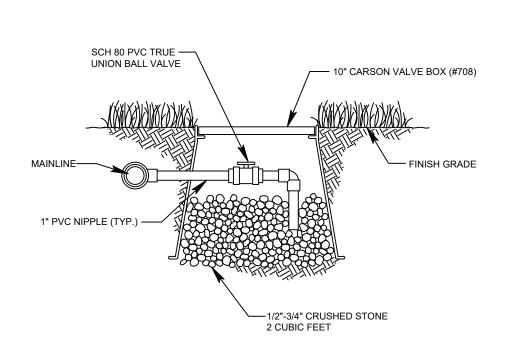

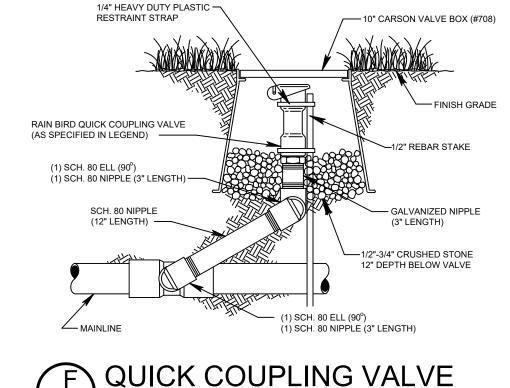

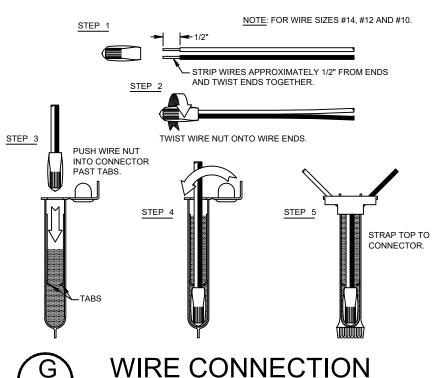

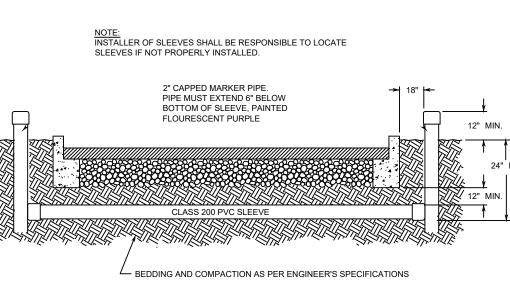

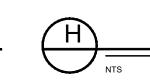

SLEEVING





ACCEPTANCE.

- 1. ALL MAINLINES TO HAVE A MINIMUM OF 18" OF COVER. (CLASS 200 PVC PIPE,
- CLASS 200 PVC FOR 4" AND LARGER). 2. ALL LATERAL AND SUB-MAIN PIPE TO HAVE A MINIMUM OF 12" OF COVER. (CLASS 200 PVC PIPE).
- 3. NO ROCKS, BOULDER, OR OTHER EXTRANEOUS MATERIALS TO BE USED IN
- BACKFILLING OF TRENCH.
- 4. ALL PIPE TO BE INSTALLED AS PER MANUFACTURERS' SPECIFICATIONS. 5. ALL THREADED JOINTS TO BE COATED WITH TEFLON TAPE OR LIQUID
- 6. ALL LINES TO BE THOROUGHLY FLUSHED BEFORE INSTALLATION OF SPRINKLER HEADS.
- SPRINKLER AND RELATED EQUIPMENT TO BE INSTALLED AS PER DETAILS.
- SHOWN ON DETAILS. 9. ALL EQUIPMENT NOT SPECIFIED IN THE LEGEND SHALL BE DETERMINED AND
- FURNISHED BY THE CONTRACTOR. 10. NO ELECTRICAL CONNECTIONS SHALL BE MADE IN THE FIELD EXCEPT AT A VALVE CONTROL BOX OR ANOTHER VALVE BOX SPECIFICALLY FOR
- CONNECTIONS. 11. ANY DISCREPANCY BETWEEN THIS SHEET AND OTHERS IN THIS SET MUST BE
- REFERRED TO THE IRRIGATION CONSULTANT BY THE CONTRACTOR FOR CLARIFICATION BEFORE PRECEEDING WITH THE WORK. 12. ALL TWO-WIRE CONTROL WIRES SHALL BE #14-2 MAXI CABLE, INSTALLED IN 1"
- SCH 40 PVC ELECTRICAL CONDUIT. 13. CONTRACTOR TO BE RESPONSIBLE FOR PROPER COVERAGE OF AREAS TO
- BE WATERED. I.E. ADJUST HEADS WITH INSUFFICIENT COVERAGE DUE TO BLOCKAGE BY EXISTING OR PROPOSED SITE FEATURES. 14. CONTRACTOR TO REFER TO LANDSCAPE PLAN TO KEEP SPRINKLER


EQUIPMENT AND ACCESSORY MATERIAL FROM INTERFERING WITH PROPER

- PLANTING, i.e. VERIFY ROOT BALL SIZE FOR PLANTING. 15. CONTRACTOR SHALL PROVIDE EXPANSION COILS AT EACH WIRE
- CONNECTION IN VALVE BOX (WRAP AROUND 3/4" PIPE 12 TIMES).
- 16. CONTRACTOR TO UTILIZE APPROPRIATE AUTOMATIC DRAIN DEVICE WHERE LOW HEAD DRAINAGE MAY OCCUR.

ON FAULT GROUND AND LIGHTNING PROTECTION.

- 17. ALL SPRINKLERS TO BE INSTALLED AS DETAILED ON PLANS. 18. CONTRACTOR SHALL UTILIZE VALVE I.D. TAGS ON ALL REMOTE CONTROL
- 19. 24 VOLT WIRE SHALL BE COLOR CODED PER SEPARATE WIRE RUNS. 20. CONTRACTOR SHALL INSTALL MANUFACTURERS' RECOMMENDED GROUNDING EQUIPMENT FOR POWER SUPPLY AND VALVE OUTPUT WITH
- PAIGE WIRE GROUND PLATE ASSEMBLY. 21. CONTRACTOR SHALL INSTALL MANUFACTURERS' RECOMMENDATION

- 22. CONTROLLER GROUNDING MUST BE AS PER RAIN BIRD WIRE GROUNDING REQUIREMENTS
- 23. ALL MATERIAL TO BE SUPPLIED BY CONTRACTOR TO OWNER: A. TWO WRENCHES FOR DISASSEMBLING AND ADJUSTING EACH TYPE OF SPRINKLER HEADS AND VALVE SUPPLIED.
- B. TWO KEYS FOR EACH OF THE AUTOMATIC CONTROLLERS.
- C. TWO QUICK COUPLER KEYS WITH MATCHING HOSE SWIVELS. 24. SYSTEM IS DIAGRAMMATIC TO IMPROVE CLARITY. ALL MAINLINE PIPING ELECTRIC VALVES AND WIRING ARE TO BE INSTALLED IN LANDSCAPE AREAS AND WITHIN PROPERTY BOUNDARIES. CONTRACTOR SHALL REFERENCE THE LANDSCAPE PLAN PRIOR TO THE INSTALLATION OF PIPING TO AVOID CONTACT WITH PLANT MATERIALS EXISTING OR NEW.
- 8. ALL ELECTRICAL JOINTS TO BE MADE USING WATERPROOF CONNECTIONS AS 25. CONTRACTOR TO ADD EXTENSION RISER TO POP-UP HEADS WHEN NEEDED FOR PROPER COVERAGE.
 - 26. CONTRACTOR SHALL INSTALL SPRINKLER EQUIPMENT 12" FROM FOUNDATIONS.
 - ALSO INSTALL SPRINKLERS 4" FROM CURB OR WALKS. 27. PRIOR TO BID IRRIGATION CONTRACTOR SHALL VERIFY RIGHT-OF-WAY AND BACKFLOW REQUIREMENTS. NO LATER THAN FIVE DAYS BEFORE BID SUBMITTALS CONTRACTOR SHALL NOTIFY CONSULTANT OF ANY CHANGES FROM
 - PLANS AND SPECIFICATIONS. 28. IRRIGATION CONTRACTOR SHALL PROVIDE THE OWNER AND LANDSCAPE ARCHITECT WITH A REPRODUCIBLE CROSS MEASURED AS-BUILT DRAWING OF THE INSTALLED IRRIGATION SYSTEM IN AUTOCAD 2010 FORMAT BEFORE FINAL
 - 29. A 1-YEAR WARRANTY PERIOD SHALL BE PROVIDED FOR SYSTEM AFTER SUBSTANTIAL COMPLETION IS ACCEPTED. START UP AND ADJUSTING OF SYSTEM IN SPRING TIME SHALL BE INCLUDED IN WARRANTY.
 - 30. PRIOR TO BID, CONTRACTOR SHALL VERIFY THAT ALL MATERIALS, INSTALLATION PARAMETERS AND OPERATIONS CONFORM TO ALL APPLICABLE CODES AND ORDINANCES. NO LATER THAN FIVE DAYS BEFORE BID SUBMITTALS CONTRACTOR SHALL NOTIFY IRRIGATION CONSULTANT/DESIGNER OF ANY CHANGES REQUIRED DUE TO CURRENT CODE OR ORDINANCE DISCREPANCIES. IF CONTRACTOR DOES NOT COMPLY TO THIS NOTIFICATION, THE CONTRACTOR SHALL BE RESPONSIBLE FOR ALL NECESSARY INSTALLATION CHANGE AND REDESIGN COSTS FOR NON-COMPLIANCE.
 - 31. UNLESS OTHERWISE NOTED, THE CONTRACTOR MUST COMPLETE 2 PRESSURE TESTS OF THE IRRIGATION SYSTEM MAINLINE (BOTH TO SHOW NO DROP IN PRESSURE DURING DURATION OF TEST.
 - A. 2-HOUR PRESSURE TEST AT 1.5 TIMES THE SYSTEM STATIC PRESSURE B. 24-HOUR PRESSURE TEST AT THE SYSTEM STATIC PRESSURE
 - 32. IRRIGATION INSTALLATION CONTRACTOR SHALL PROVIDE OWNER WITH A COLOR-CODED ZONES DIAGRAM PLAN, 8-1/2"X11" LAMINATED SHEET(S), TO IDENTIFY CONTROLLER STATION TO THE CONTROL VALVE NUMBER FOR EACH CONTROLLER. TO BE LOCATED IN ADHESIVE POUCH ATTACHED INSIDE OF CONTROLLER(S).

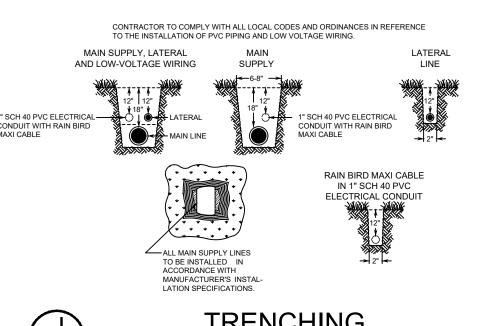



TRENCHING

- 1. ALL SPRINKLER TO BE MOUNTED ON MARLEX ELLS OR UNITIZED SWING JOINTS
- (AS SPECIFIED ON DETAILS). 2. CONTRACTOR TO UTILIZE A AUTOMATIC DRAIN CHECK VALVE DEVICE
- WHERE LOW HEAD DRAINAGE MAY OCCUR. 3. ALL TWO-WIRE CABLE TO BE MINIMUM SIZE OF 14-2 MAXI-CABLE
- 4. ALL TWO-WIRE CABLE TO BE INSTALLED IN 1" SCH 40 PVC
- ELECTRICAL CONDUIT. 5. ALL ELECTRICAL CONDUITS OPENINGS TO BE FOAM SEALED.
- 6. ALL WIRE SPLICES TO BE MADE WITH 3M DBR/Y-6 CONNECTORS
- MOUNTED IN A MINIMUM OF 10" CARSON VALVE BOX 7. ALL PIPING AND WIRING UNDER HARDTOPS WILL BE IN CLASS 200 PVC
- 8. LSP-1 SURGE ARRESTORS SHALL BE INSTALLED EVERY 300' OR EVERY 6 DECODERS (WHICHEVER IS SHORTER) ALONG TWO-WIRE PATH. LSP-1 SURGE

ARRESTORS SHALL ALSO BE INSTALLED AT ALL TERMINAL ENDS OF TWO-WIRE

CABLE PATHS (STAR CONFIGURATION). REFER TO DETAIL-T. 9. INSTALLATION CONTRACTOR SHALL ADHERE TO ALL MANUFACTURER SPECIFICATIONS FOR TWO-WIRE CONTROL SYSTEM INSTALLATION (WIRE SIZING, WIRE LENGTH OF RUNS, GROUNDING, ETC).

IRRIGATION LEGEND

- 1" IRRIGATION WATER METER, SYSTEM REQUIRES 100 GPM @ 75 PSI IRRIGATION CONTRACTOR SHALL BE RESPONSIBLE TO VERIFY THE SYSTEM REQUIREMENTS AT SITE BEFORE STARTING CONSTRUCTION.
- WATTS #909-M1-QT-2", 2" REDUCED PRESSURE ASSEMBLY BACKFLOW PREVENTER. DETAIL-W.
- BLOWOUT ASSEMBLY. DETAIL-B.
 - MANUAL DRAIN VALVE. SCH 80 PVC TRUE UNION BALL VALVE. DETAIL-E.
- RAIN BIRD ESP-LXD-PED-SS CONTROLLER WITH (1) 75 STATION EXPANSION MODULE. 125 TOTAL STATIONS, 2-WIRE/DECODER BASED MODULAR CONTROLLER, FOUR PROGRAMS, STAINLESS STEEL, PEDESTAL MOUNTED. DETAIL-J.K.U. IRRIGATION CONTRACTOR SHALL ALSO INSTALL A WIRELESS RAIN/FREEZE SENSOR FOR EACH CONTROLLER.
- RAIN BIRD 150-PEB-PRS PLASTIC ELECTRIC REMOTE CONTROL VALVE, 1-1/2" SIZE, MOUNTED WITH SCH 80 PVC TRUE UNION BALL VALVE WITH PRESSURE REGULATION DEVICES, MOUNTED WITH RAIN BIRD SINGLE STATION DECODER (FD-101TURF). DETAIL-A.
- RAIN BIRD 100-PEB-PRS PLASTIC ELECTRIC REMOTE CONTROL VALVE, 1" SIZE, MOUNTED WITH SCH 80 PVC TRUE UNION BALL VALVE WITH PRESSURE REGULATION DEVICES, MOUNTED WITH RAIN BIRD SINGLE STATION DECODER (FD-101TURF). DETAIL-A.
- RAIN BIRD 1806-SAM, 6" POP-UP LAWN SPRAY SPRINKLER, 12' RADIUS, FULL-2.0 GPM, HALF-1.0 GPM, QUARTER-0.5 GPM, 30 PSI. DETAIL-C.

RAIN BIRD 1806-SAM, 6" LAWN SIDE STRIP SPRAY SPRINKLER, 4' X 30'

- RAIN BIRD 1806-SAM, 6" POP-UP LAWN SPRAY SPRINKLER, 15' RADIUS, FULL-4.0 GPM. HALF-2.0 GPM. QUARTER-1.0 GPM. 30 PSI. DETAIL-C.
- RAIN BIRD 1806-SAM, 6" LAWN POP-UP SIDE STRIP SPRAY SPRINKLER, 9' X 18' RADIUS, 1.5 GPM, 30 PSI. DETAIL-C.
- RADIUS, 1.5 GPM, 30 PSI. DETAIL-C. RAIN BIRD 1806-SAM, 6" LAWN END STRIP SPRAY SPRINKLER, 4' X 15'

RADIUS, 1.0 GPM, 30 PSI. DETAIL-C.

- RAIN BIRD 1812-SAM, 12" HI-POP SHRUB SPRAY SPRINKLER, 15' RADIUS, FULL-4.0 GPM, HALF-2.0 GPM, QUARTER-1.0 GPM, THREE QUARTER-3.0 GPM, 30 PSI. DETAIL-Y. RAIN BIRD 1812-SAM, 12" HI-POP SHRUB SPRAY SPRINKLER, 12' RADIUS, FULL-2.0 GPM, 30 PSI. DETAIL-Y.
- RAIN BIRD 1812-SAM, 12" HI-POP SHRUB SIDE STRIP SPRAY SPRINKLER, 9' X 18' RADIUS, 1.5 GPM, 30 PSI. DETAIL-Y. RAIN BIRD 1812-SAM, 12" HI-POP SHRUB SIDE STRIP SPRAY SPRINKLER, 4' X 30'
- RADIUS, 1.5 GPM, 30 PSI, DETAIL-Y, RAIN BIRD 1812-SAM, 12" HI-POP SHRUB END STRIP SPRAY SPRINKLER, 4' X 15' RADIUS, 1.0 GPM, 30 PSI. DETAIL-Y.
 - RAIN BIRD TREE ROOT WATERING ASSEMBLY. RWS-BG-01, 0.5 GPM. DETAIL-M.
- HUNTER I-20-06-SS LAWN ROTOR, 40' RADIUS, FULL-8.0 GPM, HALF-4.0 GPM, QUARTER-2.0 GPM, 45 PSI, DETAIL-X.
- HUNTER I-20-06-SS LAWN ROTOR, 30' RADIUS, FULL-4.0 GPM, HALF-2.0 GPM, QUARTER-1.0 GPM, 45 PSI, DETAIL-X.
- HUNTER INDUSTRIES MP ROTATOR SERIES 3000, MOUNTED ON RAIN BIRD 1812-SAM SPRINKLER IN BED AREAS, 30' RADIUS, FULL-4.0 GPM, HALF-2.0 GPM, QUARTER-1.0 GPM, 40 PSI, DETAIL-Y.
- HUNTER INDUSTRIES MP ROTATOR SERIES 2000, MOUNTED ON RAIN BIRD 1812-SAM SPRINKLER IN BED AREA, 20' RADIUS, FULL-2.0 GPM, HALF-1.0 GPM, QUARTER-0.5 GPM, 40 PSI, DETAIL-Y.
- RAIN BIRD DRIP ZONE ASSEMBLY KIT, MODEL #XCZ-100-PRB-COM OR
 - XCZ-150-PRB-COM. 1" OR 1-1/2" SIZE, SIZE NOTED ON PLANS. TO BE INSTALLED WITH RAIN BIRD SINGLE STATION DECODER (FD-101). DETAIL-O.
 - NOTE: FOR ANY DRIP ZONE WITH FLOW UNDER 3 GPM, MUST UTILIZE RAIN BIRD XCZ-LF-100-PRF, LOW FLOW DRIP VALVE ASSEMBLY.
 - POINT OF CONNECTION DRIP LINE TUBING TO PVC PIPE, DETAIL-P,Q.
- DRIP TUBING: RAIN BIRD XFS DRIPLINE DRIP TUBING, .6 GPH, 12" CENTERS, STAKED EVERY TURN OR EVERY 4', INSTALL NETAFIM AIR RELIEF VALVE KIT IN 10" CIRCULAR VALVE BOX AT HIGH POINT OF EACH ZONE AND INSTALL NETAFIM DRIP DRAIN VALVE(S) IN 10" CIRCULAR VALVE BOX AT LOW POINT(S) OF EACH

ZONE. DETAIL-P,Q,R,S,V.

IRRIGATION SYSTEM. DETAIL-D.

- CONTRACTOR SHALL INSTALL RAIN BIRD DRIP OPERATION INDICATOR KIT AT ENDS OF EACH DRIP ZONE AREA (DETAIL-V).
- RAIN BIRD #5 QUICK COUPLING VALVE 1" SIZE. CONTRACTOR TO SUPPLY TWO QCV KEYS AND MATCHING HOSE SWIVELS. DETAIL-F.
- MAINLINE ISOLATION GATE VALVE, DOMESTIC DUCTILE IRON GASKETED, DETAIL-L. AIR VENT VALVE, BERMAD #4420, 2" SIZE. INSTALLED AT HIGH POINTS OF THE
- MAINLINE PIPE: 3" SIZE IF NOT NOTED. CLASS 200 PVC. ALL PIPE 2-1/2" AND LARGER SHALL BE UNIBELL GASKETED PVC PIPE AND HARCO PVC GASKETED FITTINGS. THRUST BLOCKS AND RESTRAINTS TO BE UTILIZED AS PER MANUFACTURER'S
- RECOMMENDATIONS FOR PIPE TYPE, PIPE SIZE, AND LOCAL ENVIRONMENTAL
 - IRRIGATION SLEEVE: CLASS 200 PVC, SIZE NOTED ON PLAN. DETAIL-H.
 - LATERAL LINE PIPE: CLASS 200 PVC SOLVENT WELD PIPE UTILIZING SCH 40 PVC SOLVENT WELD FITTINGS, SIZE NOTED.
- — — ELECTRICAL CONDUIT SLEEVE, REFER TO NOTES ON PLANS.

TYPICAL VALVE INDICATOR






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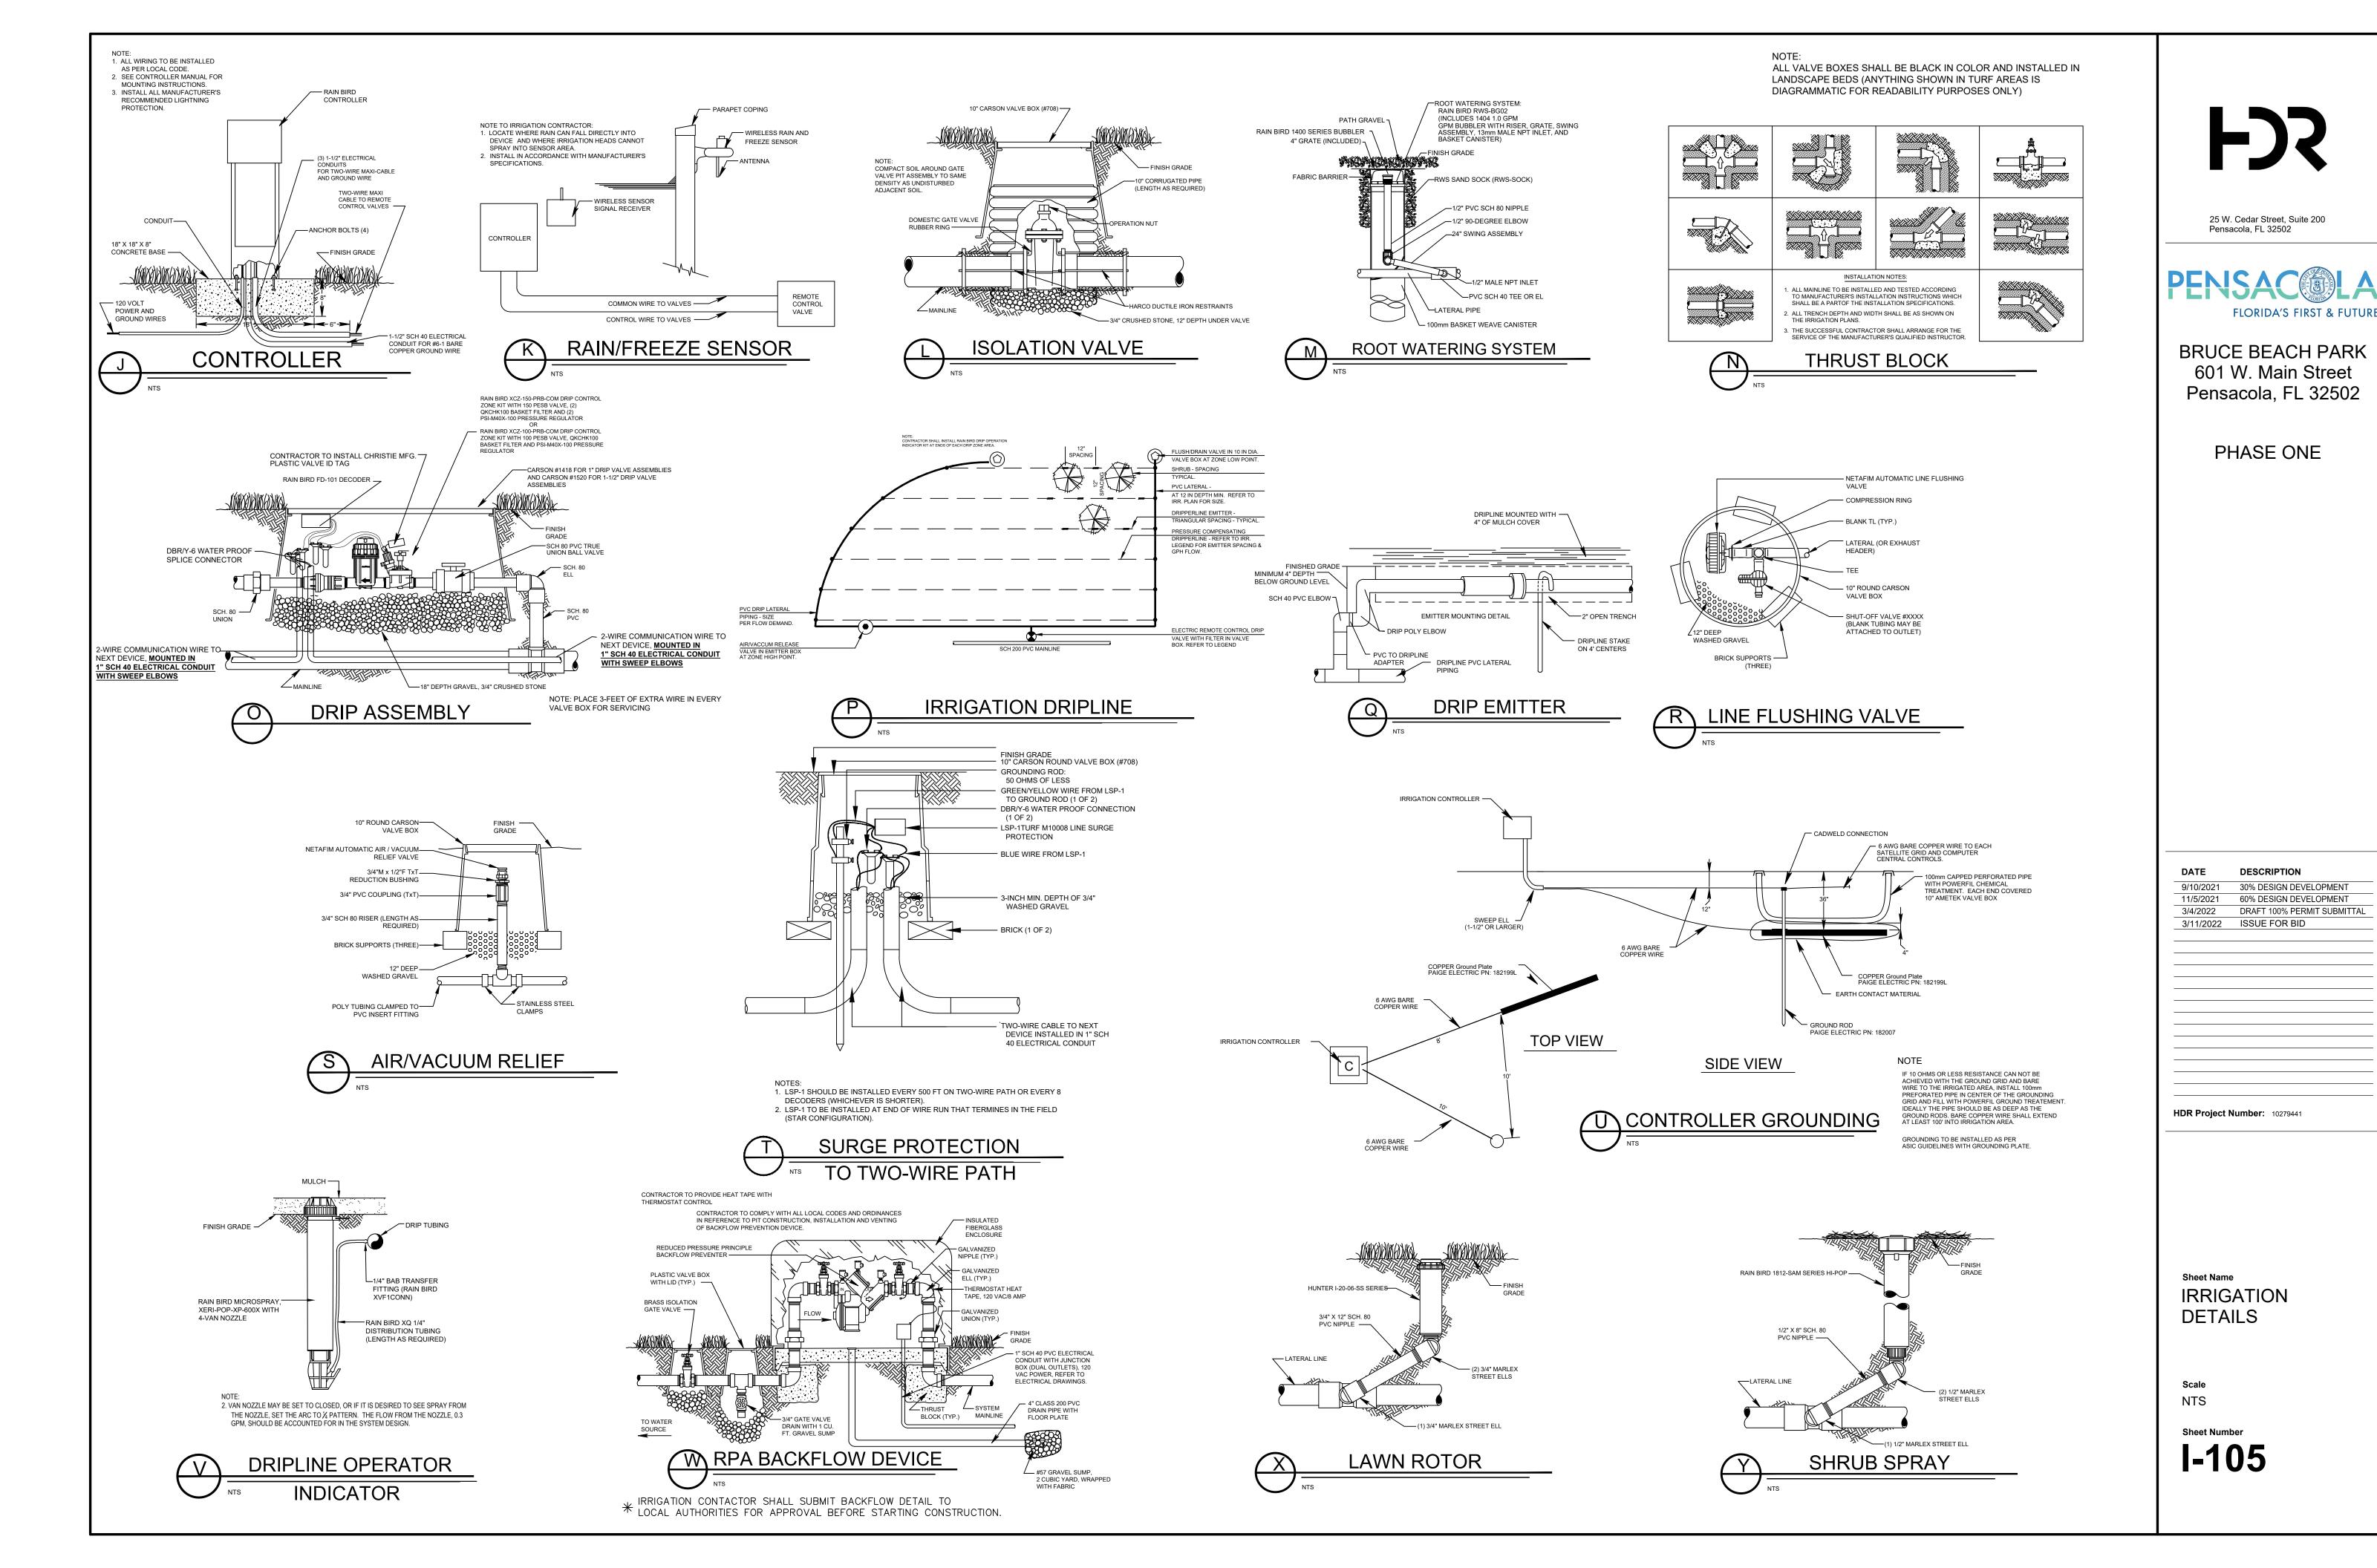
BRUCE BEACH PARK 601 W. Main Street Pensacola, FL 32502


PHASE ONE




HDR Project Number: 10279441

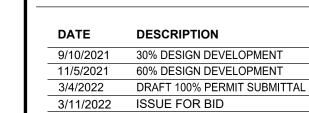Sheet Name IRRIGATION **DETAILS**



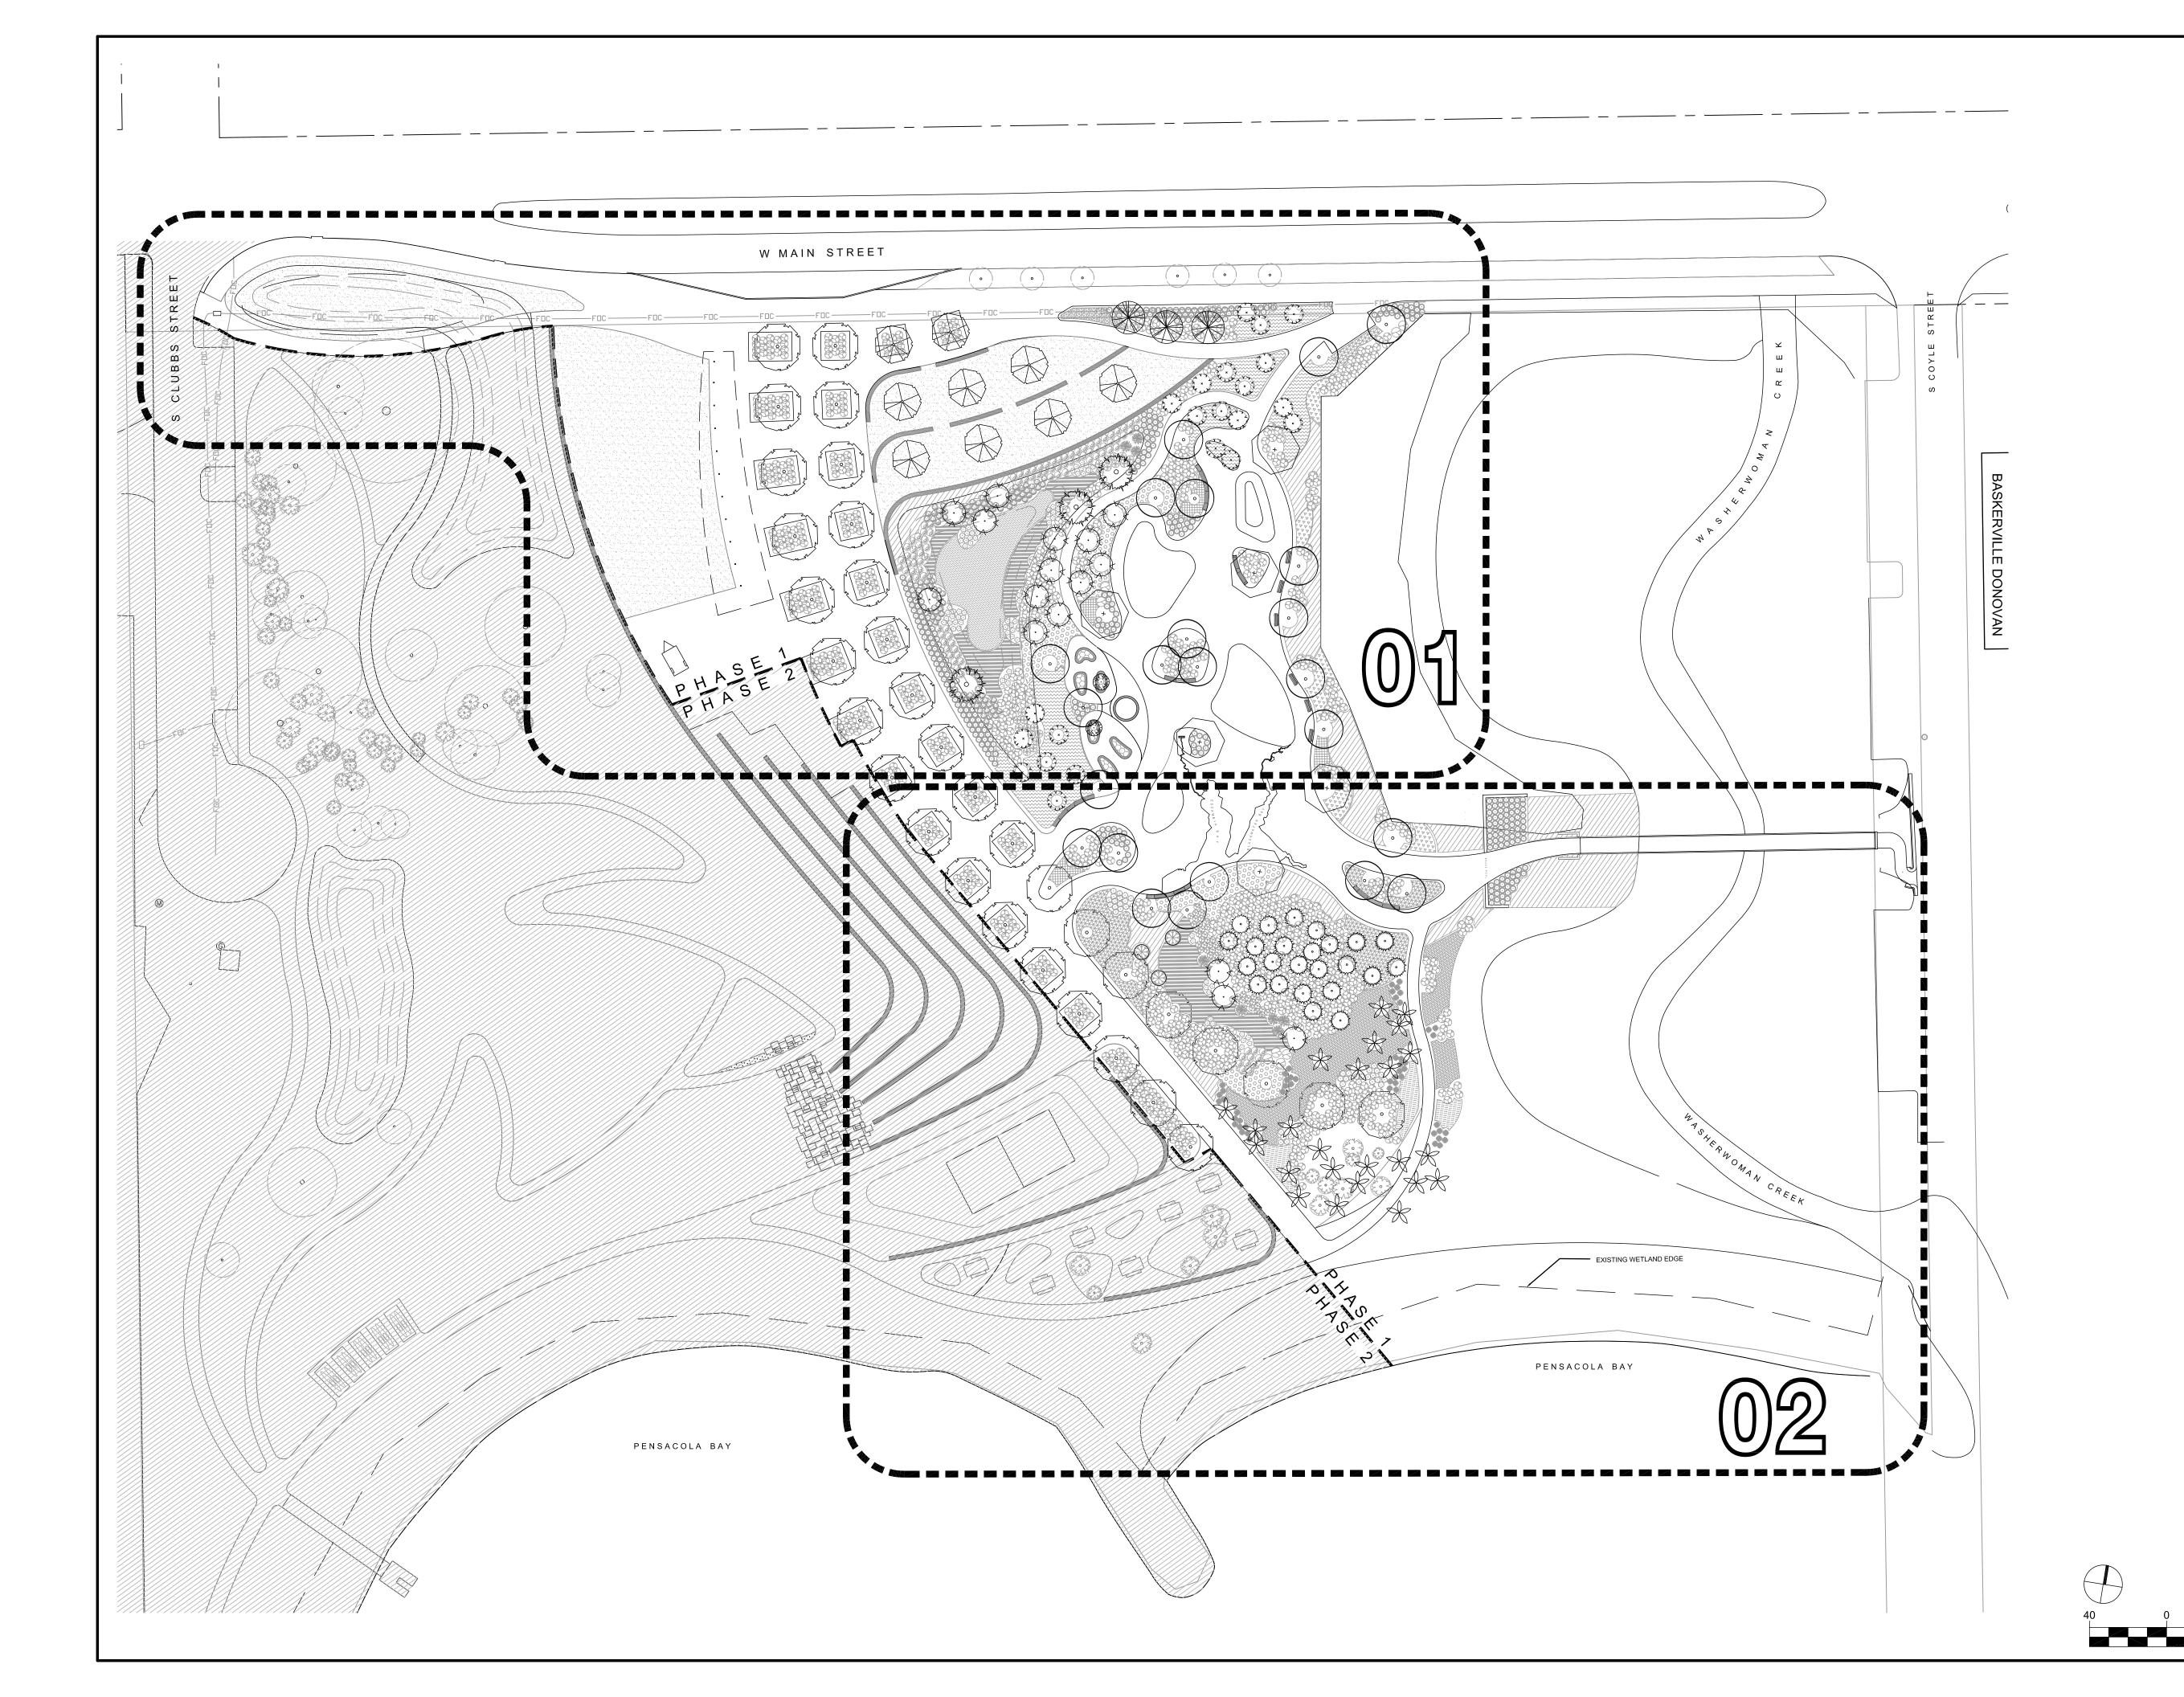

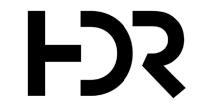



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PHASE ONE


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3/4/20)22 DR	AFT 100% PERMIT SUBMITTAL
3/11/2	2022 ISS	UE FOR BID


HDR Project Number: 10279441

Sheet Name
PLANTING PLAN
- OVERALL

Scale 1" = 30'-0"

1 = 30 -0

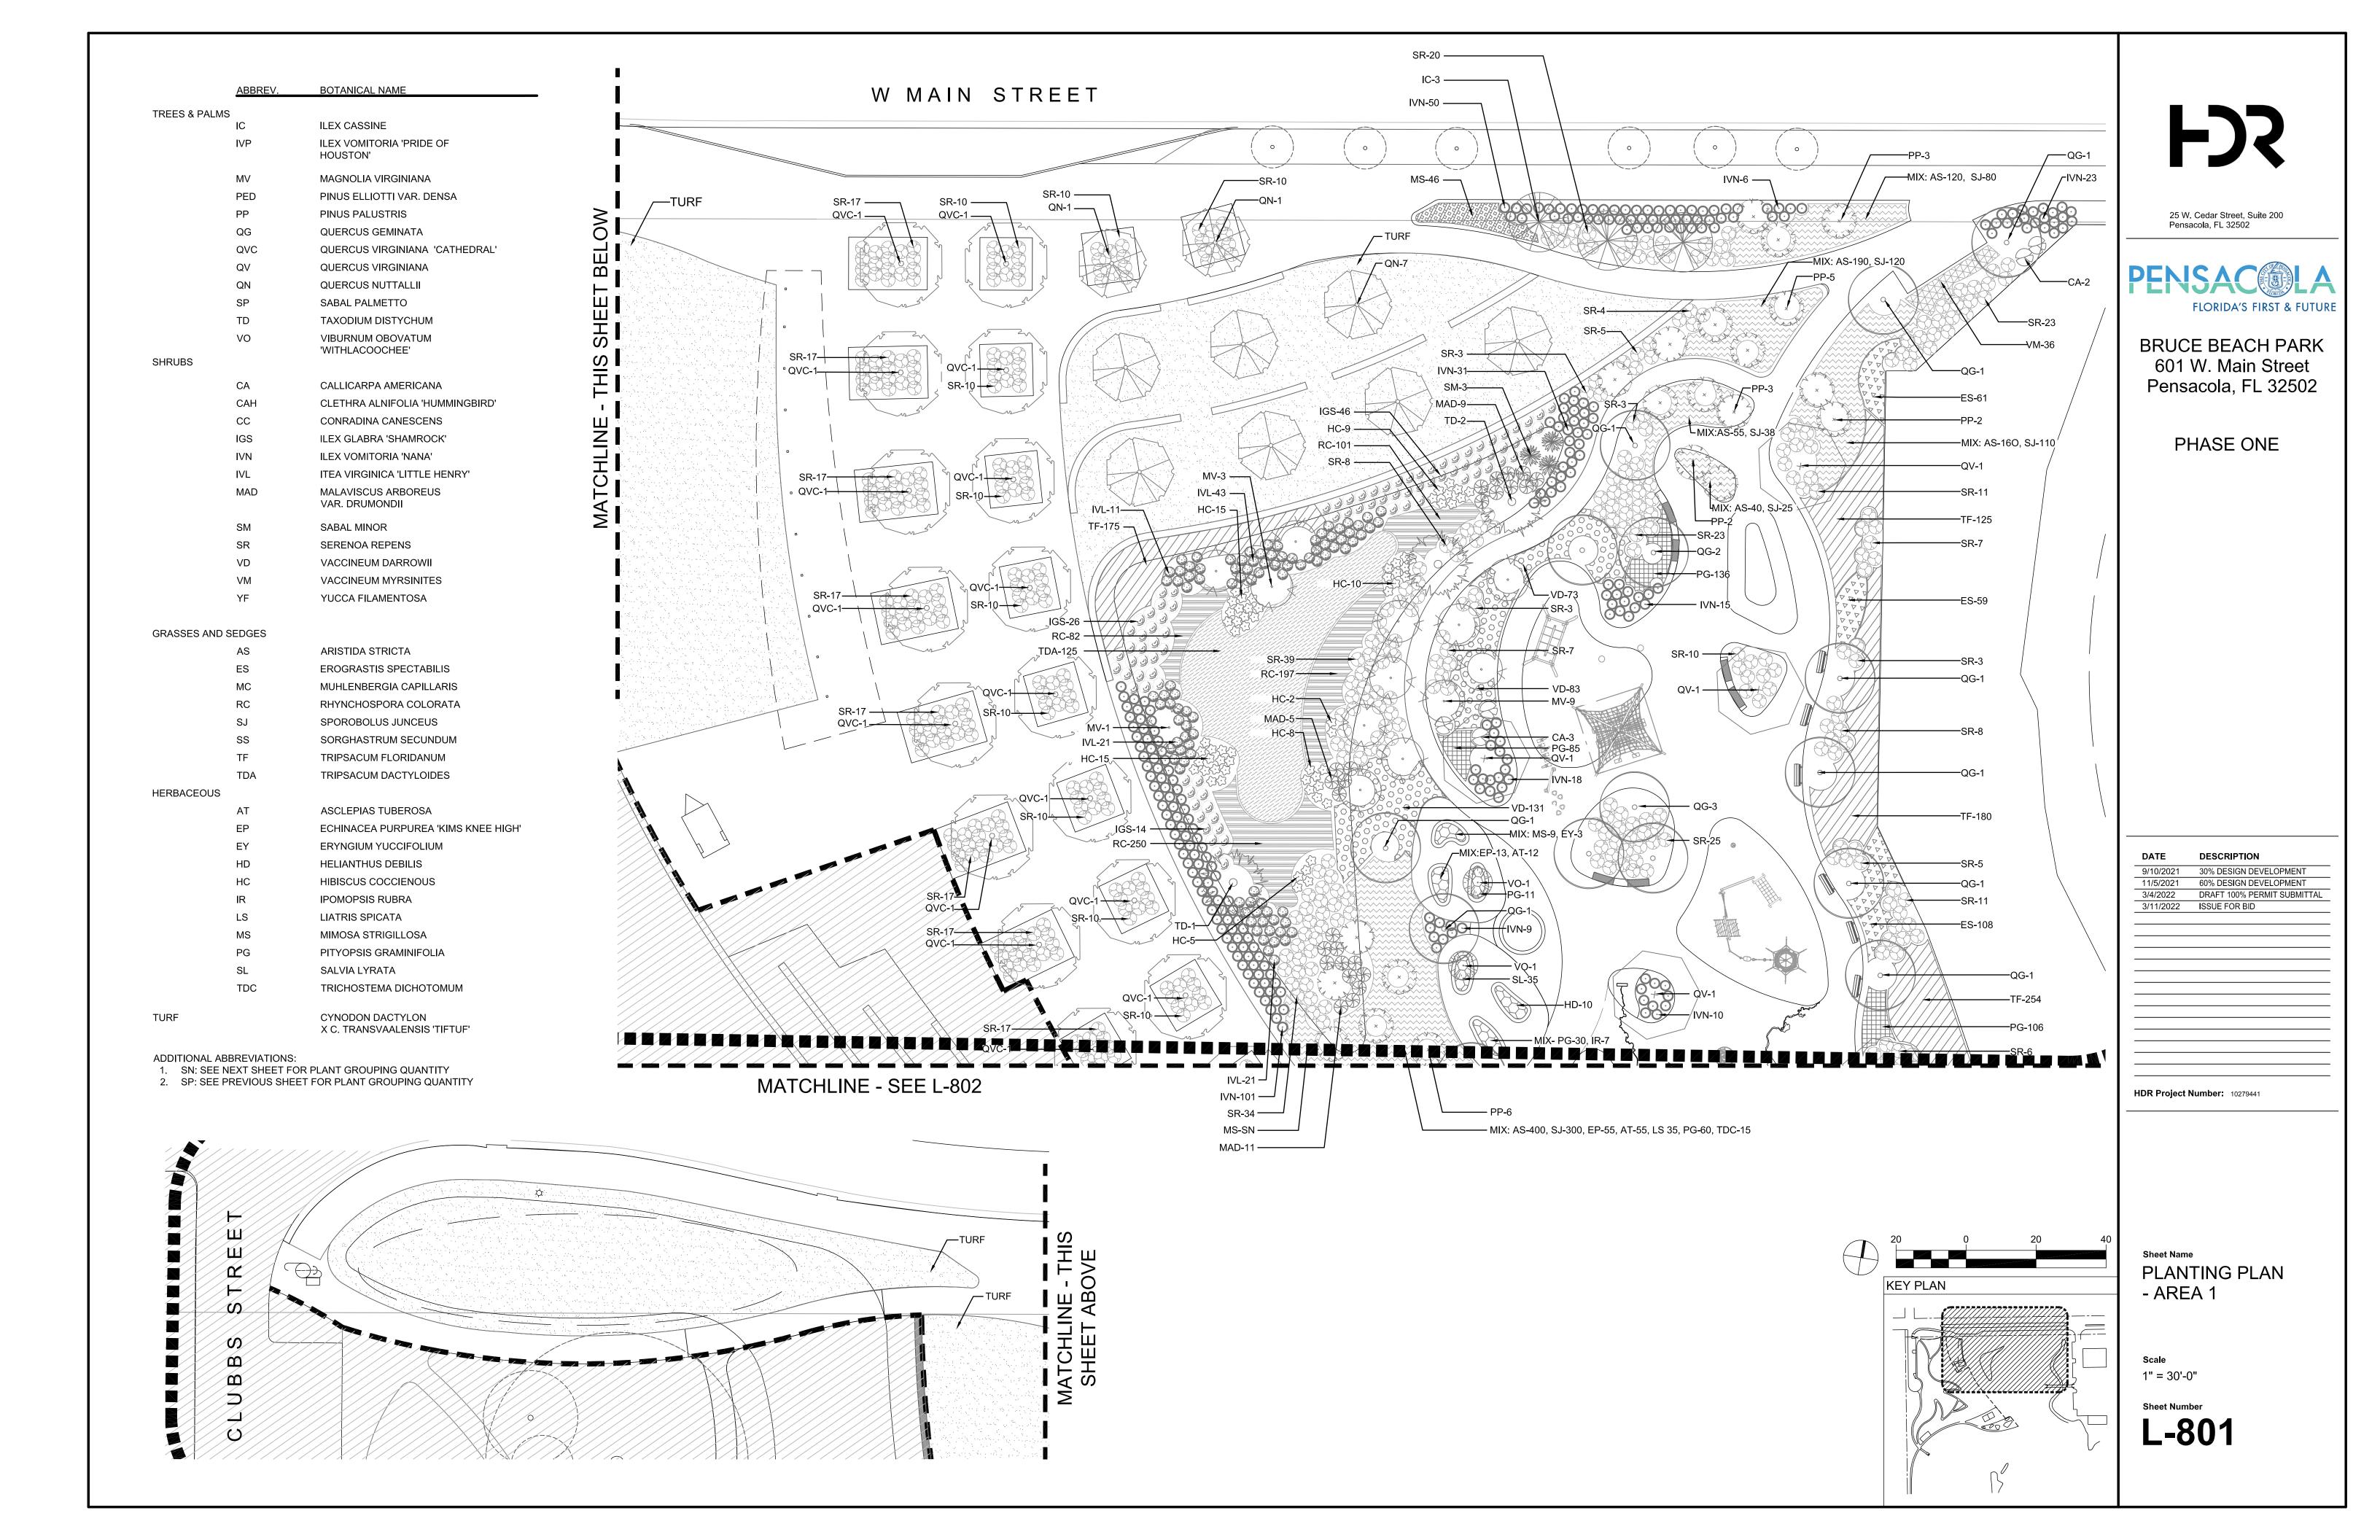

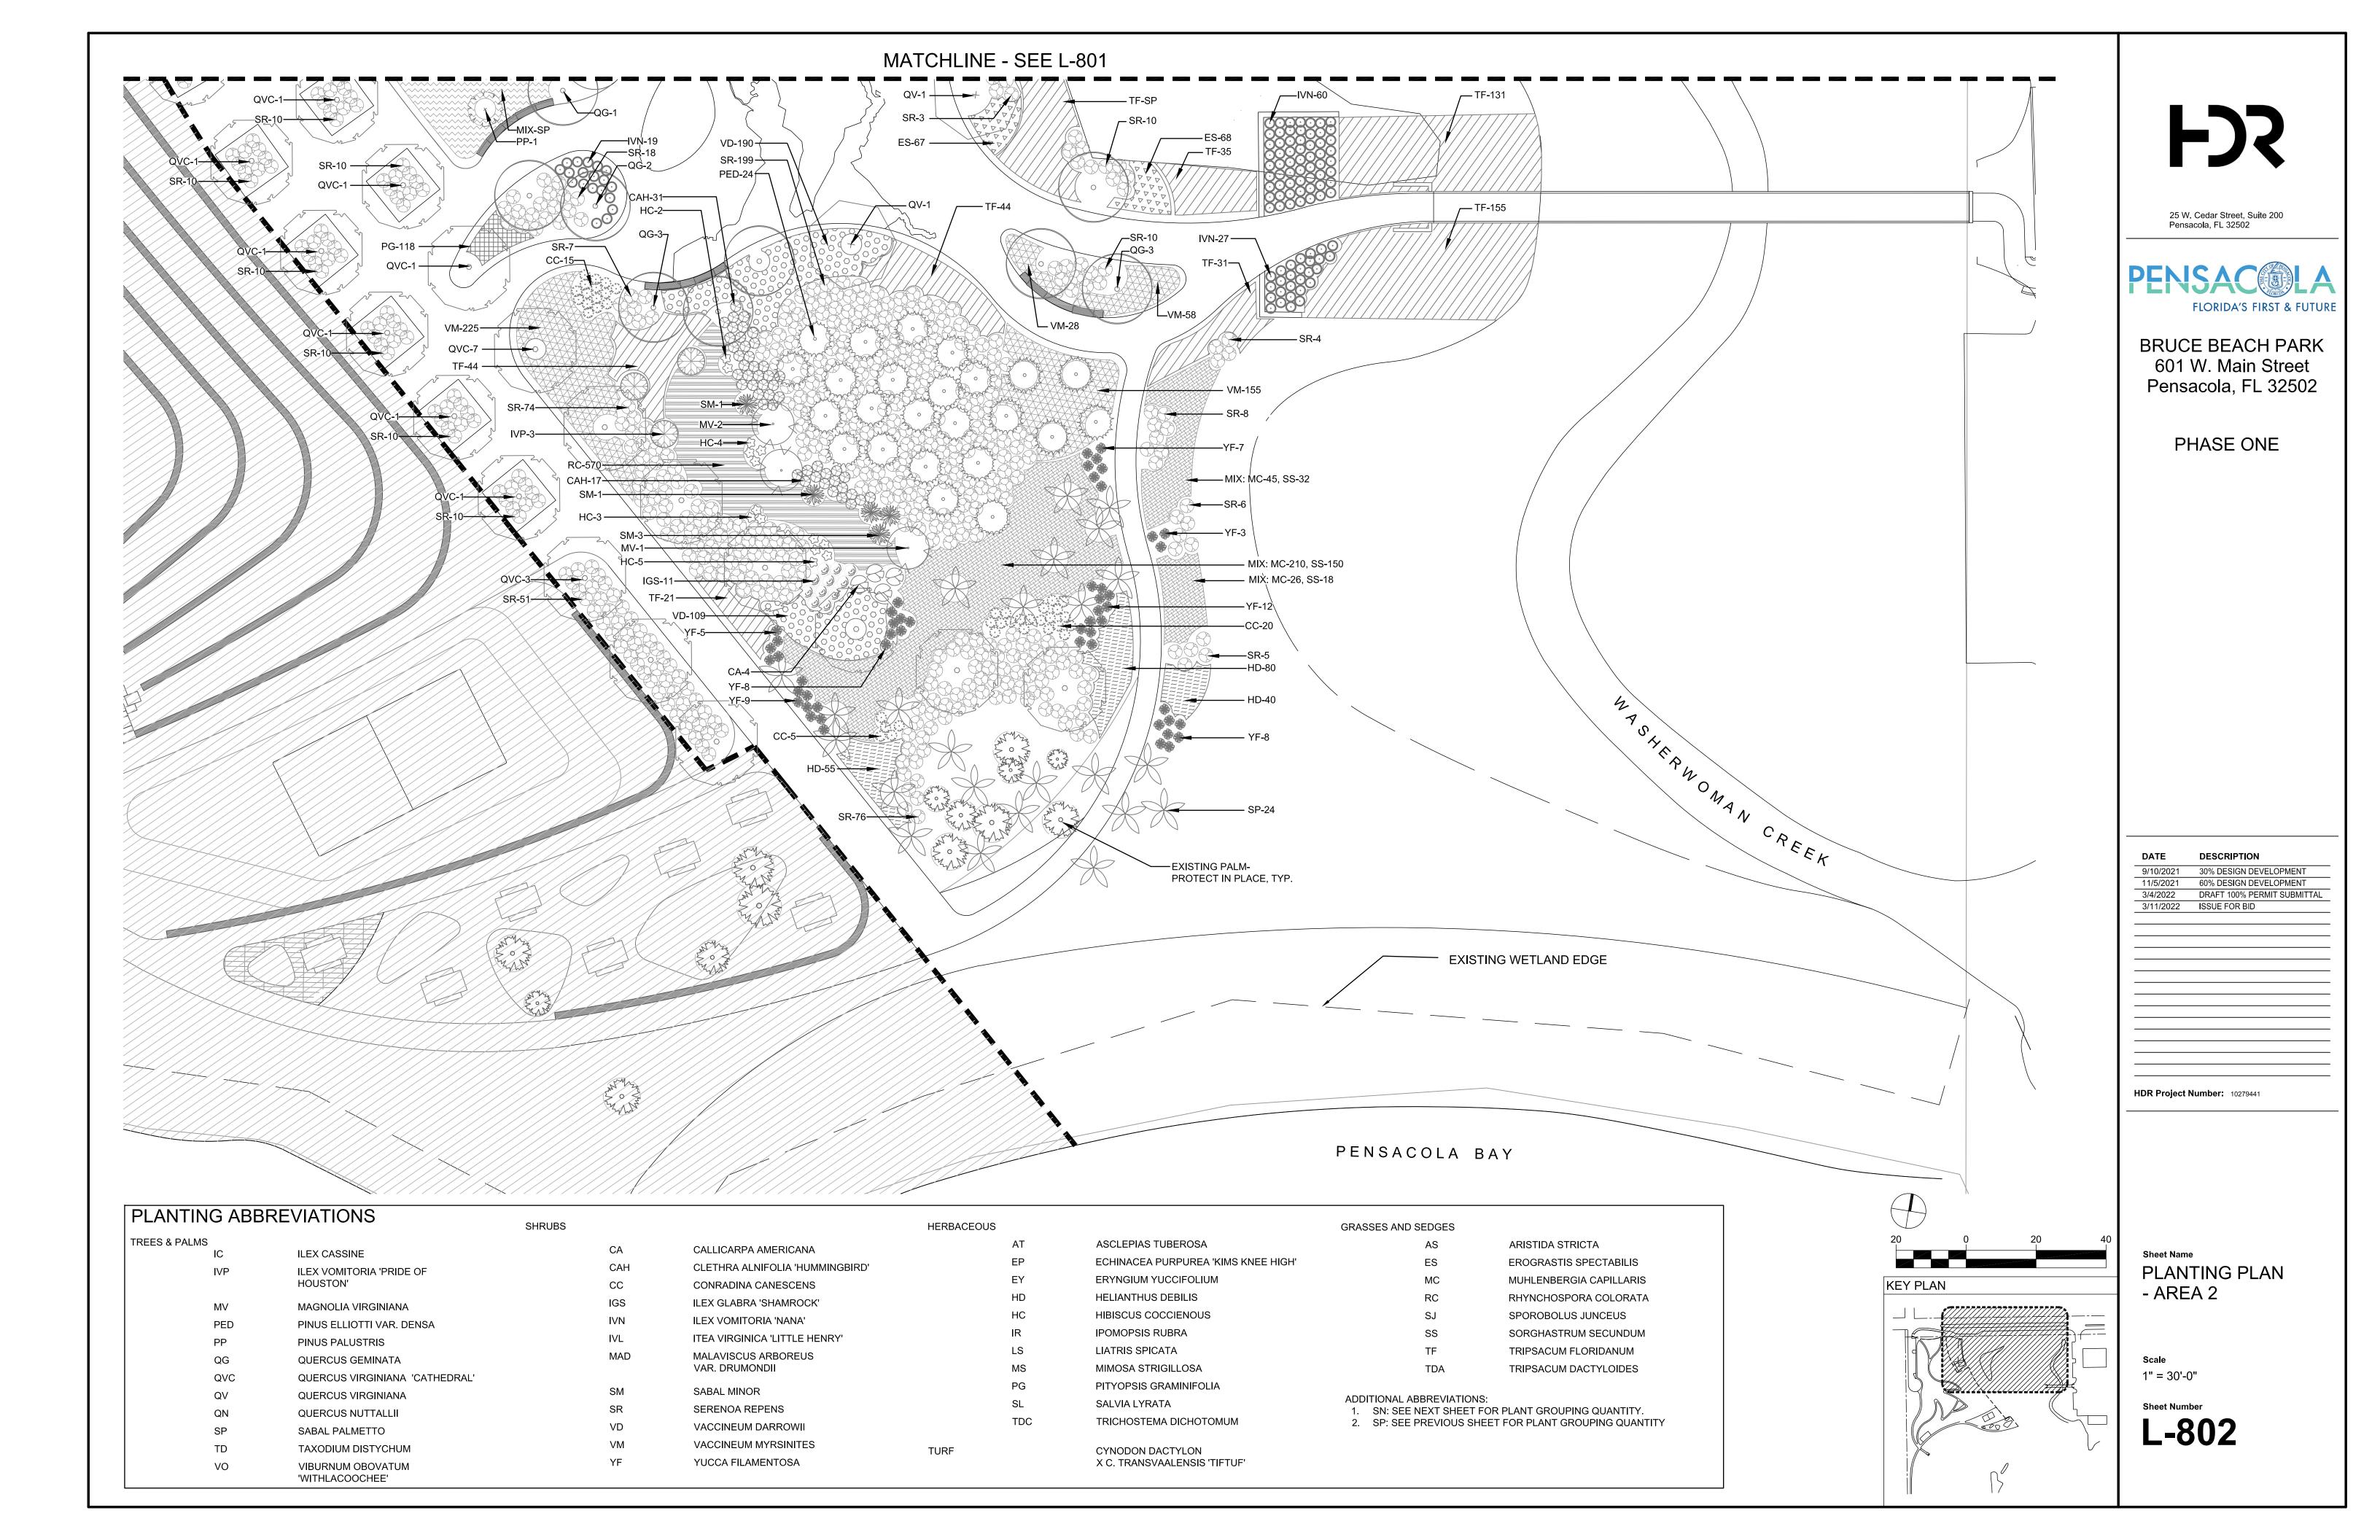

	ABBREV.	BOTANICAL NAME	COMMON NAME	QTTY	SIZE	TYPE	SPACING NOTES
TDEEC 9 DALME							
TREES & PALMS	IC	ILEX CASSINE	DAHOON HOLLY	3	8' HT	B&B	PER PLAN
	IVP	ILEX VOMITORIA 'PRIDE OF HOUSTON'	PRIDE OF HOUSTON YAUPON HOLLY	3	6' HT	CONT.	PER PLAN MULTISTEM
	MV	MAGNOLIA VIRGINIANA	SWEETBAY MAGNOLIA	16	10' HT	B&B	PER PLAN MULTISTEM
	PED	PINUS ELLIOTTI VAR. DENSA	FLORIDA SLASH PINE	24	10' HT	B&B	PER PLAN
	PP	PINUS PALUSTRIS	LONGLEAF PINE	22	10' HT	B&B	PER PLAN
	QG	QUERCUS GEMINATA	SAND LIVE OAK	24	3" CAL	B&B	PER PLAN MULTISTEM
	QVC	QUERCUS VIRGINIANA 'CATHEDRAL'	CATHEDRAL LIVE OAK	34	4" CAL	B&B	PER PLAN
	QV	QUERCUS VIRGINIANA	LIVE OAK	6	4" CAL	B&B	PER PLAN
	QN	QUERCUS NUTTALLII	NUTTALL OAK	9	4" CAL	B&B	PER PLAN
	SP	SABAL PALMETTO	CABBAGE PALM	24	8'-14" HT	B&B	PER PLAN
	TD	TAXODIUM DISTYCHUM	BALD CYPRESS	3	4" CAL	B&B	PER PLAN
OLUDU IDO	VO	VIBURNUM OBOVATUM 'WITHLACOOCHEE'	WITHLACOOCHEE WALTERS VIBURNUM	2	6' HT	CONT	PER PLAN STANDARD TREE FORM
SHRUBS							
	CA	CALLICARPA AMERICANA	BEAUTYBERRY	9	#3	CONT	5' OC
	CAH	CLETHRA ALNIFOLIA 'HUMMINGBIRD'	HUMMINGBIRD CLETHRA	48	#3	CONT	3' O.C
	CC	CONRADINA CANESCENS	FALSE ROSEMARY	40	#3	CONT	3' OC
	IGS	ILEX GLABRA 'SHAMROCK'	SHAMROCK INKBERRY	97	#3	CONT	4' OC
	IVN	ILEX VOMITORIA 'NANA'	DWARF YAUPON HOLLY	360	#3	CONT	3' OC
	IVL	ITEA VIRGINICA 'LITTLE HENRY'	LITTLE HENRY SWEETSPIRE	96	#3	CONT	3' OC
	MAD	MALAVISCUS ARBOREUS VAR. DRUMONDII	TURKS CAP	25	#3	CONT	4' OC
	SM	SABAL MINOR	DWARF PALMETTO	8	#3	CONT	6' OC
	SR	SERENOA REPENS	SAW PALMETTO	1,035	#3	CONT	4' OC
	VD	VACCINEUM DARROWII	DARROW'S BLUEBERRY	586	#3	CONT	2' OC
	VM	VACCINEUM MYRSINITES	SHINY BLUEBERRY	502	#3	CONT	2' OC
	YF	YUCCA FILAMENTOSA	ADAMS NEEDLE	52	#3	CONT	3' OC
GRASSES AND S							
	AS	ARISTIDA STRICTA	WIREGRASS	965	#1	CONT	18" OC
	ES	EROGRASTIS SPECTABILIS	PURPLE LOVEGRASS	363	#1	CONT	18" OC
	MC	MUHLENBERGIA CAPILLARIS	GULF MUHLY	281	#1	CONT	3' OC
	RC	RHYNCHOSPORA COLORATA	WHITETOPPED SEDGE	1,200	#1	CONT	18" OC
	SJ	SPOROBOLUS JUNCEUS	PINEYWOODS DROPSEED	673	#1	CONT	18" OC
	SS	SORGHASTRUM SECUNDUM	LOPSIDED INDIANGRASS	200	#1	CONT	18" OC
	TF	TRIPSACUM FLORIDANUM	DWARF FAKAHATCHEE GRASS	1,708	#1	CONT	2' OC
HERBACEOUS	TDA	TRIPSACUM DACTYLOIDES	FAKAHATCHEE GRASS	125	#3	CONT	4' OC
HERBACEOUS	AT	ASCLEPIAS TUBEROSA	BUTTERFLYWEED	67	#1	CONT	18" OC
	EP	ECHINACEA PURPUREA 'KIMS KNEE HIGH'	KIMS KNEE HIGH CONEFLOWER	68	#1 #1	CONT	18" OC
	EY	ERYNGIUM YUCCIFOLIUM	RATTLESNAKE MASTER	3	#1	CONT	2' OC
	HD	HELIANTHUS DEBILIS	BEACH SUNFLOWER	185	#1	CONT	2' OC
	HC	HIBISCUS COCCIENOUS	SCARLET HIBISCUS	78	#1	CONT	3' OC
	IR	IPOMOPSIS RUBRA	STANDING CYPRESS	7	#1	CONT	18" OC
	LS	LIATRIS SPICATA	DENSE BLAZING STAR	35	#1	CONT	18" OC
	MS	MIMOSA STRIGILLOSA	POWDERPUFF	55	#1	CONT	2' OC
	PG	PITYOPSIS GRAMINIFOLIA	NARROWLEAF SILKGRASS	428	#1	CONT	1' OC
	SL	SALVIA LYRATA	LYRE-LEAVED SAGE	30	#1	CONT	1' OC
	TDC	TRICHOSTEMA DICHOTOMUM	BLUE CURLS	15	#1	CONT.	18" OC
TURF		CYNODON DACTYLON X C. TRANSVAALENSIS 'TIFTUF'	TIFTUF HYBRID BERMUDAGRASS			SOD	





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PHASE ONE


DESCRIPTION
30% DESIGN DEVELOPMENT
60% DESIGN DEVELOPMENT
DRAFT 100% PERMIT SUBMITTAL
ISSUE FOR BID

HDR Project Number: 10279441

Sheet Name
PLANTING SCHEDULE

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FJS

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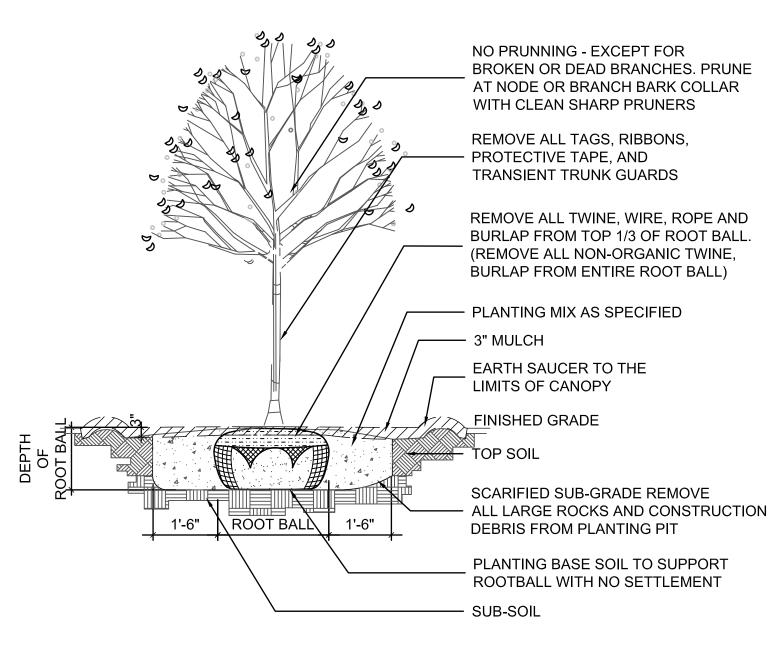
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DATE	DESCRIPTION
9/10/2021	30% DESIGN DEVELOPMENT
11/5/2021	60% DESIGN DEVELOPMENT
3/4/2022	DRAFT 100% PERMIT SUBMITTAL
3/11/2022	ISSUE FOR BID

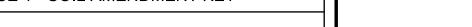HDR Project Number: 10279441

SOIL AMENDMENT PLAN


1" = 30'-0"



- NOTES:


 1. NO SOIL OR MULCH SHALL BE PLACED AGAINST ROOT COLLAR OF PLANT.
- 2. REMOVE ALL ROPE FROM TRUNK & TOP OF ROOT BALL. FOLD BURLAP BACK BELOW GRADE.
- 3. STAKING IS NOT REQUIRED UNLESS PROPER VERTICAL ALIGNMENT OF PLANT CANNOT BE MAINTAINED DUE TO WINDY CONDITIONS, OR IF PLANTING ON A STEEP SLOPE STAKING MAY BE REQUIRED. SEE DETAIL



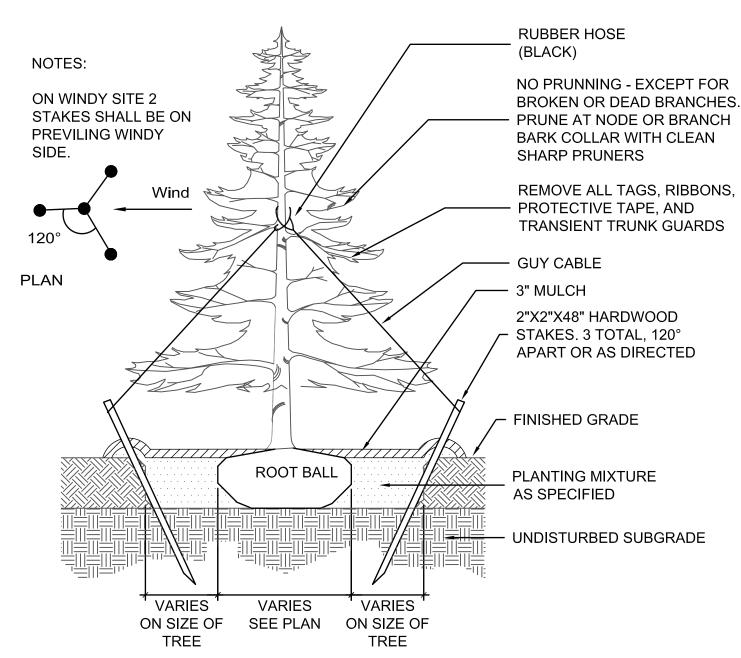

- NOTES:


 1. NO SOIL OR MULCH SHALL BE PLACED AGAINST ROOT COLLAR OF PLANT.
- 2. REMOVE ALL ROPE FROM TRUNK & TOP OF ROOT BALL. FOLD BURLAP BACK BELOW GRADE.
- 3. SEE RELATED PLANTING DETAILS PER TREE SIZE FOR ALL OTHER RELATED DETAILS AND DEPTHS FOR TREE PLANTING.

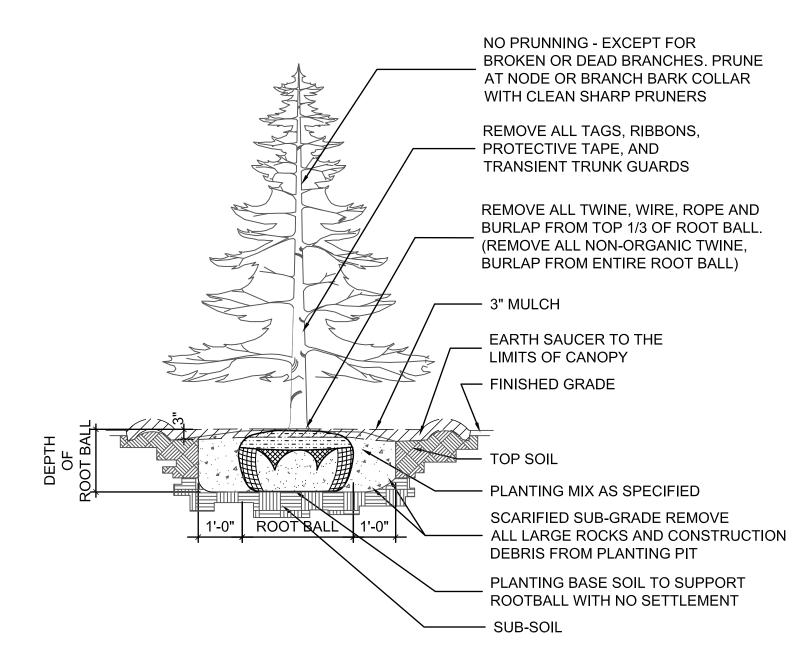

- NOTES:

 1. NO SOIL OR MULCH SHALL BE PLACED AGAINST ROOT COLLAR OF PLANT.
- 2. REMOVE ALL ROPE FROM TRUNK & TOP OF ROOT BALL. FOLD BURLAP BACK BELOW GRADE.
- 3. STAKING IS NOT REQUIRED UNLESS PROPER VERTICAL ALIGNMENT OF PLANT CANNOT BE MAINTAINED DUE TO WINDY CONDITIONS, OR IF PLANTING ON A STEEP SLOPE STAKING MAY BE REQUIRED. SEE DETAIL


3 EVERGREEN TREE PLANTING

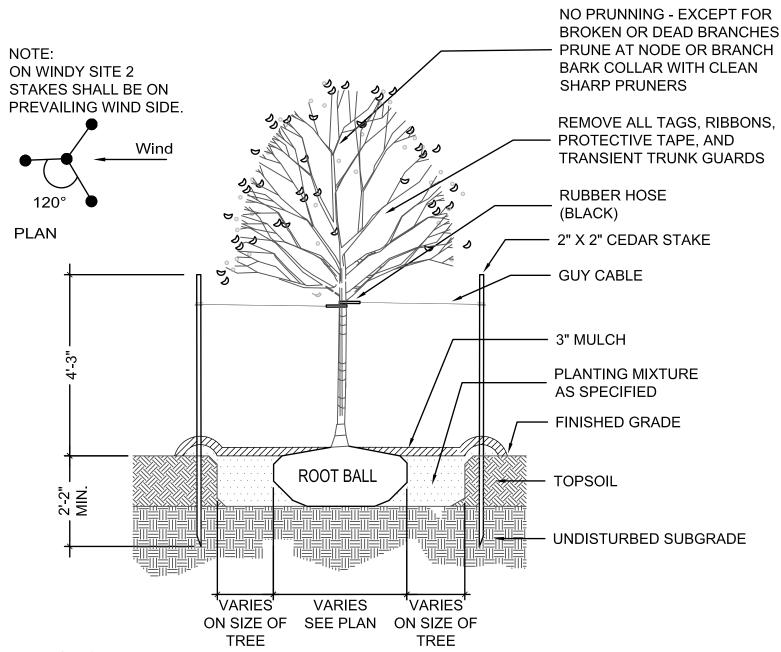

NOTES:

1. NO SOIL OR MULCH SHALL BE PLACED AGAINST ROOT COLLAR OF PLANT.


- 2. REMOVE ALL ROPE FROM TRUNK & TOP OF ROOT BALL. FOLD BURLAP BACK BELOW GRADE.
- 3. SEE RELATED PLANTING DETAILS PER TREE SIZE FOR ALL OTHER RELATED DETAILS AND DEPTHS FOR TREE PLANTING.

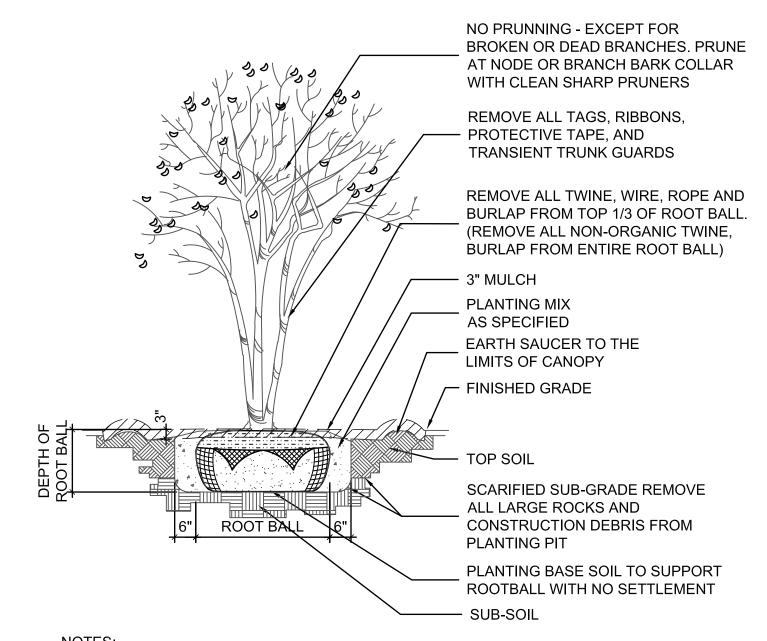

 NO SOIL OR MULCH SHALL BE PLACED AGAINST ROOT COLLAR OF PLANT.

- 2. REMOVE ALL ROPE FROM TRUNK & TOP OF ROOT BALL. FOLD BURLAP BACK BELOW GRADE.
- 3. STAKING IS NOT REQUIRED UNLESS PROPER VERTICAL ALIGNMENT OF PLANT CANNOT BE MAINTAINED DUE TO WINDY CONDITIONS, OR IF PLANTING ON A STEEP SLOPE STAKING MAY BE REQUIRED. SEE DETAIL

UNDERSTORY TREE PLANTING

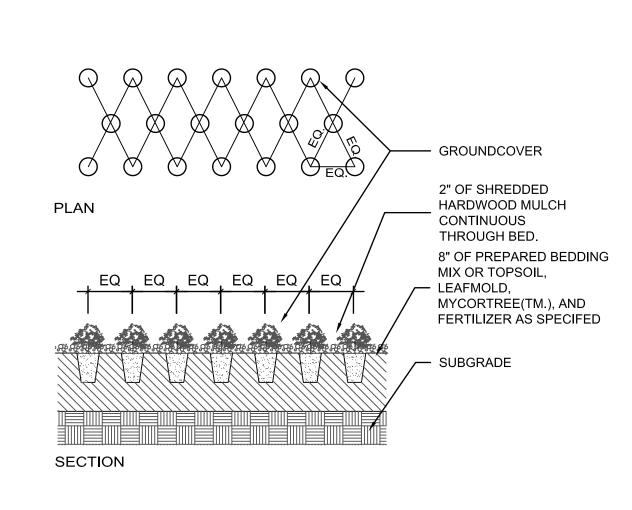

NOTE:

- 1. GROUNDCOVER MUST BE PLANTED IN BEDDING MIX OR TOPSOIL <u>NOT</u> MULCH.
- 2. ON-CENTER SPACING IS INDICATED ON PLANT LIST.

GROUNDCOVER PLANTING



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PHASE ONE

DATEDESCRIPTION9/10/202130% DESIGN DEVELOPMENT11/5/202160% DESIGN DEVELOPMENT3/4/2022DRAFT 100% PERMIT SUBMITTAL3/11/2022ISSUE FOR BID

HDR Project Number: 10279441

Sheet Name
PLANTING DETAILS

Scale

Sheet Number

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6 EVERGREEN TREE STAKING

SHADE TREE STAKING

NO PRUNING - EXCEPT FOR BROKEN OR DEAD FRONDS REMOVE ALL TAGS, RIBBONS, -PROTECTIVE TAPE, BURLAP, AND TRANSIENT TRUNK GUARDS 5 LAYERS OF BURLAP -5-2"X4"X16" WOOD BATTEN CONNECTED W/ 2-3/4" STEEL BANDS 2"X4" WOOD BRACE (3 MIN) TO -NAIL TO BATTEN; ALL WOOD PRESSURE TREATED -3" PINE STRAW MULCH EARTH SAUCER TO THE LIMITS OF CANOPY ── FINISHED GRADE TOP SOIL 100% PURE PLASTER SAND -PLANTING PIT BACKFILL, JET WASH SCARIFIED SUB-GRADE REMOVE ALL LARGE ROCKS AND CONSTRUCTION DEBRIS FROM PLANTING PIT

NOTES:

1. NO SOIL OR MULCH SHALL BE PLACED AGAINST ROOT COLLAR OF PLANT.

9 PALM TREE PLANTING

2. REMOVE ALL TWINE, WIRE, ROPE AND BURLAP FROM TOP 1/3 OF ROOT BALL (REMOVE ALL NON-ORGANIC TWINE, BURLAP FROM ENTIRE ROOT BALL); FOLD BURLAP BACK BELOW GRADE.

PLANTING BASE SOIL TO SUPPORT


ROOTBALL WITH NO SETTLEMENT

-SUB-SOIL

TOP OF THE CONTAINER SHALL BE
— FLUSH WITH THE SURROUNDING REMOVE THE CONTAINER COMPLETELY. MAKE 4 TO 8(DEPENDING ON THE SIZE _ OF THE ROOT BALL) — 1" DEEP CUTS
THE LENGTH OF THE ROOTBALL.LOOSEN
POT BOUND ROOTS, AND SPREAD ON
SCARIFIED SUBGRADE. SCARIFIED SUB-GRADE REMOVE ALL LARGE ROCKS AND CONSTRUCTION DEBRIS FROM PLANTING PIT — 3" MULCH — FORM SAUCER FINISHED GRADE H TOPSOIL PLANTING MIX AS SPECIFIED - UNDISTURBED SUBGRADE PLANTING BASE IS TO BE - UNDISTURBED SOIL TO SUPPORT

CONTAINER.

SHRUB PLANTING

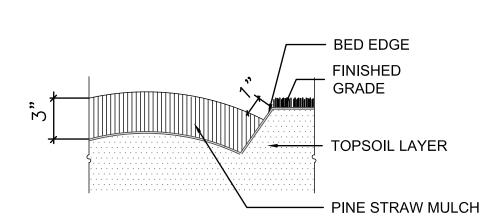

2 EDGE DETAIL




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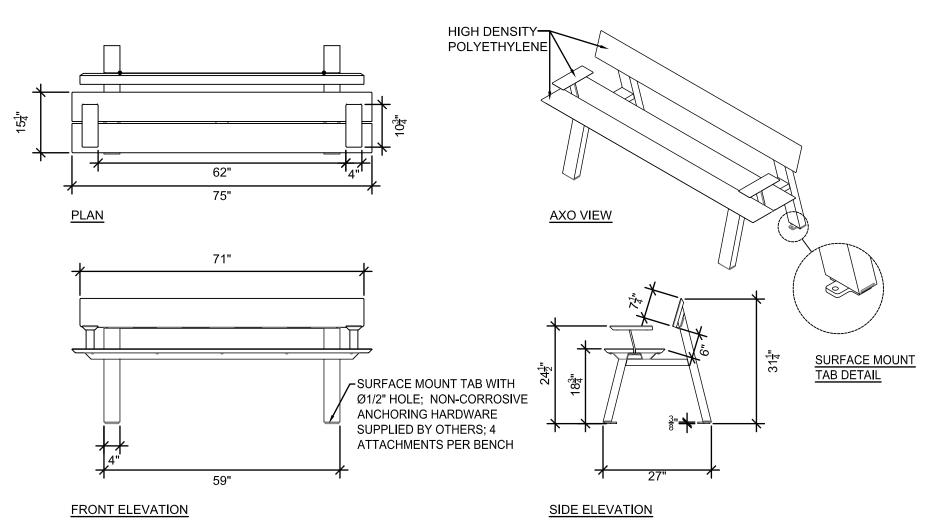
PHASE ONE



HDR Project Number: 10279441

Sheet Name PLANTING DETAILS

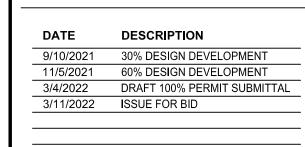Sheet Number



MANUFACTURER: LANDSCAPE FORMS / LOLL DESIGNS MODEL: GLIDE BENCH, WITH ARMS (OR APPROVED EQUAL) MATERIAL: HIGH-DENSITY POLYETHYLENE (HDPE) FINISH: LEAF GREEN

MANUFACTURER: LANDSCAPE FORMS

TETHERED TO TABLE WITH BRAIDED STAINLESS STEEL CABLE, MIN $\frac{1}{4}$ "Ø

MODEL: PARC CENTRE CHAIR -

FINISH: 'BUTTERCUP' GLOSS

MOUNTING: FREESTANDING,

(OR APPROVED EQUAL)

MOUNTING: SURFACE

ARMLESS

POWDERCOAT

FRONT ELEVATION

CAFE CHAIRS

6 BACKED BENCH


HIGH-DENSITY -POLYETHYLENE —ALUMINUM FRAME **AXO VIEW** SURFACE MOUNT TAB WITH 7/16 THRU-HOLE; ATTACH WITH NON-CORROSIVE ANCHORING HARDWARE (4 EA CHAIR) FRONT ELEVATION SIDE ELEVATION

MANUFACTURER: LANDSCAPE FORMS / LOLL DESIGNS MODEL: AMERICANA CHAIR (OR APPROVED EQUAL) MATERIAL: HIGH-DENSITY POLYETHYLENE (HDPE)

FINISH: LEAF GREEN MOUNTING: SURFACE

@ SAND: CONNECT CHAIRS TO ONE ANOTHER VIA VINYL-COATED BRAIDED STAINLESS STEEL CABLE TETHER, LAY CABLE ON GRADE BELOW SAND @ DECK: FASTEN TO DECK PER DETAIL

LOUNGE CHAIRS

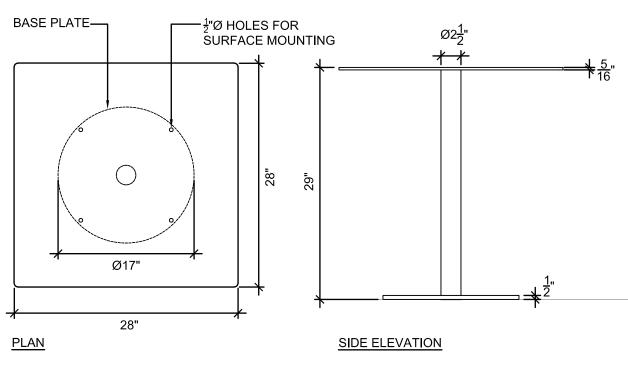


MANUFACTURER: LANDSCAPE FORMS MODEL: PARC CENTRE SQUARE (OR APPROVED EQUAL)

FINISH: 'BUTTERCUP' GLOSS POWDERCOAT MOUNTING: SURFACE

END/GATE BRACKET

- 1. PROVIDE 4 CHAIRS PER TABLE FOR 50% TOTAL QUANTITY SHOWN IN PLAN, REMAINING 50%, PROVIDE 3 TO MEET ACCESSIBILITY REQUIREMENTS
- 2. CHAIRS TO BE CABLE-TETHERED TO TABLES WITH VINYL-COATED BRAIDED STAINLESS STEEL CABLE, MIN ¹/₄"Ø

CAFE TABLE

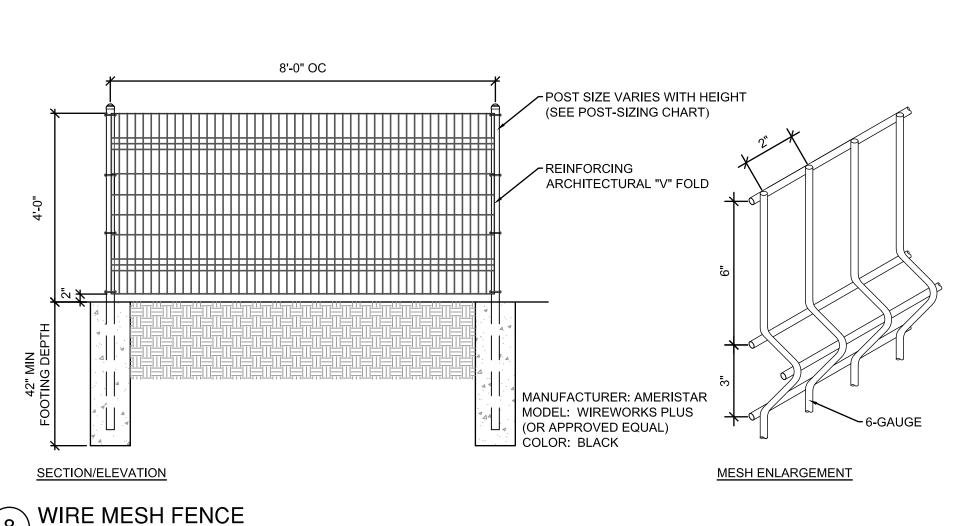

-NON-MARRING GLIDES


SIDE ELEVATION

1. POST SIZE DEPENDS ON FENCE HEIGHT AND WIND LOADS; SEE WIREWORKS PLUS POST-SIZING CHART 2. ARCHITECTURAL "V" FOLDS VARIES WITH HEIGHT; 4'

HEIGHT (2 FOLDS) 3. VALUES SHOWN ARE NOMINAL AND NOT TO BE USED

FOR INSTALLATION PURPOSES

4. SEE PRODUCT SPECIFICATION FOR INSTALLATION REQUIREMENTS

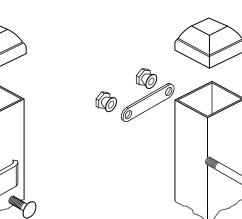


LINE BRACKET

MOUNTING -ANCHORS

SIDE ELEVATION


MANUFACTURER: FORMS + SURFACES MODEL: CAPITOL (OR APPROVED EQUAL) FINISH: SILVER TEXTURE POWDERCOAT MOUNTING: EMBED

BIKE RACK

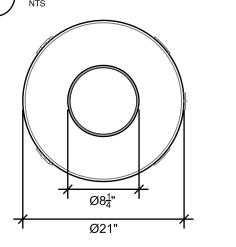

MANUFACTURER: LANDSCAPE FORMS MODEL: LAKESIDE, TOP OPENING, GRASS PATTERN (OR APPROVED EQUAL) FINISH: SILVER TEXTURE POWDERCOAT MOUNTING: SURFACE


<u>PLAN</u>

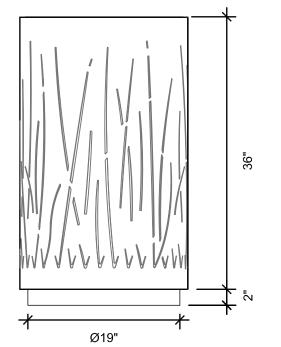

— FREESTANDING OR SURFACE MOUNT OPTIONS: 7/6"Ø MOUNTING HOLES; HARDWARE SUPPLIED BY OTHERS

ELEVATION MOUNTING DETAIL TRASH & RECYCLING RECEPTACLES

$1\frac{1}{2}$ " x $3\frac{1}{2}$ " MODIFIED

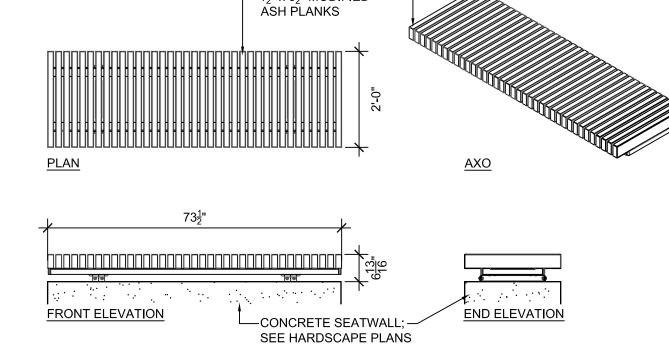

MANUFACTURER: ANOVA MODEL: INF24L6WT INFINITY WALL-MOUNTED BENCH WITH CENTER ARMREST (OR APPROVED EQUAL) MATERIAL: NATURAL MODIFIED ASH PLANKS AND GALVANIZED STEEL MOUNTING: SURFACE

WALL-MOUNTED BENCH

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PHASE ONE


DATE	DESCRIPTION
9/10/2021	30% DESIGN DEVELOPMENT
11/5/2021	60% DESIGN DEVELOPMENT
3/4/2022	DRAFT 100% PERMIT SUBMITTAL
3/11/2022	ISSUE FOR BID

HDR Project Number: 10279441

Sheet Name SITE DETAILS -SITE FURNISHINGS

AS NOTED

Sheet Number

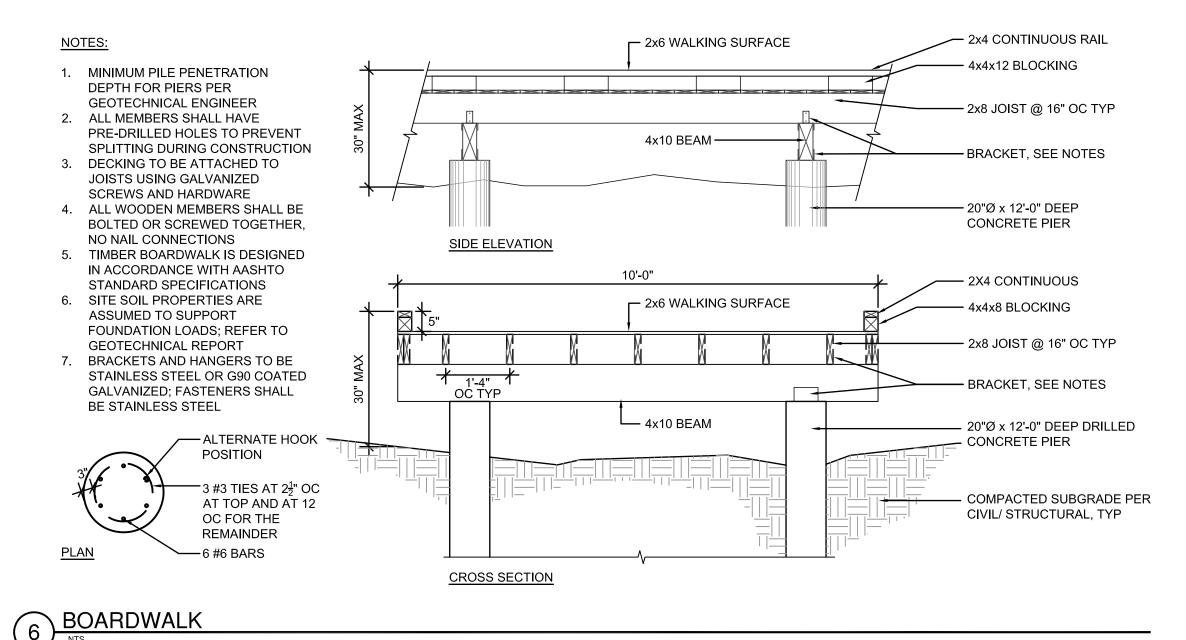


TOP SURFACE; $\frac{1}{2}$ " THICK MIN POURED-IN-PLACE BASEMAT; THICKNESS ——— DETERMINED BY EQUIPMENT MANUFACTURER PER CRITICAL FALL HEIGHTS 100% BLEND RECYCLED SBR AND URETHANE COMPACTED SUBGRADE - 6" MIN COMPACTED AGGREGATE BASE, EDGE CONDITION OR SLOPE TO DRAIN CONTAINMENT CURB, PER PLAN; MAINTAIN 12" MIN DEPTH

4 RESILIENT PLAYGROUND SURFACING

WITH GRADE

POURED-IN-PLACE EPDM AND URETHANE ---

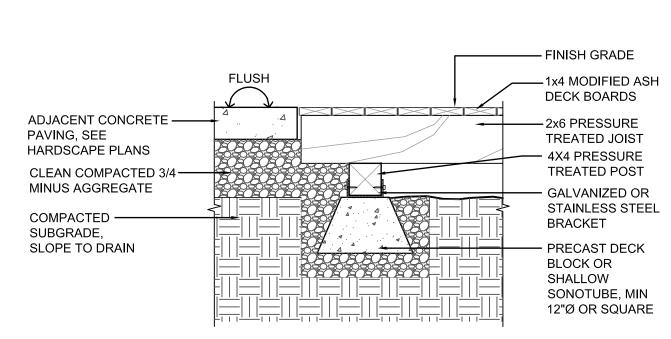

- 1. ALL MEMBERS SHALL HAVE PRE-DRILLED HOLES TO PREVENT SPLITTING DURING
- 2. DECKING TO BE ATTACHED TO JOISTS USING GALVANIZED SCREWS AND HARDWARE
- 3. ALL WOODEN MEMBERS SHALL BE BOLTED OR SCREWED TOGETHER, NO NAIL
- 4. SITE SOIL PROPERTIES ARE ASSUMED TO SUPPORT FOUNDATION LOADS; REFER TO GEOTECHNICAL REPORT
- 5. BRACKETS AND HANGERS TO BE STAINLESS STEEL OR G90 COATED GALVANIZED; FASTENERS SHALL BE STAINLESS STEEL




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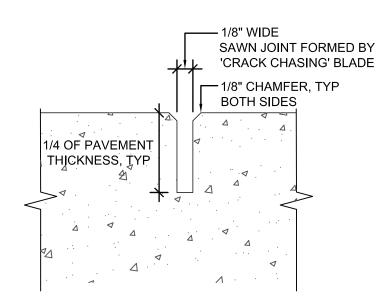



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PHASE ONE



CONCRETE PAVING

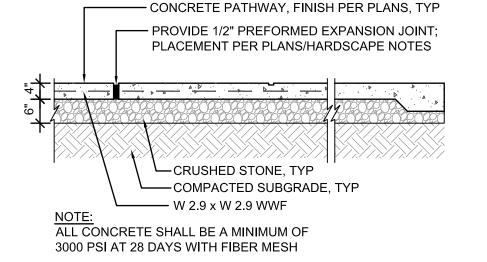

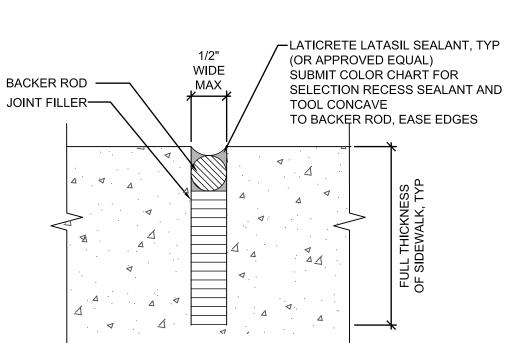

3 EXPANSION JOINT

DATE	DESCRIPTION
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3/4/2022	DRAFT 100% PERMIT SUBMITTAL
3/11/2022	ISSUE FOR BID

HDR Project Number: 10279441

Sheet Name SITE DETAILS -**GENERAL**


AS NOTED

Sheet Number

 $-1\frac{1}{2}$ "Ø DRAIN LINE AT MIN 2% SLOPE TO SUMP 6'-0" MIN 2'-0" MIN —10" MIN COMPACTED BACKFILL AND SOD OVER SUMP SLOPE TO DRAIN SLOPE TO DRAIN, PER HARDSCAPE PLANS SUMP PIT COMPACTED SUBGRADE -GATE VALVE ASSEMBLY; VEHICLE-RATED — 2"Ø CRUSHED STONE: VALVE BOX WITH CONCRETE SUPPORT, -20"Ø x 31" HDPE LEVEL WITH FINISH GRADE PERFORATED FILTER FABRIC — SUMP LINER, WRAPPED AROUND FILLED WITH $\frac{3}{4}$ "Ø SUMP LINER CRUSHED STONE LINE SIDES OF -SUMP WITH GEOTEXTILE FABRIC

— DRINKING FOUNTAIN, TYP

7 SUMP AT DRINKING FOUNTAIN

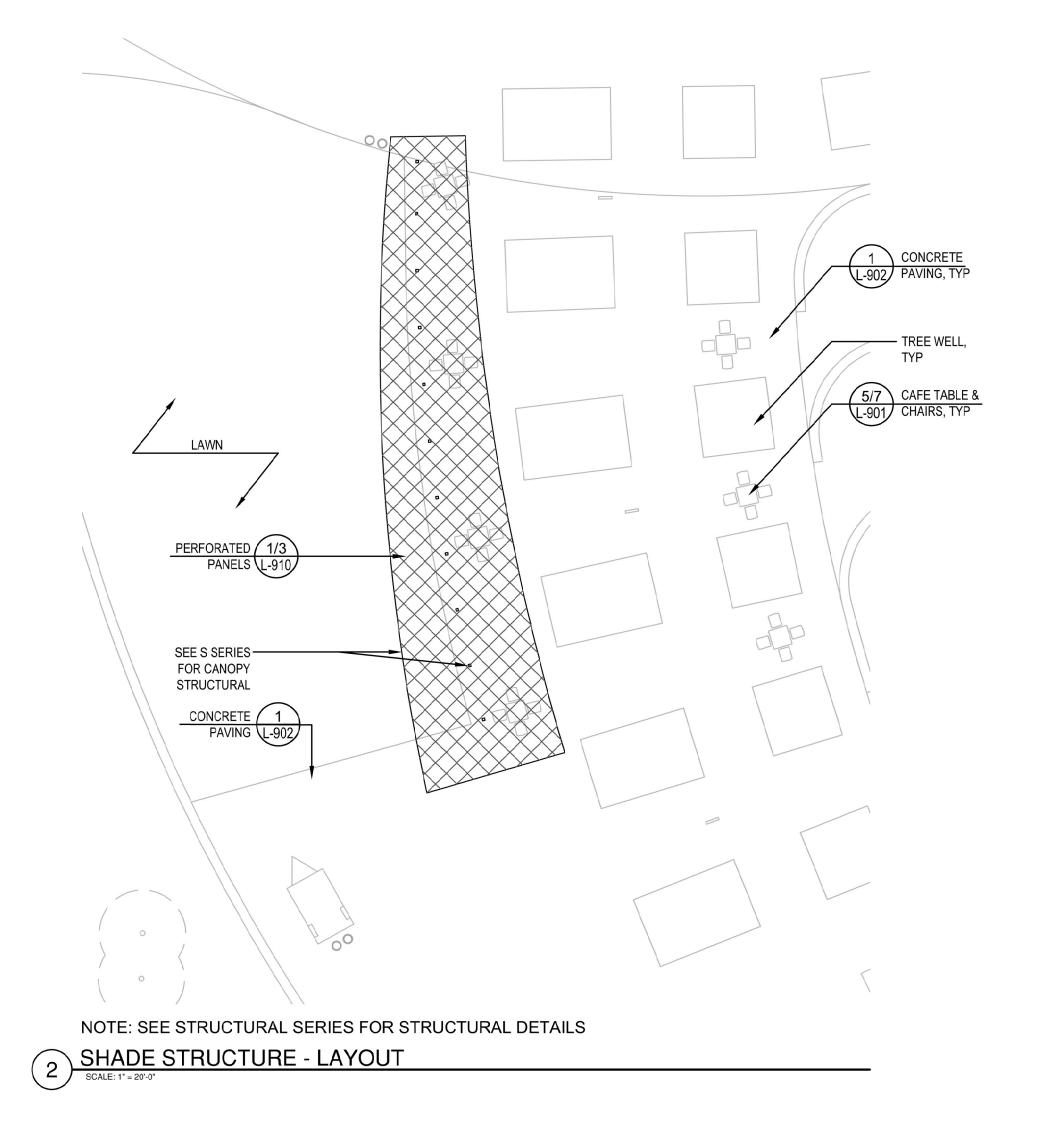




6510 W 91st Ave, Suite 100 Westminster, CO 80031 (303) 589-4524 hello@parasoleil.com www.parasoleil.com

Quiet Wood[©] (QWD)

An old-growth forest, a grove of trees behind the neighborhood, a backpacking in a national park. Think of it what you will. This has strong, organic lines that soften the architecture and, if done well, can create welcoming spaces people will want to use.



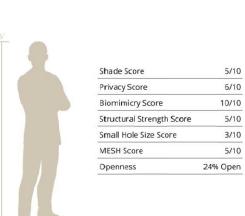


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RECOMMENDED PATTERN: QUIET WOOD (C) PANEL SIZE: 4' X 8'

SHADE STRUCTURE - PANEL



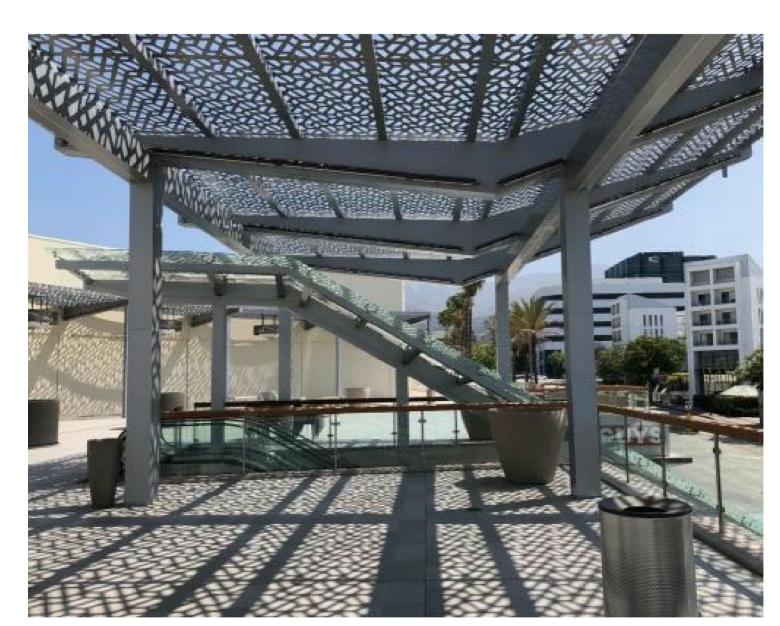

LASER-CUT METAL PANELS, PARASOLEIL OR SIMILAR
POWDERCOATED, WEATHERED STEEL OR ALUMINUM TO COORDINATE WITH WAYFINDING DESIGN; STEEL POWDERCOATED POSTS

3 SHADE STRUCTURE AESTHETIC




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SHADE
STRUCTURE
AESTHETICS


Scale AS NOTED

CONTECH BRIDGE

THE BRIDGE SHOWN HAS BEEN DESIGNED BY CONTECH ENGINEERED SOLUTIONS, LLC (CONTECH). SEE PROJECT SPECIFICATIONS FOR MORE INFORMATION. THE BRIDGE WILL BE MANUFACTURED AND SHIPPED BY CONTECH. INSTALLATION SPECIFICATIONS, SUBSTRUCTURE DESIGN, AND ASSOCIATED QUANTITIES WILL BE PROVIDED THROUGH COORDINATION WITH CONTECH. THE MATERIALS AND INSTALLATION FOR THE SUBSTRUCTURE WILL BE PROVIDED BY THE CONTRACTOR. CONTACT CONTECH - REF PROJECT 691170, PHONE 205-306-3277

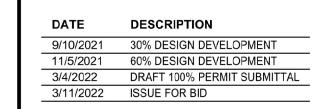


2 PRECEDENT PHOTO

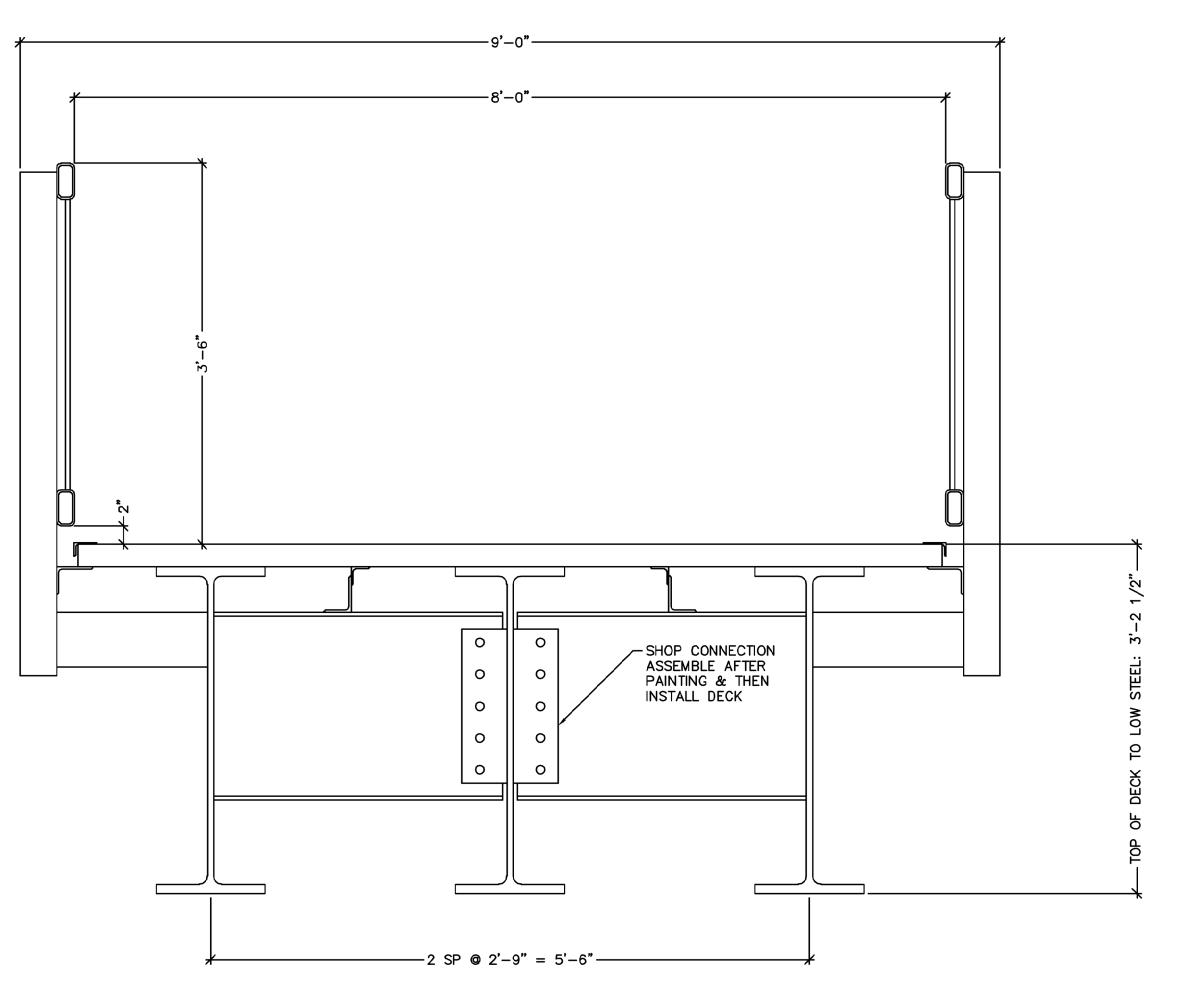

CONTECH BRIDGE

- 154' X 8' ROLLED GIRDER
- 138 MPH ASCE 7-05 WIND SPEED (PENSACOLA, FL)
- DESIGNED TO AASHTO PEDESTRIAN 90 PSF + 2,500 LB VEHICLE (SMALL UTILITY VEHICLE)

PEDESTRIAN BRIDGE - SECTION

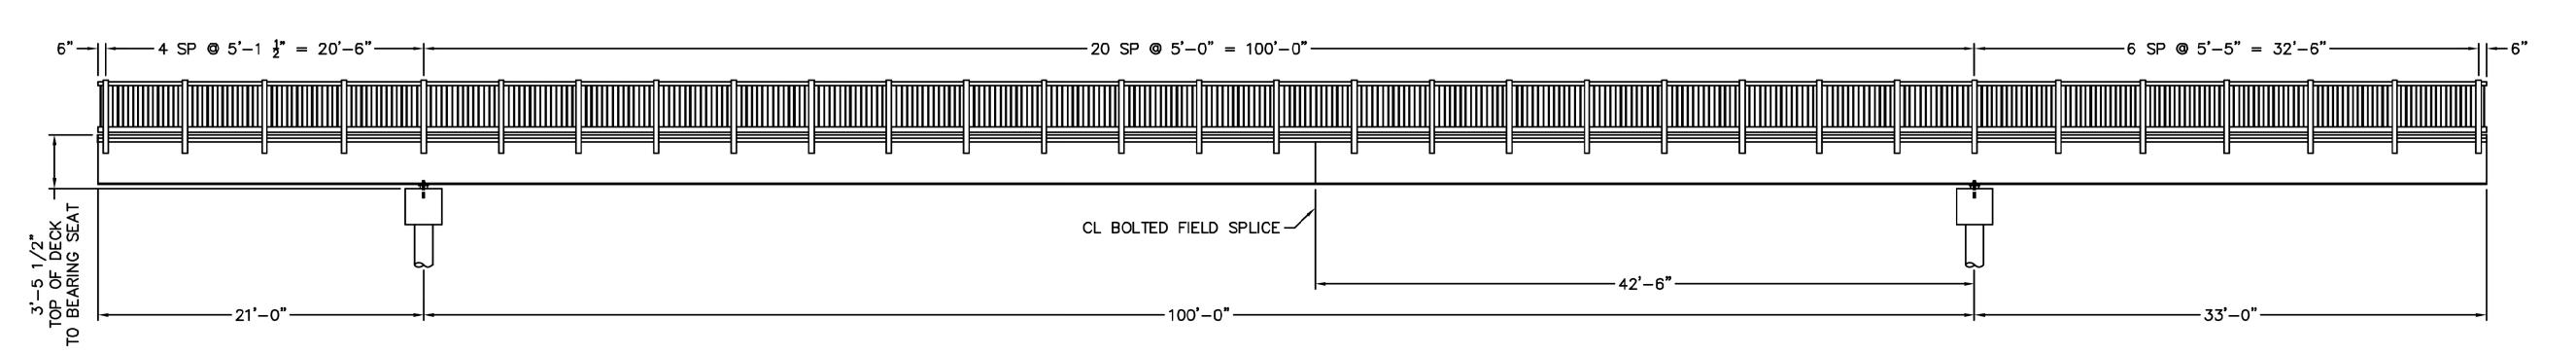

3 PEDESTRIAN BRIDGE - ELEVATION

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 DATE
 DESCRIPTION

 9/10/2021
 30% DESIGN DEVELOPMENT

 11/5/2021
 60% DESIGN DEVELOPMENT


 3/4/2022
 DRAFT 100% PERMIT SUBMITTAL


 3/11/2022
 ISSUE FOR BID

HDR Project Number: 10279441

SHEET NAME
SITE DETAILS PEDESTRIAN
BRIDGE

scale AS NOTED

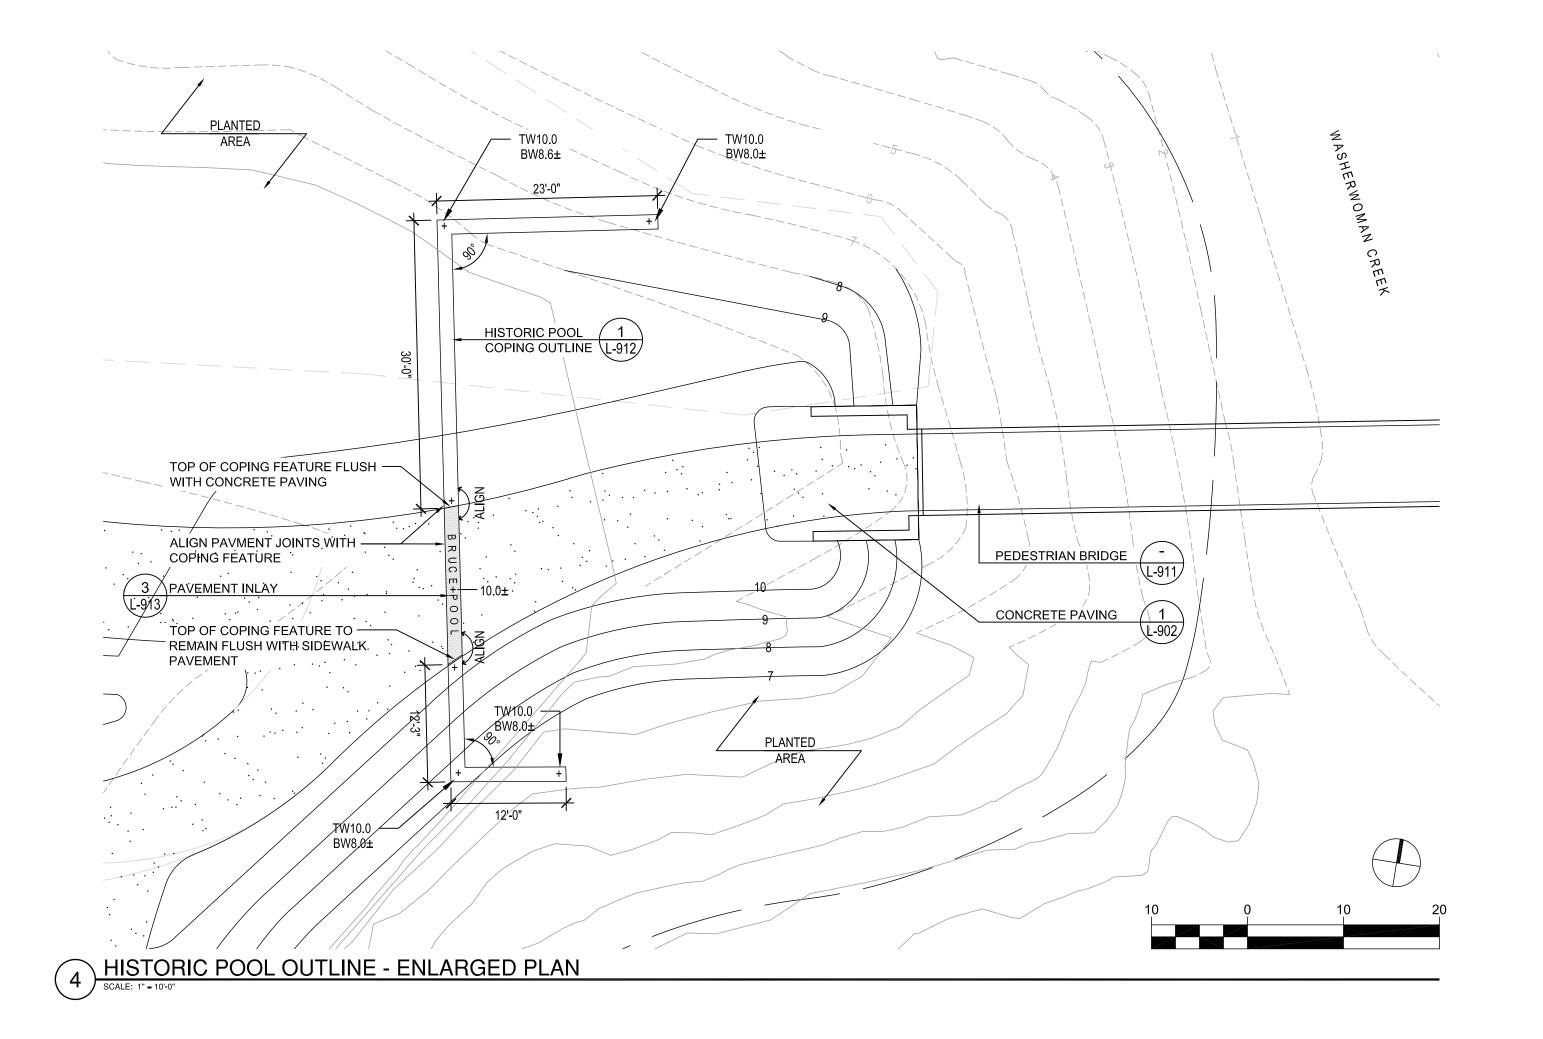


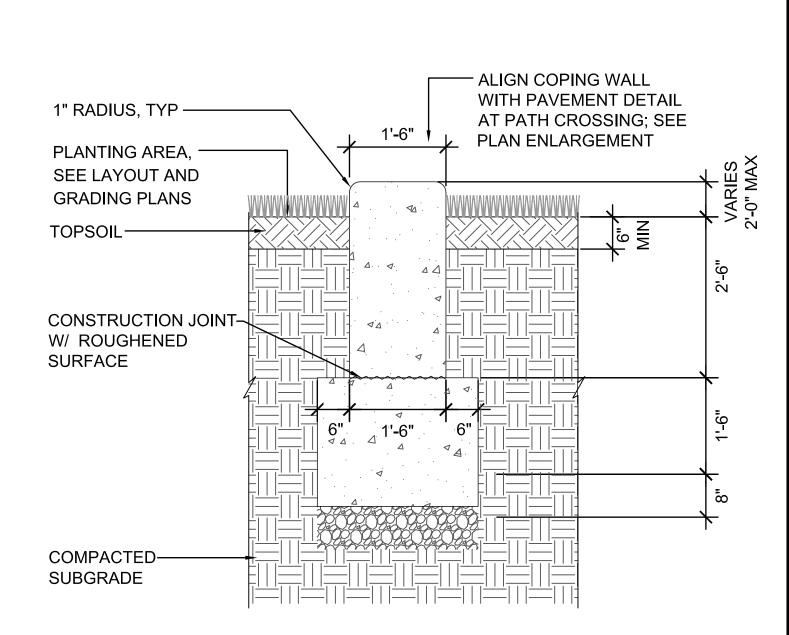


NOTES:

- 4500 PSI CONCRETE
 LIGHT BRUSH FINISH
- 3. SEE PLAN ENLARGEMENT FOR TOP OF WALL ELEVATIONS

1 HISTORIC POOL COPING DETAIL AT PLANTING SCALE: NTS

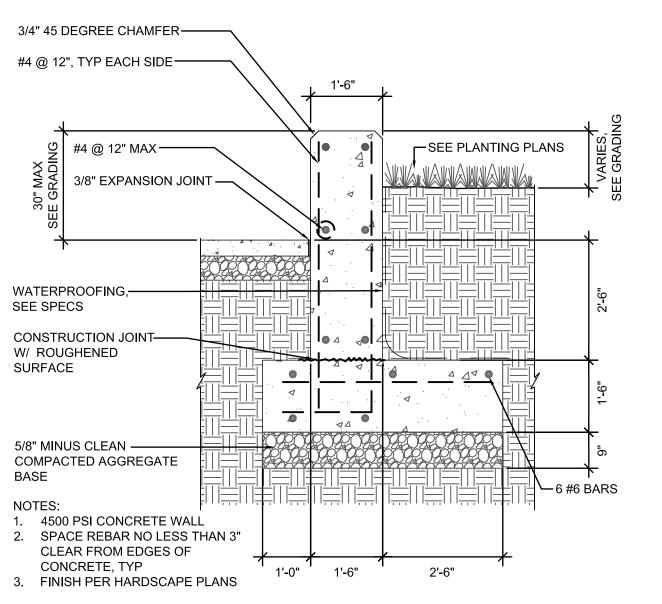

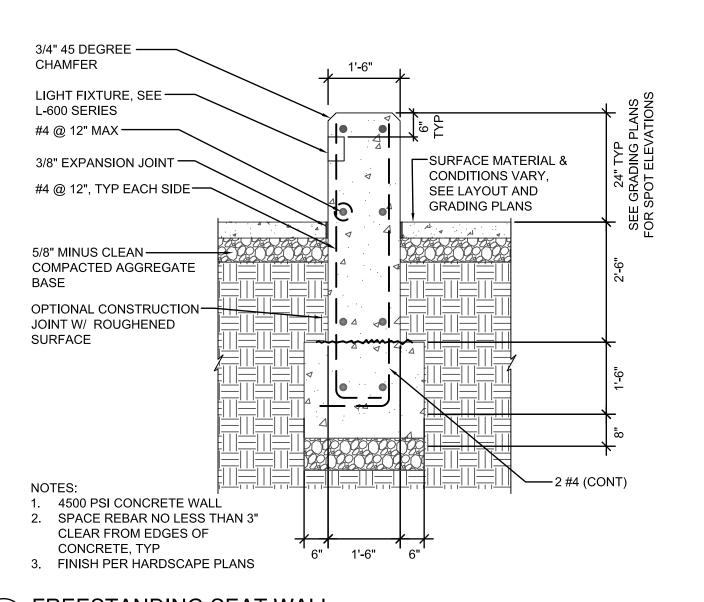

PREESTANDING SEAT WALL

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HDR Project Number: 10279441

Sheet Name
SITE DETAILS PHASE 1

Scale AS NOTED


L-912

5 LIGHT FIXTURE LAYOUT AT SEATWALLS
SCALE: 1:5


– LIGHT FIXTURE, TYP; SEE L-600 SERIES

SEATWALL, TYP

RETAINING SEAT WALL

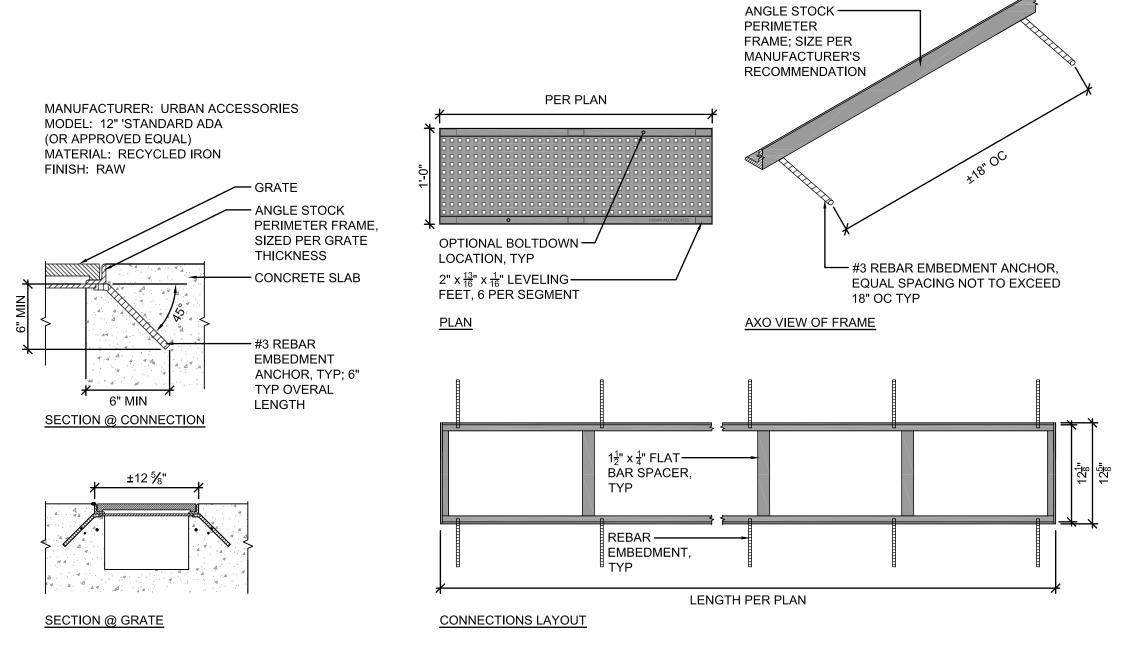


3 TRENCH GRATE
SCALE: 1" = 1'-0"

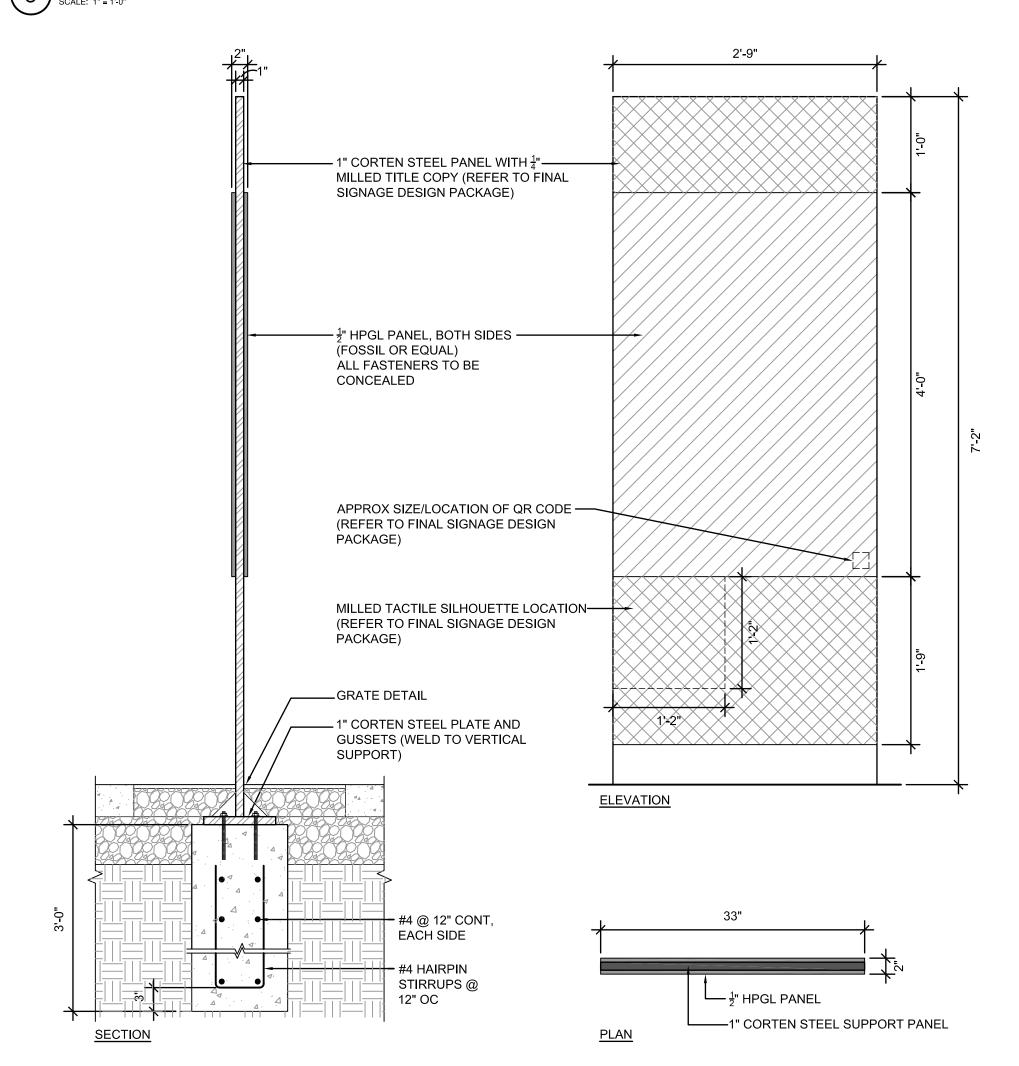

- NOTES:

 1. REFER TO "PENSACOLA DOWNTOWN BRUCE BEACH SIGNAGE FINAL SUBMISSION MEMO" DATED 12/22/21 FOR ALL GRAPHICS AND COPY
- SUBMIT FINAL LAYOUT AND COPY FOR REVIEW AND APPROVAL
 SUBMIT SHOP DRAWINGS AND MATERIAL SAMPLES FOR REVIEW AND APPROVAL
 STAKE LOCATIONS FOR REVIEW AND APPROVAL; SUBJECT TO FIELD ADJUSTMENTS




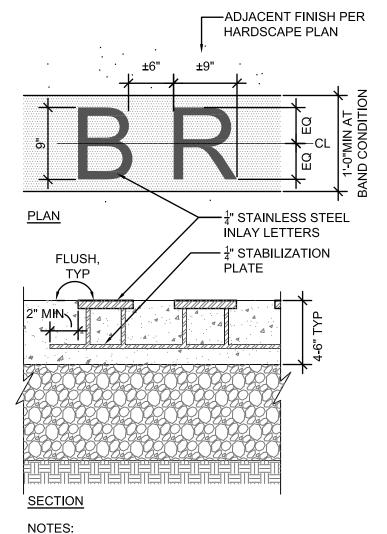

- NOTES:

 1. SEE LAYOUT AND MATERIALS PLAN FOR LOCATION, GENERAL LAYOUT AND CONTEXT MATERIALS/FINISHES
- 2. 'MOON BOLD' FONT PER HISTORIC SIGNAGE DESIGN, OR
- APPROVED ALTERNATE 3. CONFIRM FINAL COPY WITH OWNER
- 4. SUBMIT SHOP DRAWINGS FOR REVIEW AND APPROVAL 5. MOCK UP AT FULL SCALE AND STAKE IN FIELD FOR REVIEW AND APPROVAL PRIOR TO POURING: SUBJECT TO FIELD
- ADJUSTMENT 6. PROTECT STAINLESS STEEL DURING FINISHING OF ADJACENT HARDSCAPE AND OTHER CONSTRUCTION ACTIVITY

Y PAVING INLAY

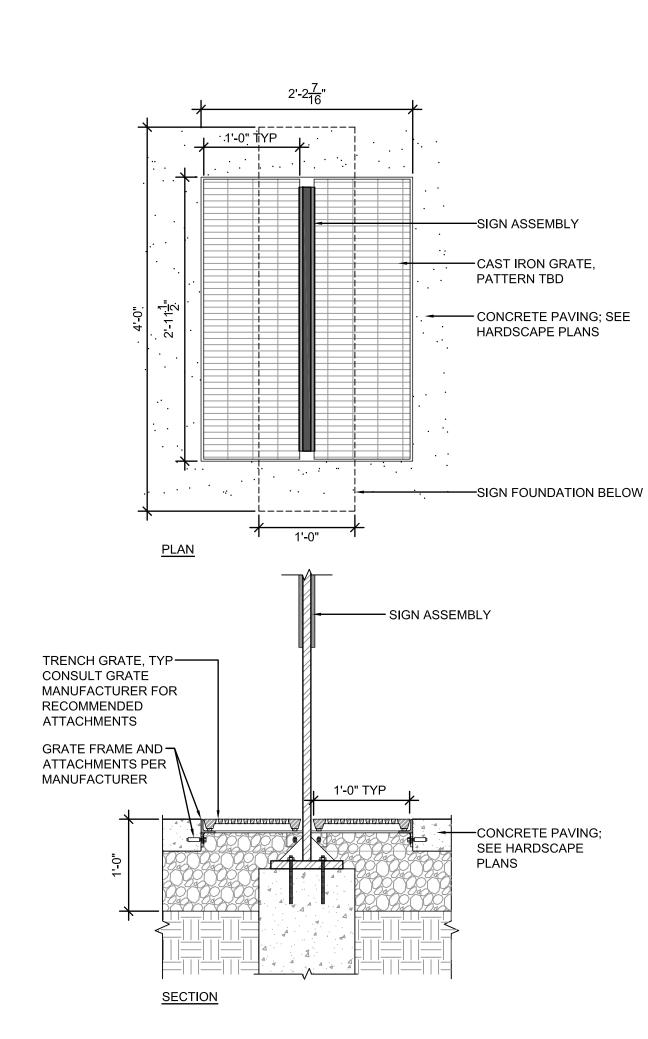

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FLORIDA'S FIRST & FUTURE

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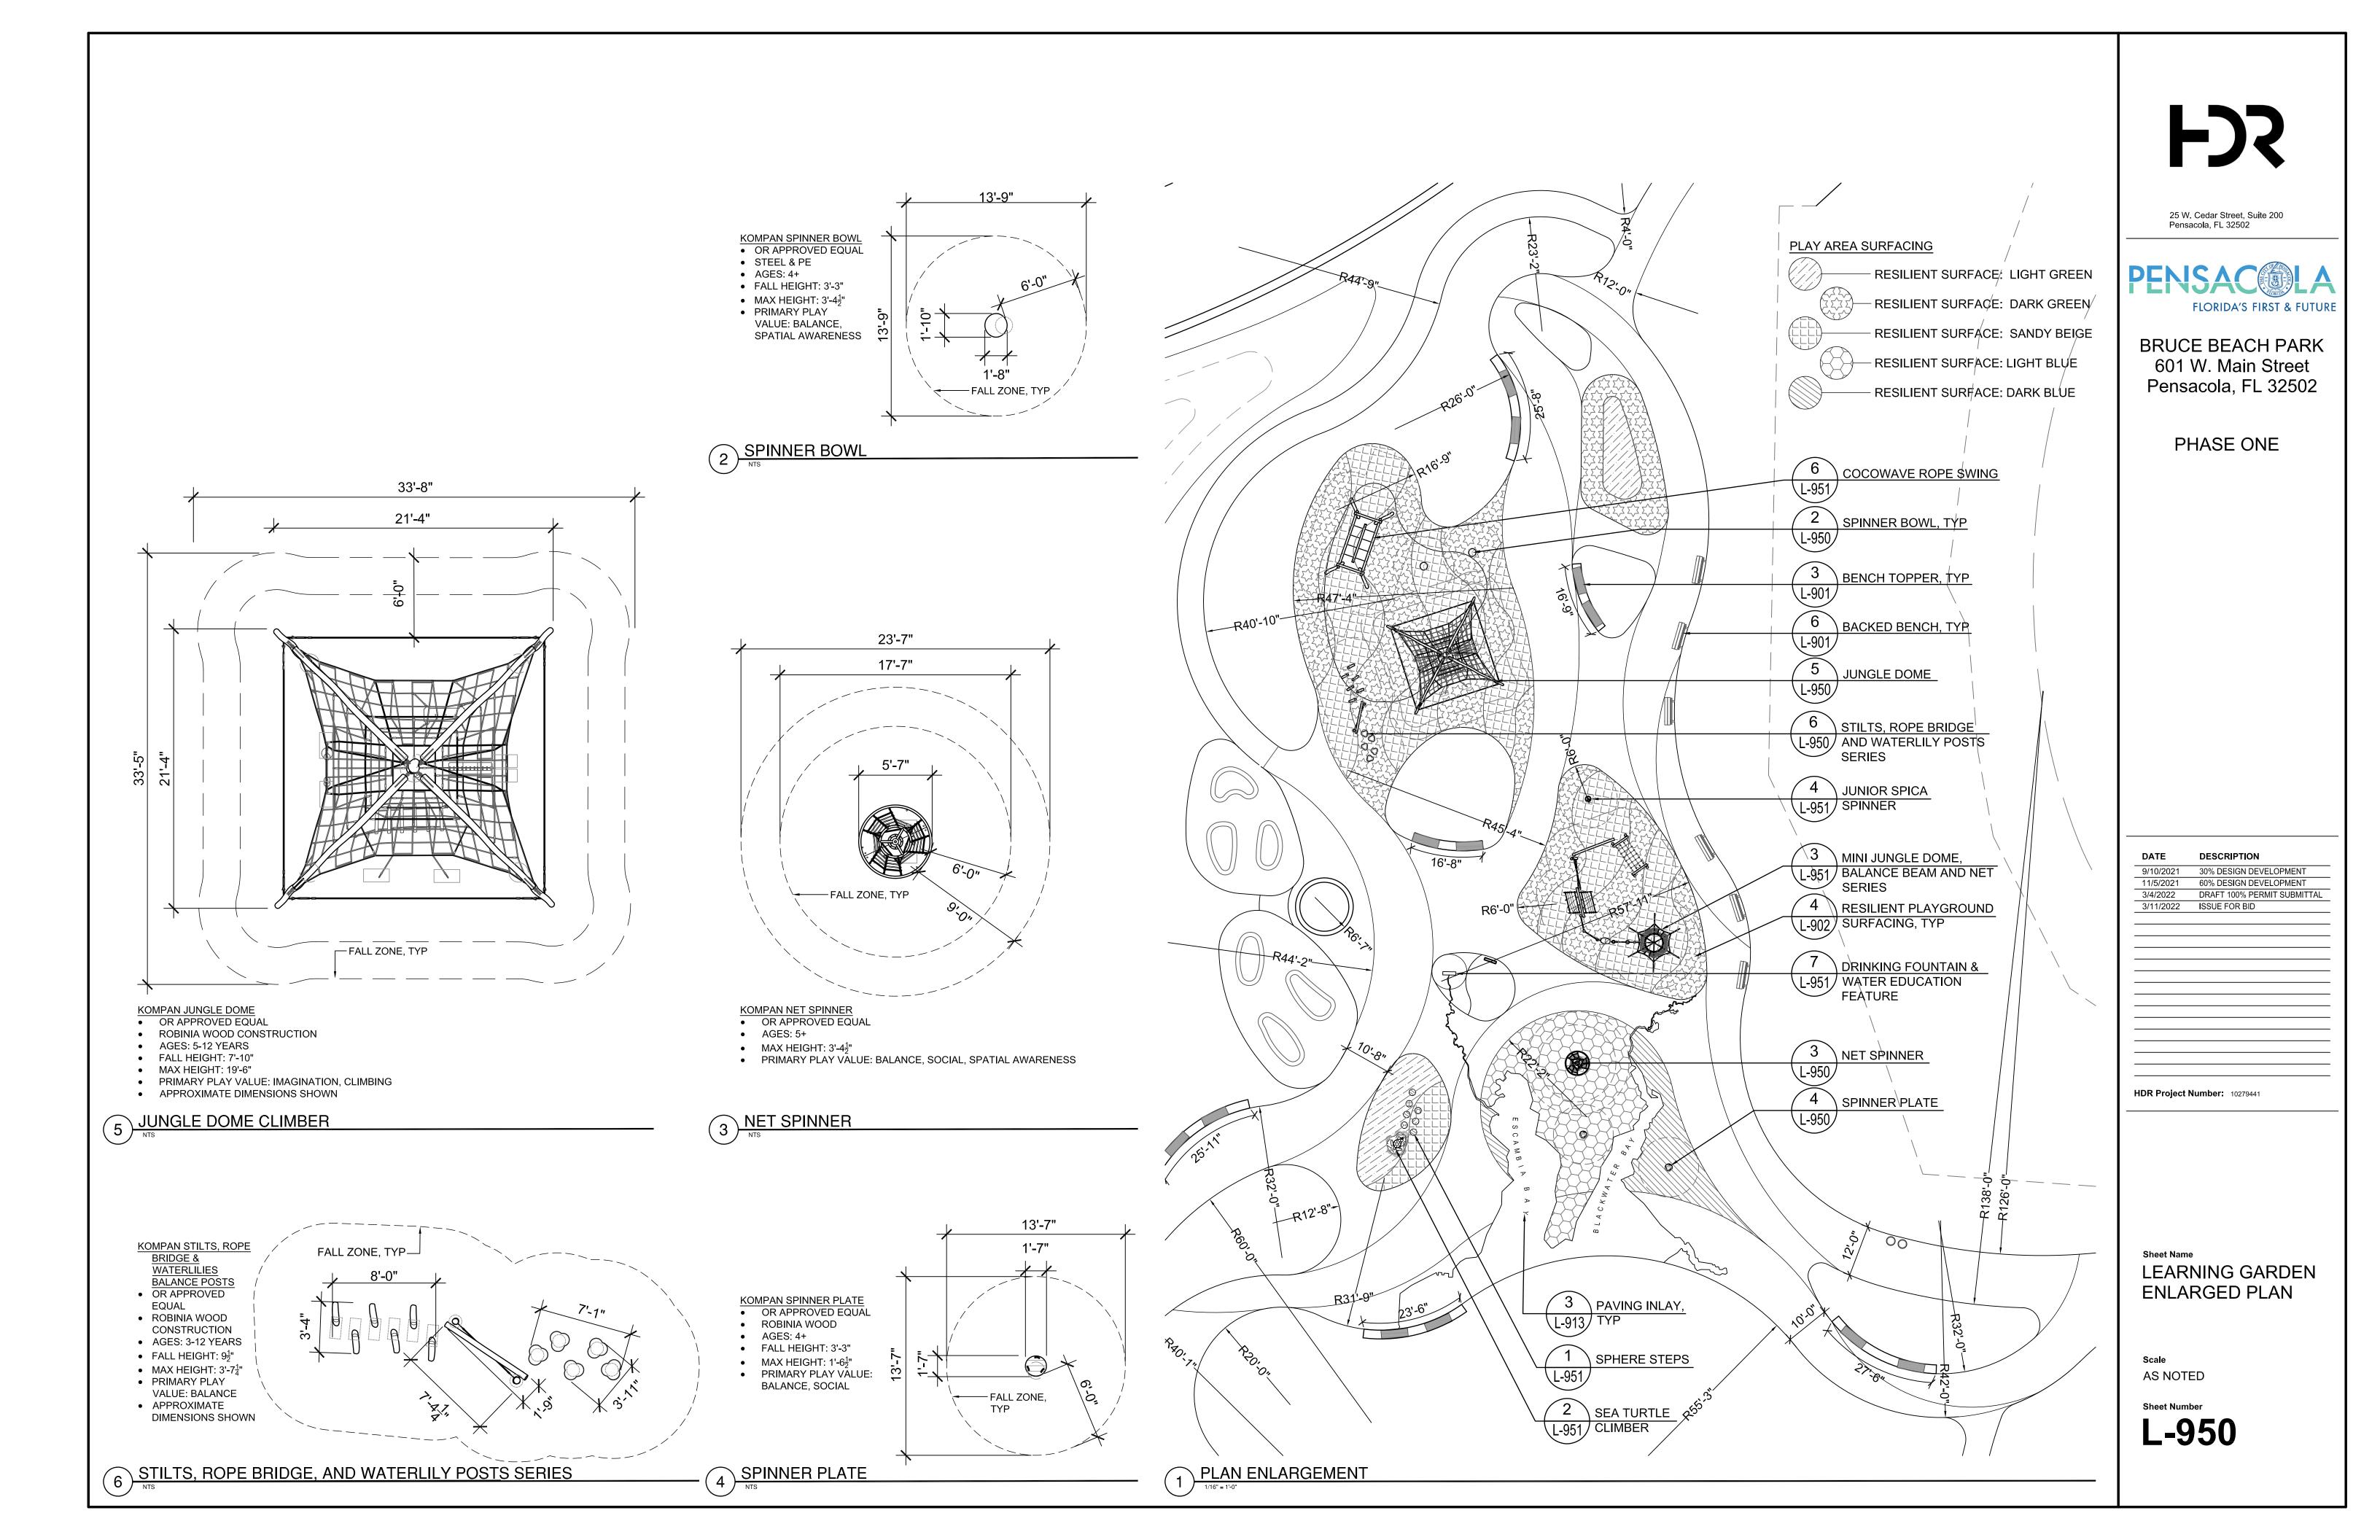
HDR Project Number: 10279441


Sheet Name SITE DETAILS -SIGNAGE

AS NOTED

Sheet Number


2 GRATE DETAIL AT SIGNAGE
SCALE: 1" = 1'-0"



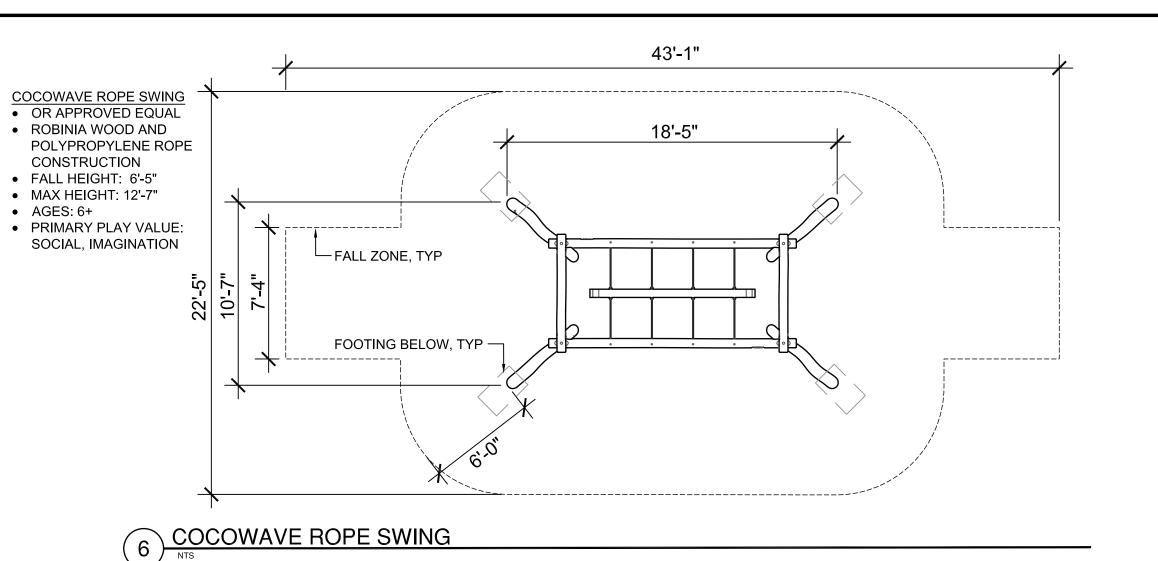


KOMPAN SPICA SPINNEROR APPROVED EQUAL ROBINIA WOOD CONSTRUCTION AGES: 2+ • FALL HEIGHT: 3'-3\frac{3}{8}" MAX HEIGHT: 3'-4½"
PRIMARY PLAY VALUE: BALANCE APPROXIMATE DIMENSIONS SHOWN FOOTING BELOW-FALL ZONE, TYP-

JUNIOR SPICA SPINNER

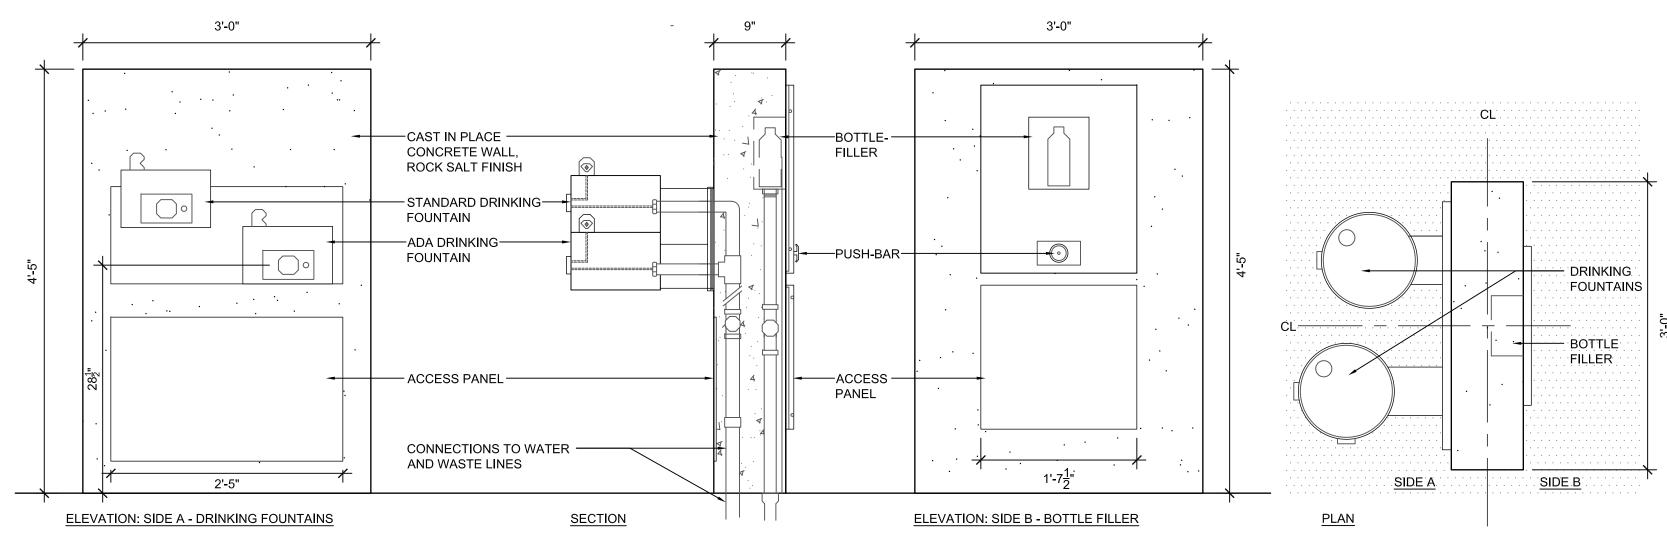

DRINKING FOUNTAIN / WATER FEATURE

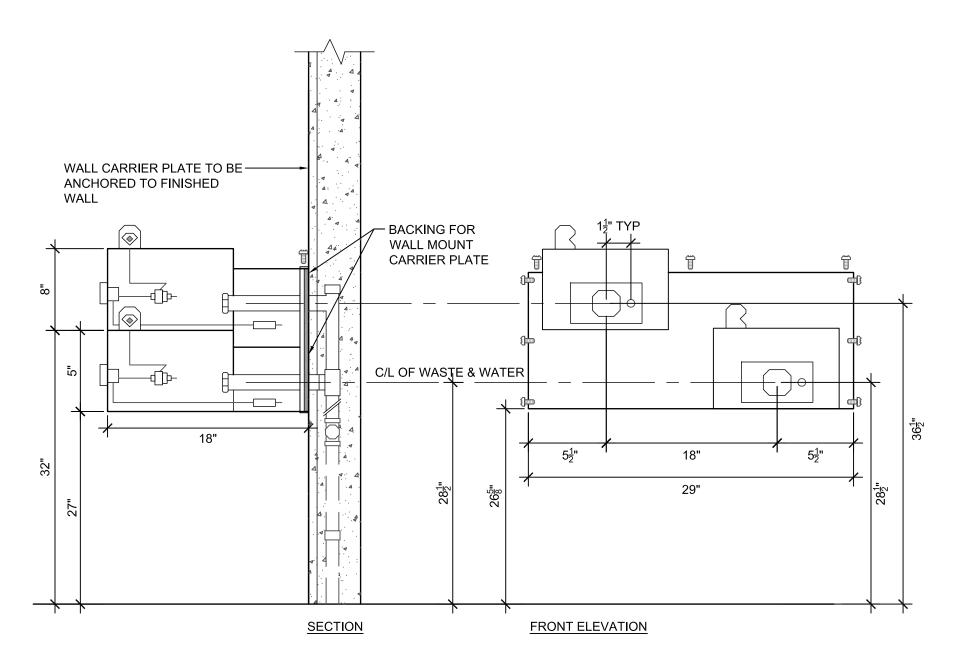


1. INSTALLATION PER MANUFACTURER'S SPECIFICATION - CONSULT REGARDING TWO-SIDED FIXTURE INSTALLATION AND PROVIDE SHOP DRAWINGS FOR REVIEW & APPROVAL

2. COORDINATE INSTALLATION WITH BOTTLE FILLER AND SHARE LINES AS FEASIBLE; SUBMIT SHOP DRAWINGS

3. MDF MODEL 485 EZ WM OR APPROVED EQUAL; 'CHROME' POWDERCOAT

DRINKING FOUNTAIN PANEL

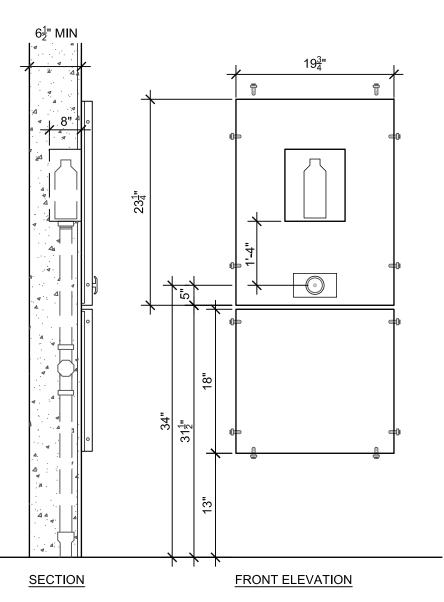


1. INSTALLATION PER MANUFACTURER'S SPECIFICATION - CONSULT REGARDING TWO-SIDED FIXTURE INSTALLATION AND PROVIDE


SHOP DRAWINGS FOR REVIEW & APPROVAL 2. COORDINATE INSTALLATION WITH DUAL DRINKING FOUNTAIN FIXTURE AND SHARE LINES AS FEASIBLE; SUBMIT SHOP DRAWINGS

3. MDF MODEL 10175FMSS OR APPROVED EQUAL; 'CHROME'

BOTTLE FILLER PANEL

POWDERCOAT

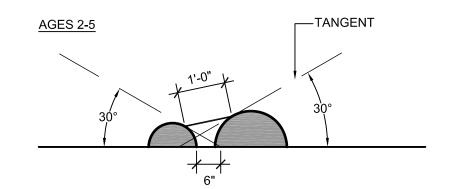

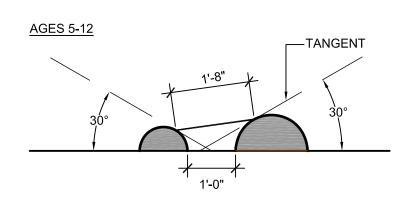

POURED-IN-PLACE RESILIENT SURFACING HALF-SPHERES


• AGES: 2+

- SEE PLAN FOR COLOR AND LOCATION
- PRIMARY PLAY VALUE: BALANCE, SOCIAL, SPATIAL AWARENESS

SPHERE STEPS

TYP SEA TURTLE -CREATURES BY UPC PARKS, OR APPROVED EQUAL COLOR AND SCALE POTENTIALLY CUSTOMIZED

- HIGHEST DESIGNATED PLAY SURFACE APPROX 2'-0" ABOVE GRADE
- USE ZONE APPROX 17'-0" FROM CENTER OF FEATURE
- AGES 2-12; ESTIMATED USERS: 4
- SEE PLAN ENLARGEMENT FOR SURROUNDING HARDSCAPE MATERIAL AND COLOR

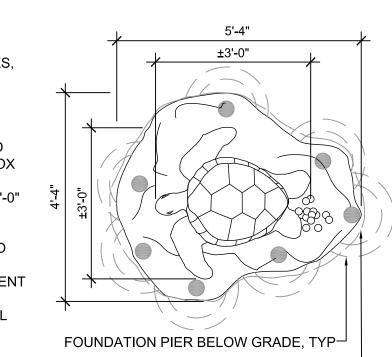


EDGE OF INTEGRAL FOOTING

BELOW GRADE, TYP

SEA TURTLE CLIMBER

3/16" = 1'-0"

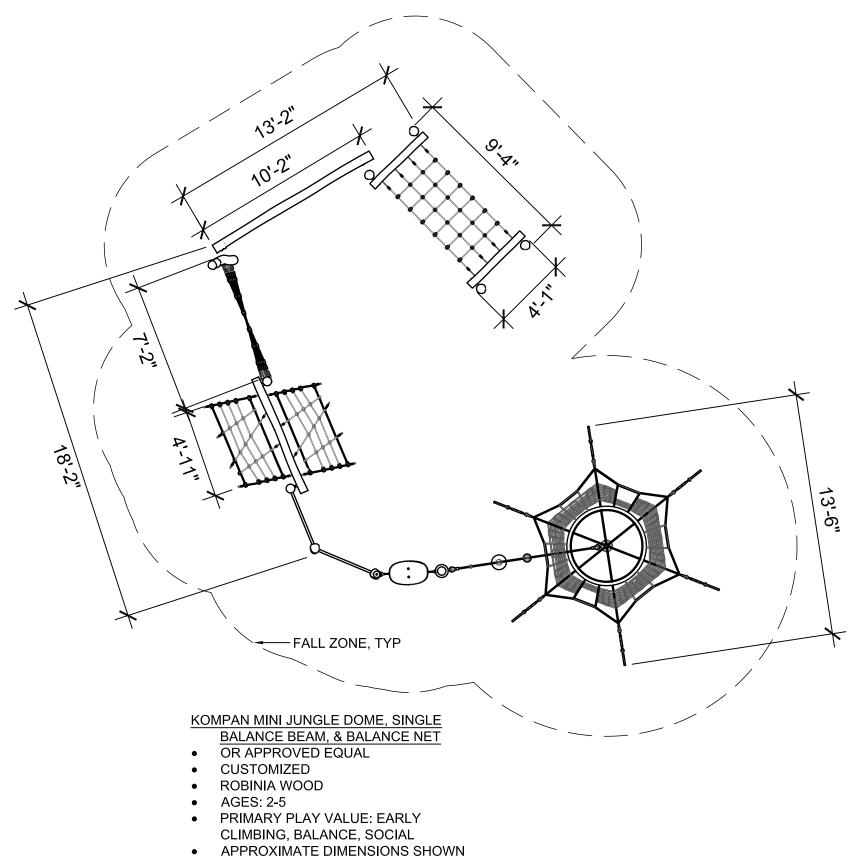

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PHASE ONE

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		-


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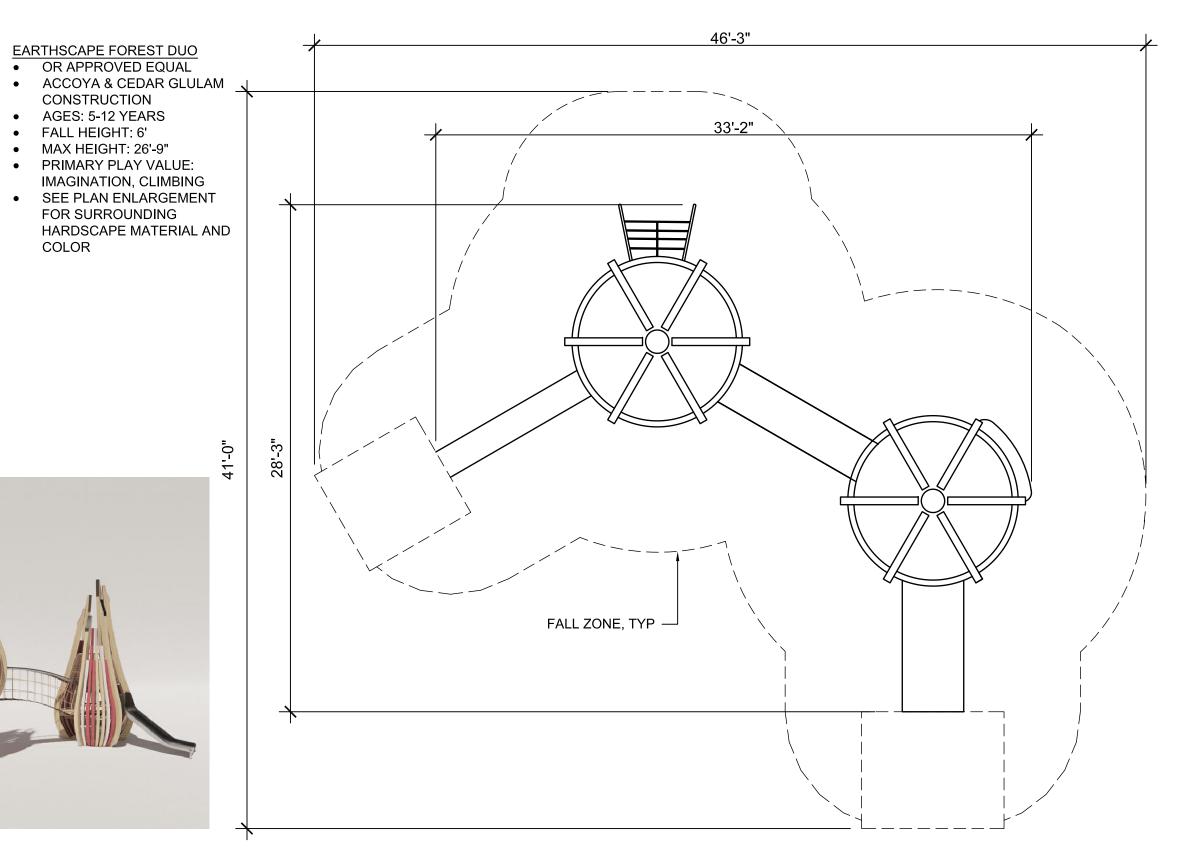
Sheet Name LEARNING GARDEN **DETAILS**


AS NOTED

Sheet Number

L-951 MINI JUNGLE DOME, BALANCE BEAM AND BALANCE NET SERIES



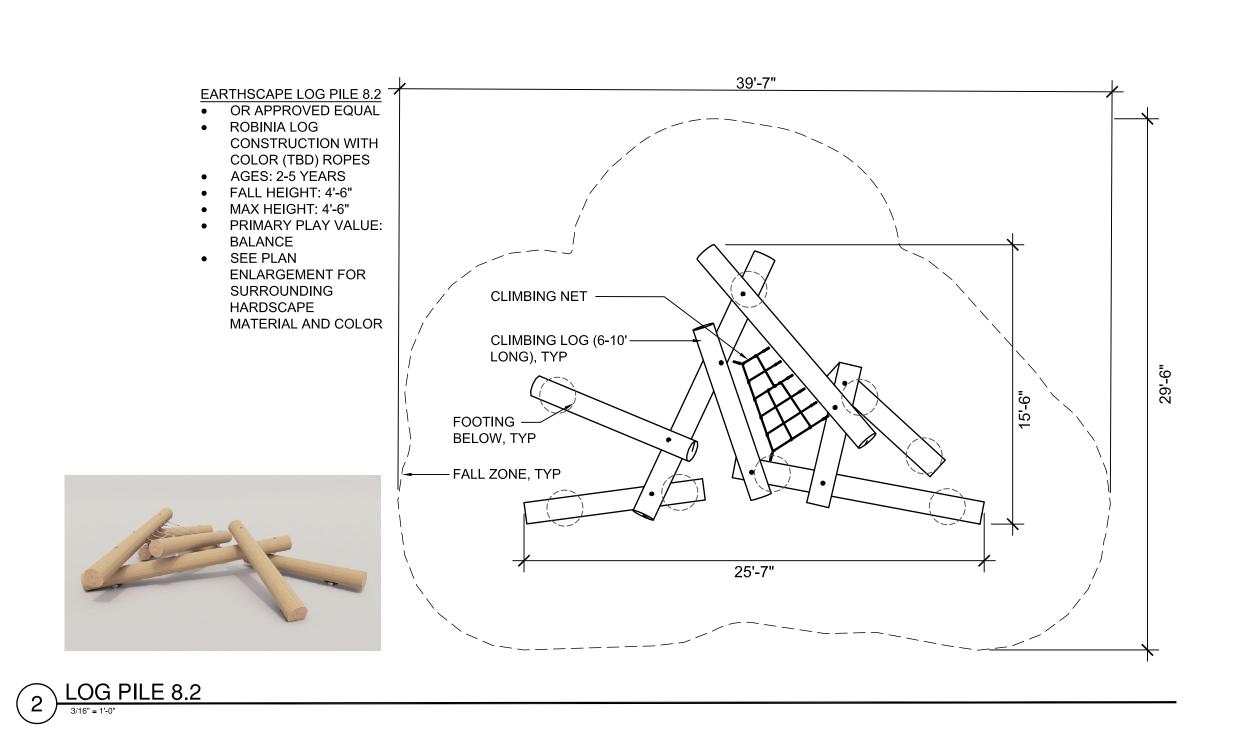

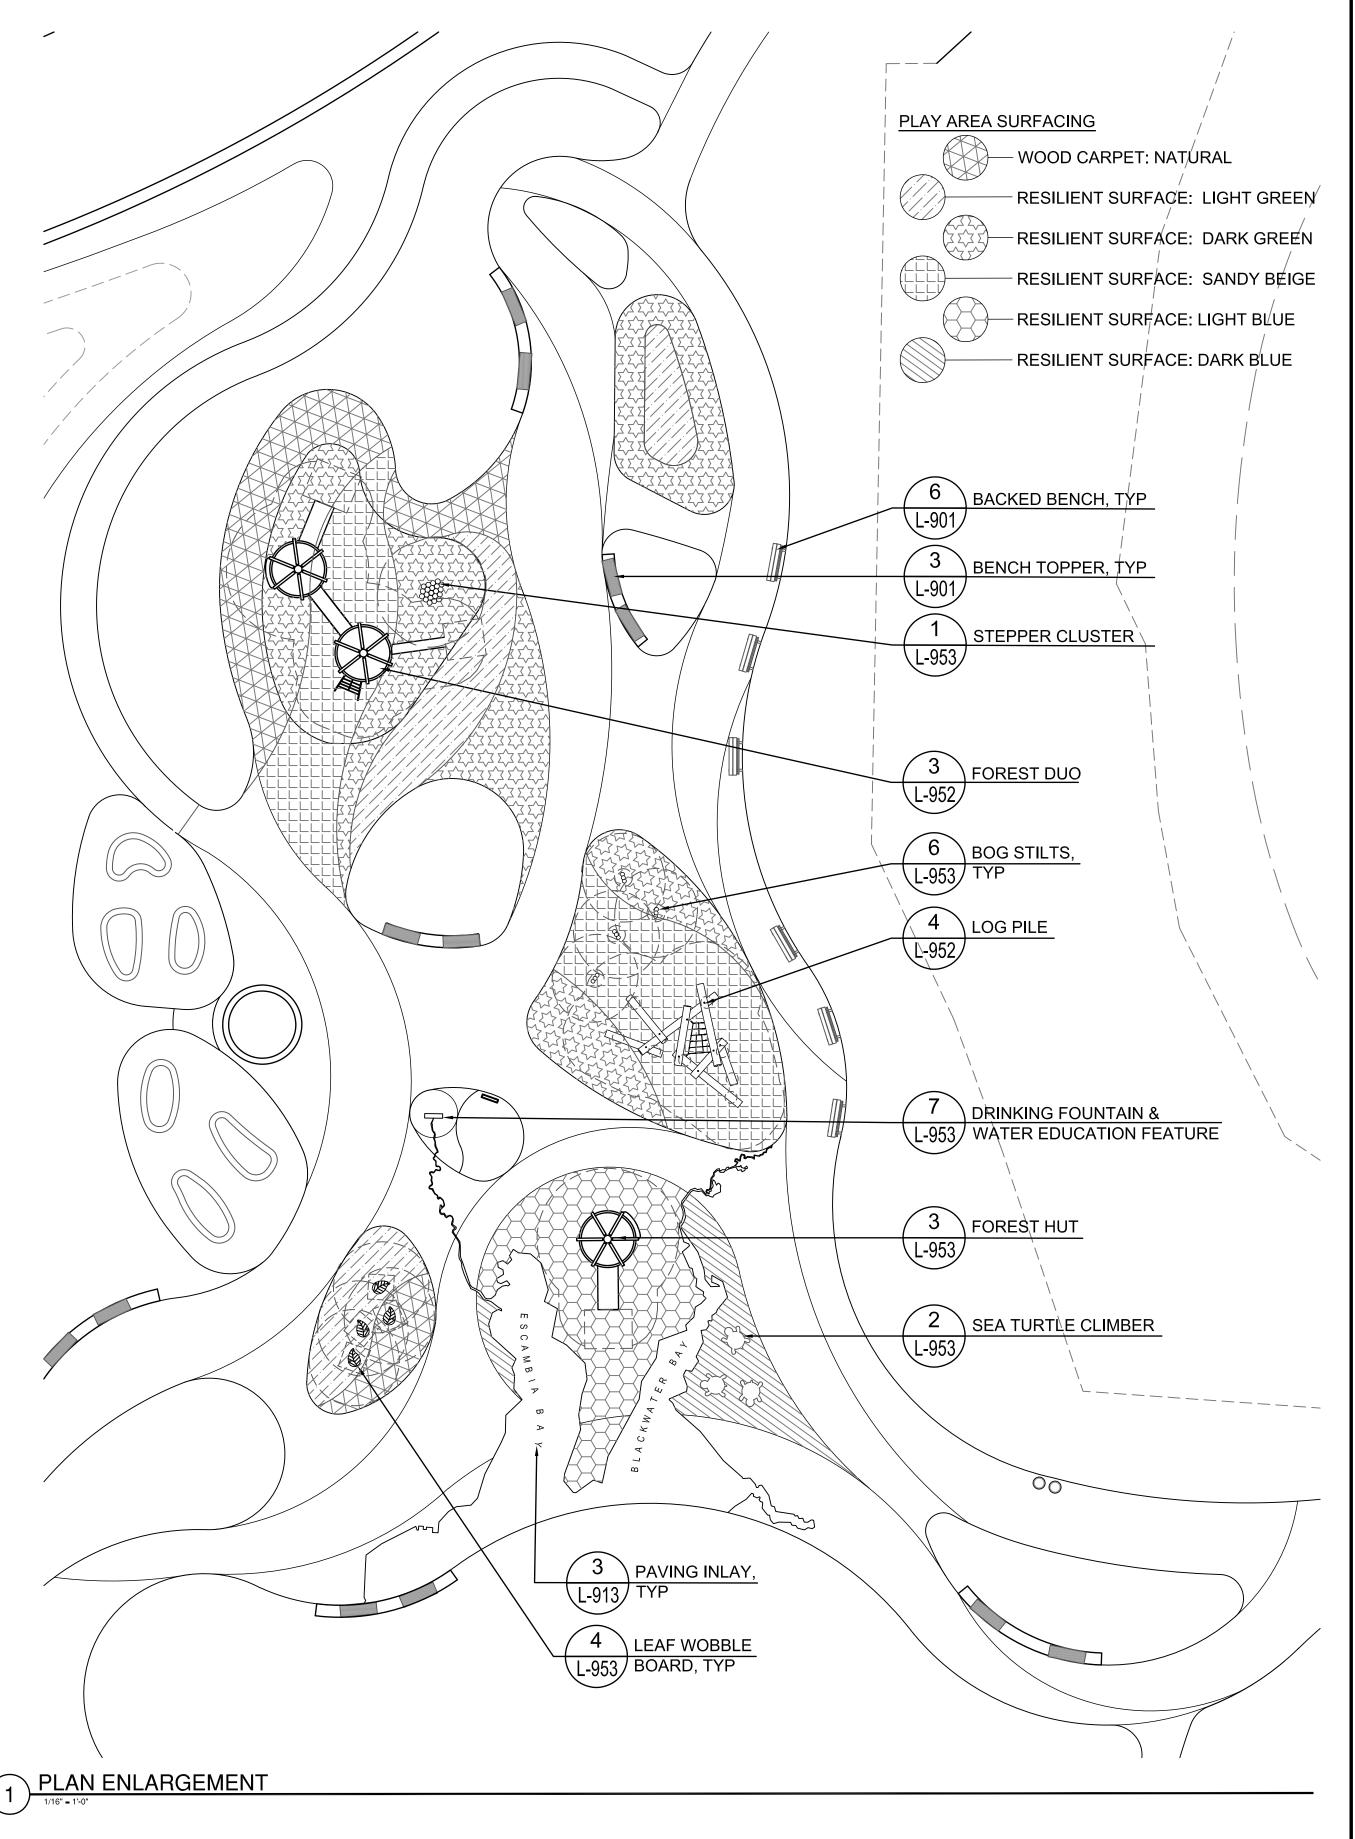

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PHASE ONE

DESCRIPTION 30% DESIGN DEVELOPMENT
 3/10/2021
 30% DESIGN DEVELORMENT

 11/5/2021
 60% DESIGN DEVELORMENT

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LEARNING GARDEN ENLARGED PLAN -ALTERNATE


AS NOTED

L-952

(3) FOREST DUO TOWER


CONSTRUCTION


FALL HEIGHT: 6'

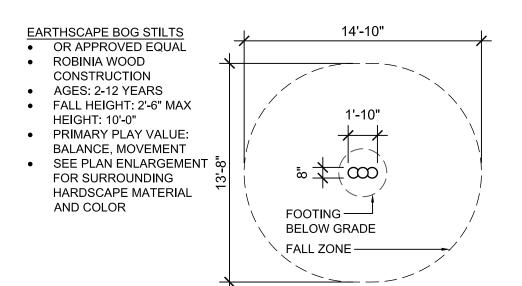

EARTHSCAPE WOBBLE BOARD - LEAF

- OR APPROVED EQUAL PLYWOOD & ACCOYA WOOD
- CONSTRUCTION FINISH/COLOR TBD
- AGES: 5-12 YEARS • FALL HEIGHT: 1'-3"
- MAX HEIGHT: 1'-3"

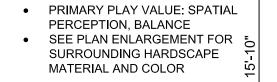

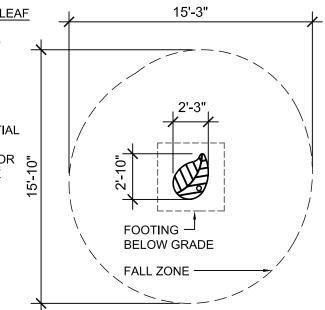

STEPPER CLUSTER 1

TYP SEA TURTLE -

OR APPROVED EQUAL

 COLOR AND SCALE POTENTIALLY

CUSTOMIZED

FEATURE

USERS: 4

AND COLOR

CREATURES BY UPC PARKS,

HIGHEST DESIGNATED

2'-0" ABOVE GRADE
• USE ZONE APPROX 17'-0" FROM CENTER OF

AGES 2-12; ESTIMATED

 SEE PLAN ENLARGEMENT FOR SURROUNDING HARDSCAPE MATERIAL

SEA TURTLE CLIMBER

PLAY SURFACE APPROX

STEPPING, JUMPING

MATERIAL AND COLOR

LEAF WOBBLE BOARD

 AGES: 5-2 YEARS • FALL HEIGHT: 2'-0" MAX HEIGHT: 7'-0" PRIMARY PLAY VALUE:

EARTHSCAPE STEPPER CLUSTER 1

OR APPROVED EQUAL WHITE OAK CONSTRUCTION SEE PLAN ENLARGEMENT FOR SURROUNDING HARDSCAPE

5'-4"

FOUNDATION PIER BELOW GRADE, TYP-

EDGE OF INTEGRAL FOOTING -

BELOW GRADE, TYP

FLORIDA'S FIRST & FUTURE **BRUCE BEACH PARK** 601 W. Main Street


PHASE ONE

DESCRIPTION

9/10/2021 30% DESIGN DEVELOPMENT 11/5/2021 60% DESIGN DEVELOPMENT


Pensacola, FL 32502

25 W. Cedar Street, Suite 200 Pensacola, FL 32502

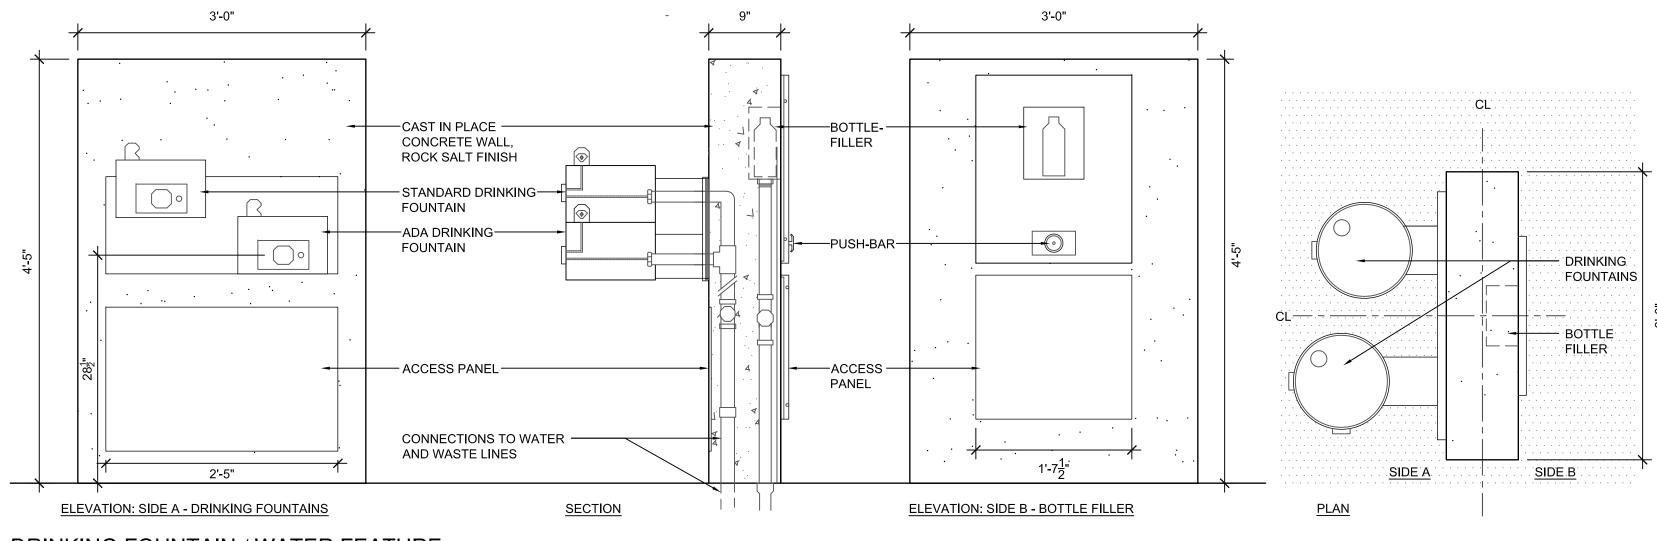

BOG STILTS

DRINKING FOUNTAIN / WATER FEATURE

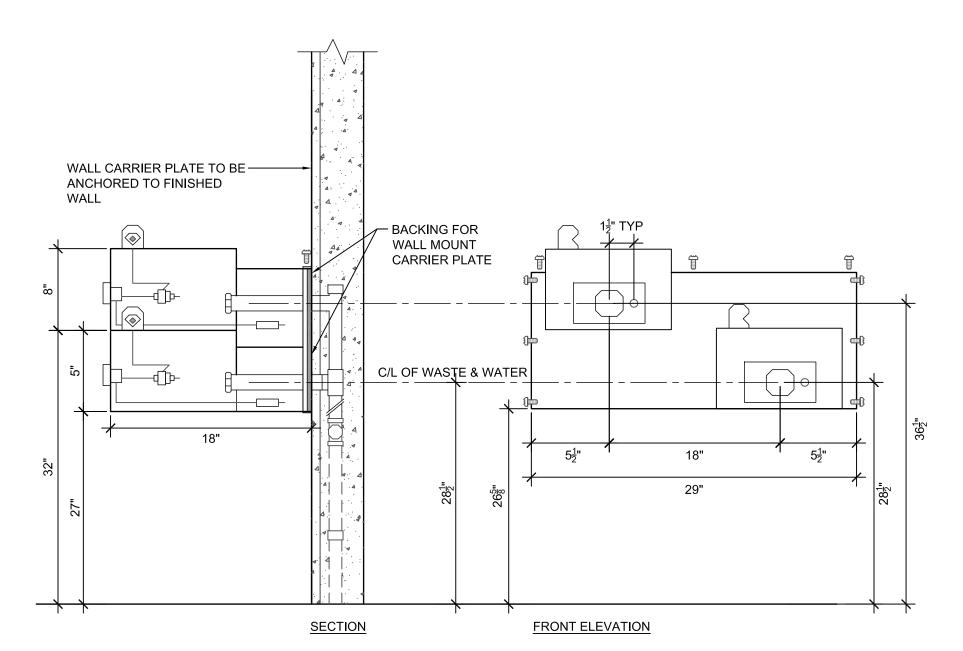

1. INSTALLATION PER MANUFACTURER'S SPECIFICATION - CONSULT REGARDING TWO-SIDED FIXTURE INSTALLATION AND PROVIDE SHOP DRAWINGS FOR REVIEW & APPROVAL

2. COORDINATE INSTALLATION WITH BOTTLE FILLER AND SHARE LINES AS FEASIBLE; SUBMIT SHOP DRAWINGS


3. MDF MODEL 485 EZ WM OR APPROVED EQUAL; 'CHROME' POWDERCOAT

<u> DRINKING FOUNTAIN PANEL</u>

<u>SECTION</u> FRONT ELEVATION

- 1. INSTALLATION PER MANUFACTURER'S SPECIFICATION CONSULT REGARDING TWO-SIDED FIXTURE INSTALLATION AND PROVIDE SHOP DRAWINGS FOR REVIEW & APPROVAL
- 2. COORDINATE INSTALLATION WITH DUAL DRINKING FOUNTAIN FIXTURE AND SHARE LINES AS FEASIBLE; SUBMIT SHOP DRAWINGS 3. MDF MODEL 10175FMSS OR APPROVED EQUAL; 'CHROME'

EARTHSCAPE FOREST HUT OR APPROVED EQUAL ACCOYA & CEDAR GLULAM CONSTRUCTION • AGES: 2-5 YEARS • FALL HEIGHT: 3'-11" MAX HEIGHT: 20'-11" PRIMARY PLAY VALUE: IMAGINATION, CLIMBING • SEE PLAN ENLARGEMENT FOR SURROUNDING HARDSCAPE MATERIAL AND COLOR

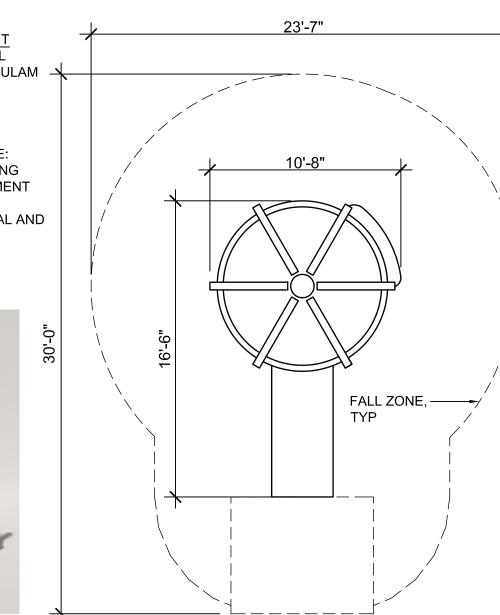

3/4/2022 DRAFT 100% PERMIT SUBMITTAL 3/11/2022 ISSUE FOR BID HDR Project Number: 10279441

> LEARNING GARDEN **DETAILS - ALTERNATE**

AS NOTED

Sheet Number L-953

BOTTLE FILLER PANEL

POWDERCOAT

FOREST HUT

STRUCTURAL NOTES:

GENERAL NOTES:

THE NOTES ON THIS SHEET AND THE STANDARD STRUCTURAL DETAILS ARE GENERAL AND APPLY TO THE ENTIRE PROJECT WHETHER SPECIFICALLY CALLED OUT OR NOT, EXCEPT WHERE THERE ARE SPECIFIC INDICATIONS TO THE CONTRARY ON STRUCTURAL SHEETS. IF THERE ARE QUESTIONS, THEY SHALL BE SUBMITTED TO THE STRUCTURAL ENGINEER AND ANSWERED IN WRITING PRIOR TO CONSTRUCTION.

G2. APPLICABLE SPECIFICATIONS AND CODES

FLORIDA BUILDING CODE 2020, 7TH EDITION WITH PENSACOLA CITY AMENDMENTS

2. BUILDING CODE REQUIREMENTS FOR REINFORCED CONCRETE (ACI 318-14)

3. AMERICAN INSTITUTE OF STEEL CONSTRUCTION (AISC) MANUAL OF STEEL CONSTRUCTION, 16TH EDITION. 4. AMERICAN WELDING SOCIETY (AWS) D1.1, D1.3, D1.4

5. MINIMUM DESIGN LOADS FOR BUILDINGS AND OTHER STRUCTURES (ASCE 7-16)

6. ASTM MATERIAL STANDARDS AS NOTED

G3. <u>DESIGN CRITERIA</u>

A. DEAD LOAD:

APPLIES TO ALL STRUCTURES

A.1. ACTUAL TRIBUTARY STRUCTURE WEIGHT

A.2. SUPERIMPOSED DEAD LOAD:

A.2.1. ALLOWANCE FOR SHADE PANELS, LIGHTING, PLUMBING, AND INSETS: 10 PSF

LIVE LOAD:

B.1. ROOFS (NON MECHANICAL) 20 PSF (NOT REDUCIBLE) B.2. EXTERIOR WALKWAYS 100 PSF

AND MINIMUM CONCENTRATED LOAD OF 200 LBS.

C. WIND:

1. ULTIMATE WIND VELOCITY = 140 MPH

2. NOMINCAL WIND VELOCITY = 108 MPH 3. IMPORTANCE FACTOR

4. ENCLOSURE CLASSIFICATION = OPEN AS PER ASCE 7-16 5. EXPOSURE CATEGORY = C

6. DIRECTIONALITY FACTOR $K_D = 0.85$ 7. TOPOGRAPHY FACTOR $K_{ZT} = 1.0$

8. GUST FACTOR G = 0.85 DESIGN WIND PRESSURES FOR COMPONENTS AND CLADDING = FROM ASCE 7-16

D. SEISMIC:

1. ALL ABOVE AND BELOW GRADE STRUCTURES:

2. SEISMIC IMPORTANCE FACTOR I

= 1.0 3. MAPPED SPECTRAL RESPONSE ACCELERATIONS SS = 0.08G AND S1 = 0.054G

4. ASSUMED SITE CLASS:

5. SPECTRAL RESPONSE COEFFICIENTS SDS = 0.085G AND SD1 = 0.087G

6. SEISMIC DESIGN CATEGORY:

7. BASIC SEISMIC FORCE RESISTING SYSTEM(S): STEEL SYSTEM NOT DETAIL FOR SEISMIC

E. SNOW LOAD

 GROUND SNOW LOAD = 0 PSF 2. FLAT ROOF SNOW LOAD = NOT APPLICABLE

G4. A GEOTECHNICAL ENGINEER WILL VERIFY SOIL CONDITIONS AT THIS SITE. FOLLOWING FOUNDATION ASSUMPTIONS ARE MADE:

= D

= B

1. SHALLOW FOUNDATIONS ALLOWABLE NET SOIL BEARING:

1.1. SUPPORTED ON NATURAL SOILS = 2000 PSF 2. A 3'-0" DIAMETER x 12'-0" DEEP DRILLED PIERS UNDER SQUARE CONCRETE PEDESTALS CAN SUPPORT ALL COLUMN LOADS PROVIDED IN DETAIL

SAFETY AND STRUCTURE STABILITY DURING CONSTRUCTION ARE THE SOLE RESPONSIBILITY OF THE CONTRACTOR. STRUCTURES HAVE BEEN DESIGNED TO RESIST THE DESIGN LIVE LOADS ONLY AS A COMPLETED STRUCTURE.

OPENINGS

OPENINGS FOR PIPES, DUCTS, CONDUITS, ETC. ARE NOT ALL SHOWN ON THE STRUCTURAL DRAWINGS. COORDINATE AND PROVIDE OPENINGS AS REQUIRED TO ACCOMMODATE ALL WORK SHOWN OR SPECIFIED IN THE CONTRACT DOCUMENTS AND OTHERWISE REQUIRED FOR THE FURNISHING OF A FUNCTIONALLY COMPLETE PROJECT. REINFORCE AROUND OPENINGS UNLESS OTHERWISE SHOWN.

G7. SPECIAL INSPECTIONS SPECIAL INSPECTIONS ARE REQUIRED IN ACCORDANCE WITH CHAPTER 1 AND CHAPTER 17 OF THE FBC 2020. PAYMENT FOR THESE INSPECTIONS IS NOT THE RESPONSIBILITY OF THE CONTRACTOR. THE CONTRACTOR SHALL PROVIDE FOR FULL ACCESS TO THE WORK BY THE SPECIAL INSPECTOR AND SHALL PROVIDE FOR THESE INSPECTIONS IN HIS CONSTRUCTION SCHEDULE IN ACCORDANCE WITH THE SPECIFICATIONS.

G8. STANDARD DETAILS

THE STANDARD DETAILS DEPICT TYPICAL DETAILING TO BE USED ON THIS PROJECT. IF CONDITIONS ARE NOT EXPLICITLY SHOWN ON THE DRAWINGS THEY SHALL BE MADE SIMILAR TO THE STANDARD DETAILS. OBTAIN APPROVAL OF ENGINEER IN WRITING FOR SIMILAR CONDITIONS PRIOR TO CONSTRUCTION.

G9. THE CONTRACTOR SHALL FIELD VERIFY ALL DIMENSIONS AND ELEVATIONS OF EXISTING CONSTRUCTION AS REQUIRED TO COORDINATE NEW CONSTRUCTION. SUBMIT REQUIRED CHANGES FOR APPROVAL.

CONCRETE NOTES:

C1. MATERIALS OF CONSTRUCTION: 3. CONCRETE DESIGN STRENGTHS:

3.1. ALL CONCRETE:

4,500 PSI

REINFORCING STEEL - ASTM A615 $F_{\rm v}$ = 60 KSI REINFORCING STEEL TO BE WELDED - ASTM A706 $F_Y = 60 \text{ KSI}$

C2. CONCRETE COVER UNLESS OTHERWISE SPECIFIED, PROVIDE CONCRETE COVER FOR REINFORCING AS FOLLOWS:

CONCRETE DEPOSITED AGAINST EARTH: 3" TIE REINFORCING AT COLS & PILASTERS: 1\(\frac{1}{2} \)"

ALL OTHER: SEE DRAWINGS FOR EXEMPTIONS

- C3. SEE SPECIFICATIONS AND ACI 315 FOR REINFORCING DETAILING AND PLACEMENT REQUIREMENTS.
- C4. REFER TO OTHER DISCIPLINE DRAWINGS PRIOR TO CONSTRUCTION FOR EMBEDDED ITEMS AND PENETRATIONS NOT SHOWN ON STRUCTURAL DRAWINGS. AS REQUIRED TO ACCOMMODATE ALL WORK SHOWN OR SPECIFIED IN THE CONTRACT DOCUMENTS AND OTHERWISE REQUIRED FOR THE FURNISHING OF A FUNCTIONALLY COMPLETE PROJECT. REINFORCE AROUND OPENINGS UNLESS OTHERWISE SHOWN.
- C5. PROVIDE 3/4" CHAMFERS AT ALL EXPOSED EDGES AND 1/2" CHAMFERS AT JOINTS AS SHOWN. NOT ALL CHAMFERS MAY BE SHOWN ON DRAWINGS.
- C6. FIELD ADJUST REINFORCING AT OPENINGS AND EMBEDDED ITEMS AS INDICATED.

C7. ANCHOR BOLTS NOT SPECIFIED BY ENGINEER SHALL BE DESIGNED AND CERTIFIED BY A REGISTERED PROFESSIONAL ENGINEER, RETAINED BY THE CONTRACTOR, IN ACCORDANCE WITH APPLICABLE PROJECT AND CODE REQUIREMENTS. SUBMIT AS A SHOP DRAWING FOR REVIEW AND APPROVAL BY THE ENGINEER. COORDINATE LOCATION, SIZE AND EMBEDMENT PRIOR TO CASTING CONCRETE.

C8. ABSOLUTELY NO WELDING OF REINFORCING BARS OR TORCHING TO BEND REINFORCING BARS SHALL BE ALLOWED WITHOUT SPECIFIC APPROVAL FROM THE STRUCTURAL ENGINEER.

C9. ANCHOR BOLTS, DOWELS, REINFORCING STEEL, INSERTS, ETC. SHALL BE SECURELY TIED IN PLACE PRIOR TO POURING CONCRETE. CONCRETE BLOCKS SHALL ONLY BE USED TO SUPPORT REINFORCING OFF GRADE.

C10. ALL CAST IN PLACE AND POST-INSTALLED ANCHORS INDICATED IN THE STRUCTURAL DOCUMENTS SHALL COMPLY WITH APPENDIX D OF ACI 318 AND CHAPTER 19 OF THE FBC. ALL EXPANSION AND ADHESIVE ANCHORS SHALL HAVE THE ICC REPORT SHOWING EQUIVALENT LOAD CAPACITY. SUBMIT AND INSTALL PER THE ICC EVALUATION REPORT

C11. PROVIDE DOWELS OF SAME SIZE AND NUMBER FROM ADJACENT POUR, BOTH VERTICALLY AND HORIZONTALLY, TO MATCH TYPICAL REINFORCING SHOWN. LAPS TO BE IN ACCORDANCE WITH ACI 318.

C12. CORING OF SLABS OR WALLS IS NOT PERMITTED. PROVIDE SLEEVES FOR ALL PENETRATIONS PRIOR TO PLACING CONCRETE

S1. MATERIALS OF CONSTRUCTION:

1. WIDE FLANGE AND TEE SHAPES ASTM A992 $F_{Y} = 50 \text{ KSI}$ 2. ANGLES CHANNELS AND PLATE - ASTM A36 $F_Y = 36 \text{ KSI}$ 3. HSS TUBES AND PIPES - ASTM A500 $F_Y = 46 \text{ KSI}$ 4. PIPES - ASTM A53 GRADE B $F_Y = 35 \text{ KSI}$ 5. BOLTS - ASTM F1852

 $F_Y = 55 \text{ KSI}$ 6. ANCHOR BOLTS - ASTM F1554 GRADE 36 7. HIGH STRENGTH ANCHOR BOLT ASSEMBLY

8. WELDING ELECTRODES - E70XX

S2. DIMENSIONS:

TO CENTERLINES OF COLUMNS AND BEAMS, TOP SURFACES OF BEAMS AND TUBES AND BACKS OF CHANNELS AND ANGLES UNO.

TOP OF STEEL REFERS TO TOP SURFACE OF MEMBER OR FLANGE UNO.

S4. WHEN FILLET WELD SIZE IS NOT INDICATED, PROVIDE MAXIMUM WELD SIZE BASED ON MATERIAL THICKNESS IN ACCORDANCE WITH AISC SPECIFICATIONS.

S5. ALL BOLTED STRUCTURAL CONNECTIONS ARE BEARING TYPE CONNECTIONS UNLESS OTHERWISE SPECIFIED TO BE SLIP-CRITICAL. PROVIDE LOAD INDICATING WASHERS AT SLIP-CRITICAL CONNECTIONS.

S6. HOT DIP GALVANIZE ALL STRUCTURAL STEEL EXPOSED TO WEATHER.

POST INSTALLED ANCHORS

- P1. POST INSTALLED ANCHORS SHALL ONLY BE USED WHERE SPECIFIED ON THE CONTRACT DRAWINGS. THE CONTRACTOR SHALL OBTAIN APPROVAL FROM THE OWNER BEFORE INSTALLING POST INSTALLED ANCHORS FOR MISSING OR MISPLACED CAST-IN-PLACE ANCHORS.
- P2. CARE SHALL BE TAKEN IN PLACING POST- INSTALLED ANCHORS TO AVOID CONFLICT WITH THE EXISTING REBAR. HOLES SHALL BE DRILLED AND CLEANED IN ACCORDANCE WITH THE MANUFACTURER'S WRITTEN INSTRUCTIONS.
- P3. SUBSTITUTION REQUESTS FOR PRODUCTS OTHER THAN THOSE SPECIFIED BELOW, SHALL BE SUBMITTED BY THE CONTRACTOR TO THE OWNER ALONG WITH CALCULATIONS THAT ARE PREPARED AND SEALED BY A REGISTERED PROFESSIONAL ENGINEER. THE CALCULATIONS SHALL DEMONSTRATE THAT THE SUBSTITUTED PRODUCT IS CAPABLE OF ACHIEVING THE PERTINENT EQUIVALENT DESIGN PERFORMANCE VALUES (MINIMUM) OF THE SPECIFIED PRODUCT USING THE APPROPRIATE DESIGN PROCEDURE AND/ OR STANDARDS(S). AS REQUIRED BY THE BUILDING CODE. PRODUCT ICC-ES REPORTS SHALL BE INCLUDED WITH THE SUBMITTAL PACKAGE.
- P4. UNLESS NOTED OTHERWISE ON PLANS, ACCEPTABLE CONCRETE ANCHORS PRODUCTS SHALL BE:
 - A. MECHANICAL ANCHORS FOR USE IN CRACKED AND UNCRACKED CONCRETE SHALL HAVE BEEN TESTED AND QUALIFIED FOR USE IN ACCORDANCE WITH ACI 355.2 AND ICC-ES AC193. PRE-APPROVED MECHANICAL ANCHORS INCLUDE: A.1. KWIK BOLT 3 (ICC-ES ESR-2302) AND KWIK BOLT TZ (ICC-ES ESR 1917) BY HILTI, INC
 - A.2. STRONG BOLT (ICC-ES ESR-1771) AND STRONG BOLT 2 (ICC-ES ESR-3037) BY SIMPSON STRONG TIE ANCHOR B. ADHESIVE ANCHORS FOR USE IN CRACKED AND UNCRACKED CONCRETE SHALL HAVE BEEN TESTED AND QUALIFIED
 - FOR USE IN ACCORDANCE WITH ACI 308. PRE-APPROVED ADHESIVE ANCHORS INCLUDE: B.1. HIT-RE-500 V3 (ICC-ES ESR-3814) SYSTEM ADHESIVE ANCHORS BY HILTI, INC. B.2. SET-XP (ICC-ES ESR-2508) ADHESIVE ANCHORING SYSTEMS BY SIMPSON STRONG TIE ANCHOR SYSTEMS.
 - C. CONCRETE SCREW ANCHORS FOR USE IN CRACKED AND UNCRACKED CONCRETE SHALL HAVE BEEN TESTED AND QUALIFIED FOR USE IN ACCORDANCE WITH ACI 355.2 AND ICC-ES AC193. PRE-APPROVED SCREW ANCHORS INCLUDE. C.1. KWIK HUS-EZ (ICC-ES ESR-3027) BY HILTI, INC.
 - C.2. TITAN HD (ICC-ES ESR-2713) BY SIMPSON STRONG TIE ANCHOR SYSTEMS.

EARTHWORK AND FOUNDATIONS

- EF1. ALL EARTHWORK AND SITE PREPARATION SHALL BE DIRECTED BY THE GEOTECHNICAL ENGINEER. ALL FOUNDATION EXCAVATIONS SHALL BE OBSERVED BY THE GEOTECHNICAL ENGINEER.
- EF2. ANY EXISTING FILLS OR UNSUITABLE SOILS AS DETERMINED BY THE GEOTECHNICAL ENGINEER SHALL BE EXCAVATED AND REPLACED WITH PROPERLY COMPACTED FILL.

EF4. DO NOT EXCAVATE BELOW THE BEARING ELEVATION OF ANY COMPLETED FOOTING NOR ANY CLOSER TO THE FOOTING THAN

- EF3. EXTREME CARE SHALL BE EXERCISED WHEN EXCAVATING OR GRADING ADJACENT TO EXISTING STRUCTURES OR IMPROVEMENTS SO AS NOT TO DAMAGE OR UNDERMINE FOUNDATIONS, WALLS, SLABS, UTILITIES, ETC.
- A SLOPE OF TWO HORIZONTAL (MEASURED FROM EDGE OF FOOTING TO NEAREST POINT IN EXCAVATION) TO ONE VERTICAL. EF5. HORIZONTAL CONSTRUCTION JOINTS IN SLABS ON GRADE AND FOOTINGS ARE NOT PERMITTED.
- EF6. PROVIDE DOWELS FOR ALL WALLS EMBEDDED INTO FOOTINGS. DOWELS SHALL BE THE SAME SIZE AND SPACING AS VERTICAL WALL REINFORCEMENT, UNLESS NOTED OTHERWISE.

DEFERRED SUBMITTALS:

- DS1. DEFERRED SUBMITTALS ARE THOSE PORTIONS OF THE DESIGN WHICH ARE NOT SUBMITTED AT THE TIME OF PERMIT APPLICATION AND WHICH ARE TO BE SUBMITTED TO THE PERMITTING AGENCY FOR ACCEPTANCE PRIOR TO INSTALLATION OF THAT PORTION OF WORK.
- DS2. THE FOLLOWING IS A LIST OF DEFERRED SUBMITTALS PER BUILDING CODE SECTION 107.3.4.2 THAT ARE EXPECTED TO CONTAIN STRUCTURAL CALCULATIONS OR SAFETY RELATED SYSTEM INFORMATION FOR REVIEW TO MEET BUILDING PERMITTING REQUIREMENTS FOR DESIGNED SYSTEMS. PRIOR TO INSTALLATION OF THE INDICATED STRUCTURAL ELEMENT, EQUIPMENT, DISTRIBUTION SYSTEM, OR COMPONENT OR ITS ANCHORAGE, THE CONTRACTOR SHALL SUBMIT THE REQUIRED CALCULATIONS AND SUPPORTING DATA AND DRAWINGS FOR REVIEW AND ACCEPTANCE BY THE ENGINEER. ADDITIONALLY, ACCEPTANCE ON THE ENGINEER'S COMMENT FOR, ALONG WITH THE COMPLETED FINAL SUBMITTAL SHALL THEN BE FILED BY THE CONTRACTOR AND ACKNOWLEDGED AS ACCEPTED BY THE PERMITTING AGENCY PRIOR TO INSTALLATION OF THESE ITEMS.

DEFERRED SUBMITTALS			
SPECIFICATION SECTION	ITEM		
05 50 00	PERFORATED METAL SHADE STRUCTURE PANELS		
OTHER	ANY EQUIPMENT OR COMPONENT IN WHICH A TECHNICAL SPECIFICATION REQUIRES SUBMITTAL OF EQUIPMENT OR ANCHORAGE SYSTEM CALCULATIONS		



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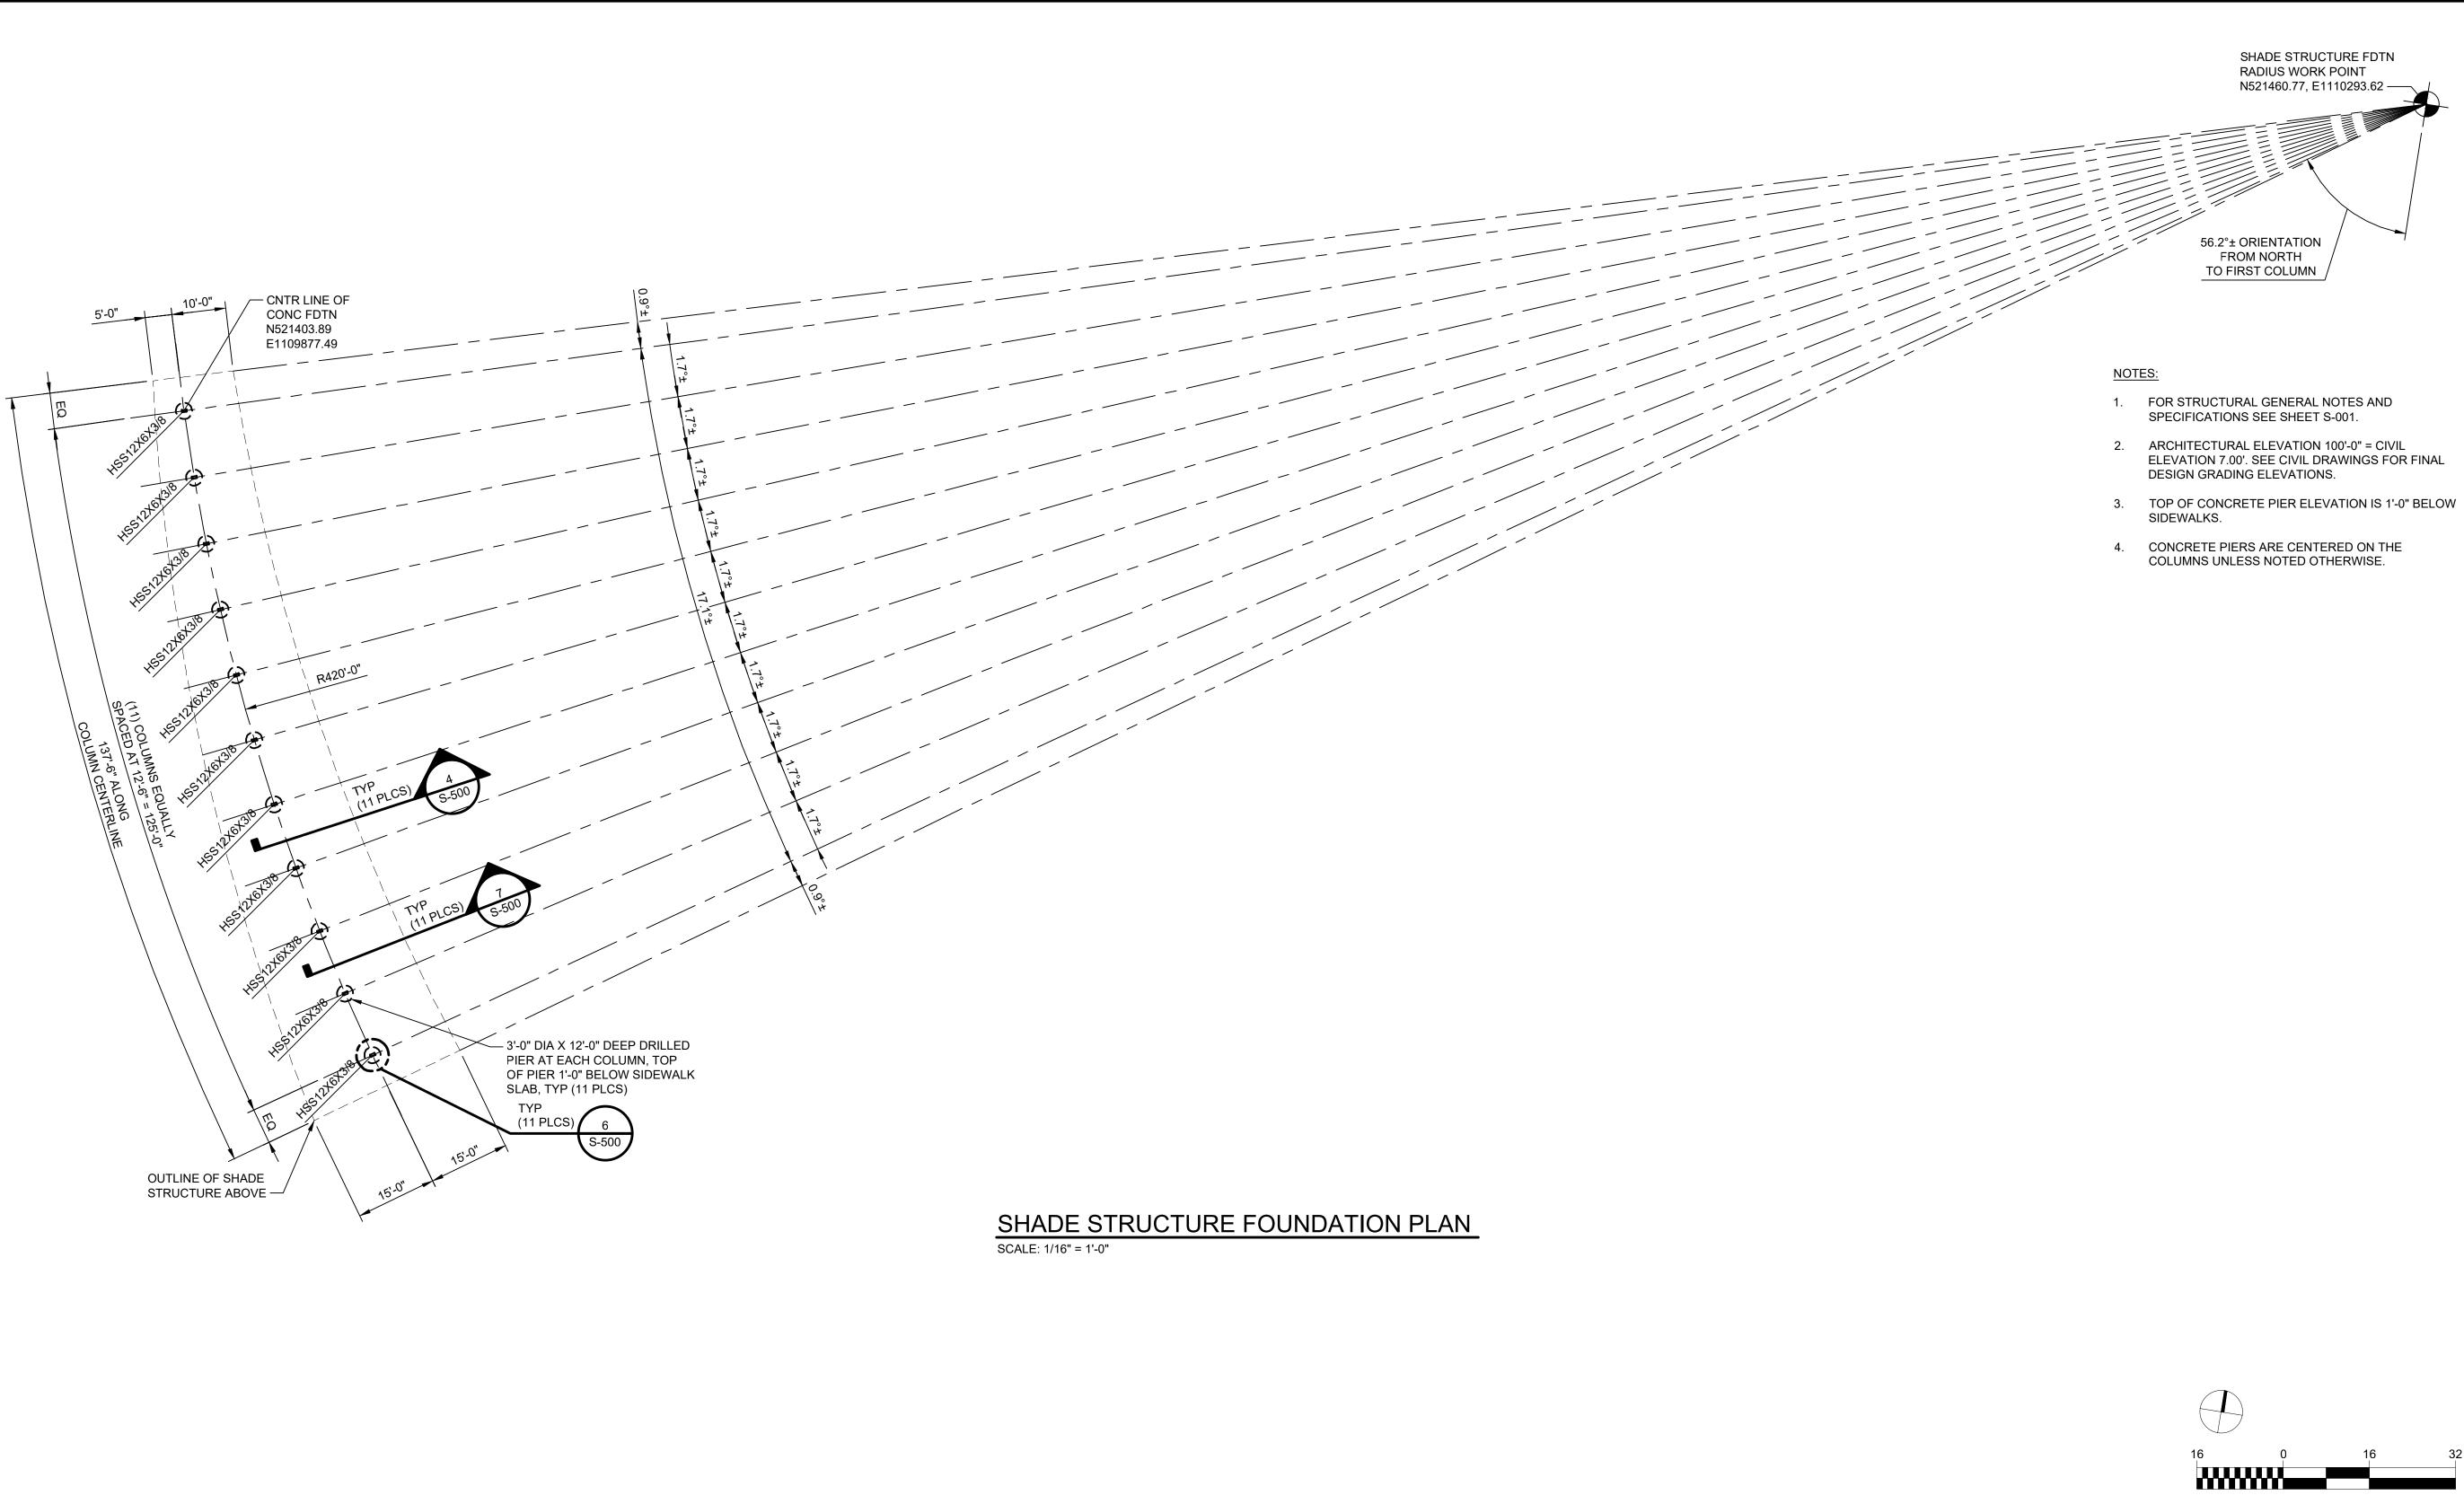
BRUCE BEACH PARK 601 W. Main Street Pensacola, FL 32502

PHASE ONE

DATE DESCRIPTION 2/15/2022 100% PERMIT SUBMITTAL 3/4/2022 DRAFT 100% PERMIT SUBMITTAL 3/11/2022 ISSUE FOR BID

HDR Project Number: 10279441

Sheet Name STRUCTURAL **GENERAL NOTES** AND SPECIFICATIONS



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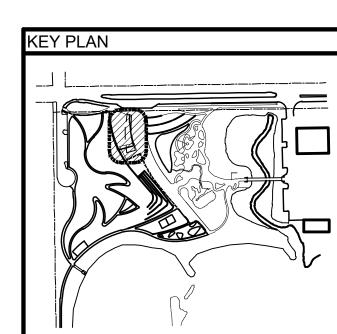


BRUCE BEACH PARK 601 W. Main Street Pensacola, FL 32502

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3/4/2022	DRAFT 100% PERMIT SUBMITTAL
3/11/2022	ISSUE FOR BID


HDR Project Number: 10279441



STRUCTURAL SHADE

STRUCTURE FOUNDATION PLAN

1/16" = 1'-0"

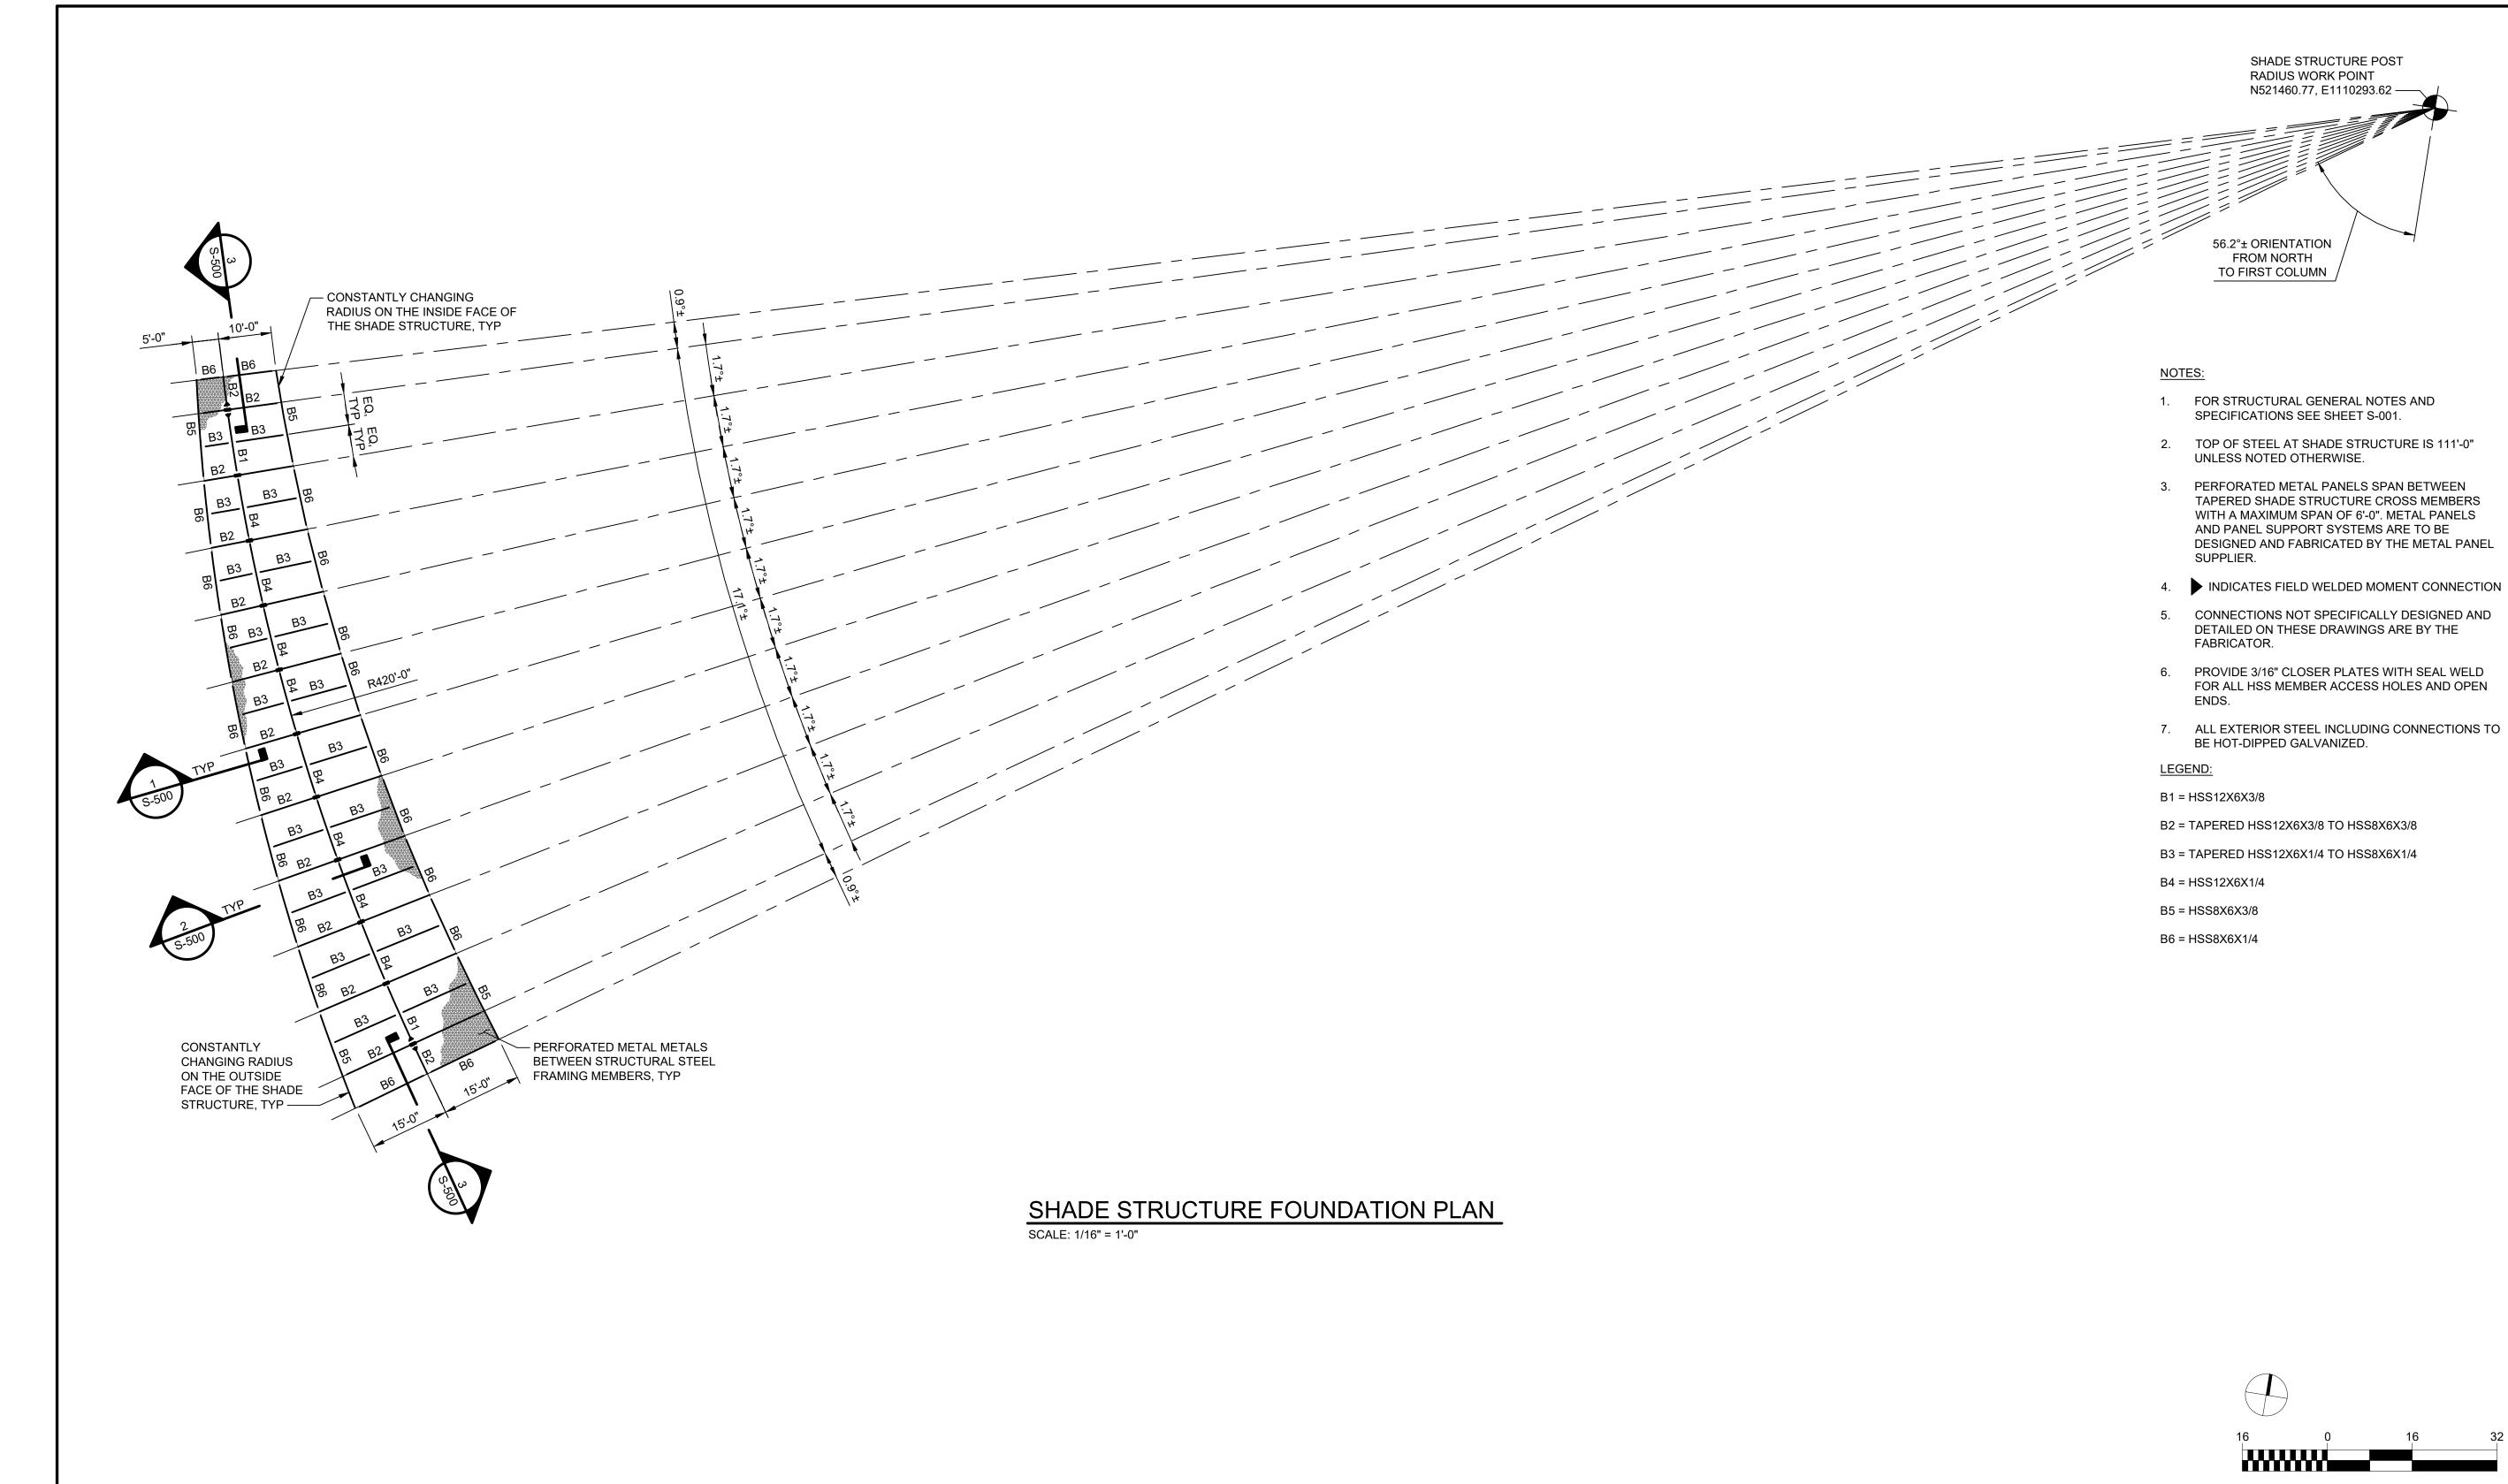




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BRUCE BEACH PARK 601 W. Main Street Pensacola, FL 32502

PHASE ONE




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STRUCTURAL SHADE

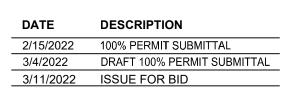
STRUCTURE FRAMING PLAN


1/16" = 1'-0"

KEY PLAN



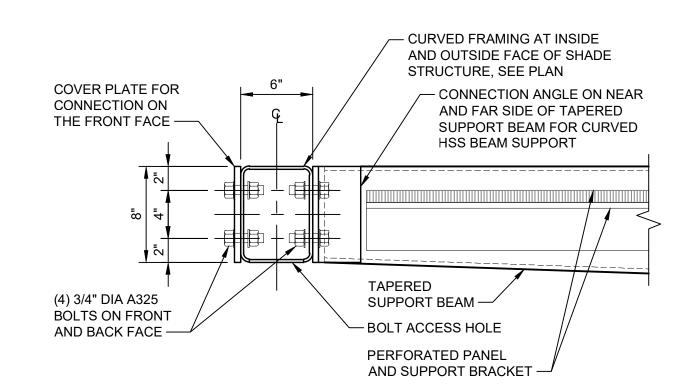

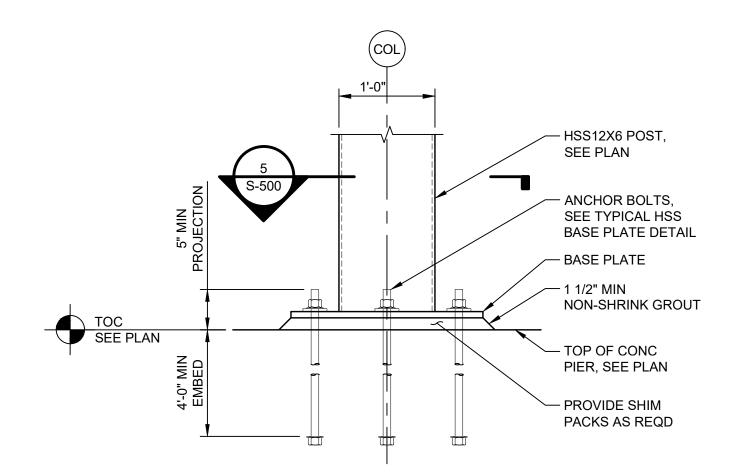


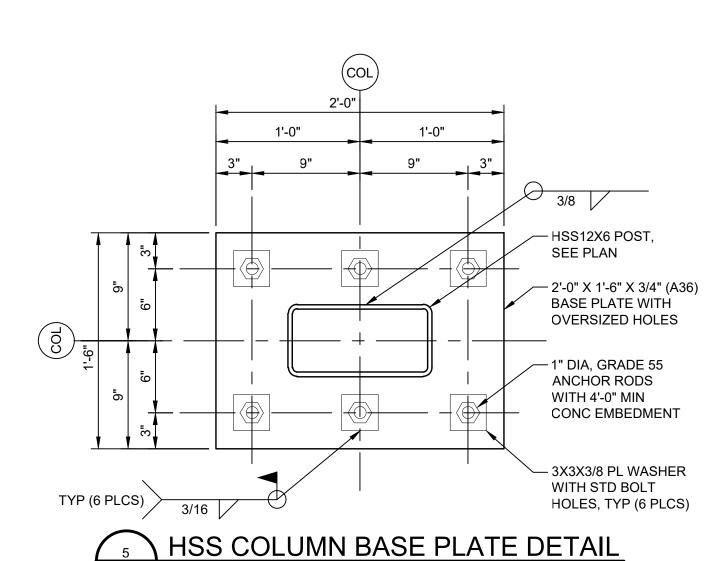


HSS COLUMN ANCHOR BOLT DETAIL


S-100 SCALE: 1" = 1'-0"


SCALE: 1 1/2" = 1'-0"

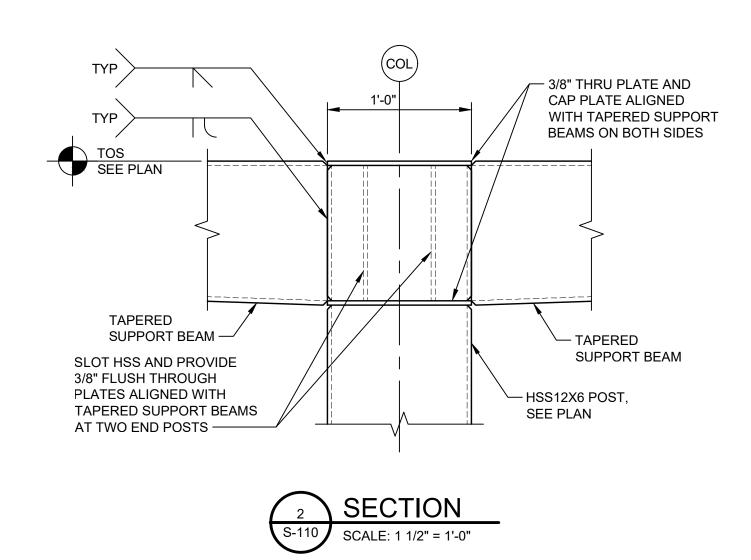

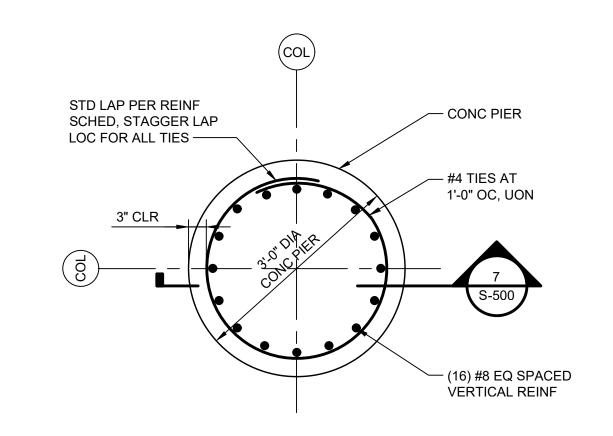



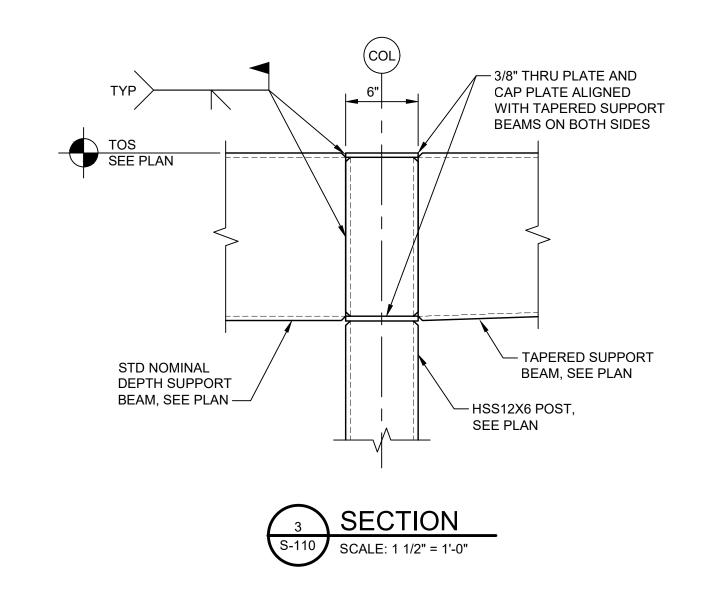

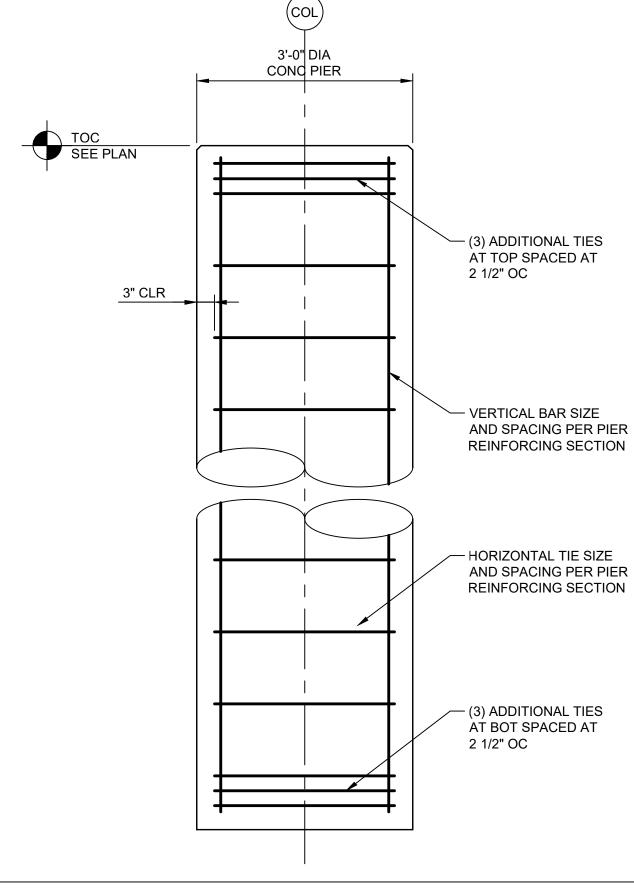

SERVICE LOADS ON TOP OF PIER					
AXIAL LOAD (KIP)	SHEAR ALONG CANOPY (KIP)		MOMENT ABOUT LENGTH (FT-KIP)		TORSIONAL MOMENT (FT-KIP)
38	6	6	48	30	2





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Sheet Name
STRUCTURAL
SECTIONS AND
DETAILS

Scale AS NOTED

Sheet Number